COUNTY OF SANTA CRUZ PLANNING DEPARTMENT 701 Ocean Street, 4th Floor Santa Cruz, CA 95060 (831) 454-2580

NOTICE OF PENDING ACTION

The Planning Department has received the following application. The identified planner may be contacted for specific information on this application.

APPLICATON NUMBER: 191052 APN: 109-171-29

Proposal to construct a new 2250 square foot non-habitable accessory structure with a toilet. Requires a Residential Development Permit for a structure exceeding 1000 square feet.

Property located approximately .5 miles north of the intersection of Casserly Road and Smith Road (142 Smith Rd)

OWNER: John & Rita Wolfe APPLICANT: Joshua Stewman SUPERVISORIAL DISTRICT: 4

PLANNER: Jonathan DiSalvo, (831) 454-3157 EMAIL: Jonathan.DiSalvo@santacruzcounty.us

Public comments must be received by 5:00 p.m. March 13, 2020.

A decision will be made on or shortly after March 16, 2020.

Appeals of the decision will be accepted until 5:00 p.m. two weeks after the decision date. Planner will provide notification of decision to any requesting party.

Information regarding the appeal process, including required fees, may be obtained by phoning (831) 454-2130.



Application #: 191052

Proposal to construct a 2,250 square foot non-habitable accesory structure with a toilet. Requires a Residential Development Permit

Property located approximately .5 miles north of the intersection of Casserly Road and Smith Road (142 Smith Rd)

APN 109-171-29

FOR FURTHER INFORMATION CONTACT:

APPLICANT:

JOSHUA STEWMAN P.O. BOX 7012 SALINAS, CA 93950 (831) 424-1647

JOSHUA@HOMELIFEDESIGNSTUDIO.COM

PROJECT PLANNER:

JONATHAN DISALVO

701 OCEAN STREET, 4TH FLOOR

SANTA CRUZ, CA 95060

(831) 454-3157

JONATHAN.DISALVO@SANTACRUZCOUNTY.US



COUNTY OF SANTA CRUZ NOTICE OF PROPOSED DEVELOPMENT SIGN INSTALLATION CERTIFICATE

Application Number: 777032 L			
Assessor's Parcel number (APN):			
Site Address: 142 Smith F	RD WATS	ONVILLE	95076
	* *		
Attach here a legible photo of sign	installed on site. I	Photo shall indica	te location.
	a		
I hereby testify that the sign installed fully County Code Section 18.10.224, that the si that it will be removed when required by Se	gn will be maintai ection 18.10.22.	ned for the requ	
Applicant's Name (please print):	gan Wash	r-ci-	
Applicant's Name (please print):)off		<u> </u>
Date: FEB 10 2020			
When the sign has been placed, complete this planner,Cruz, Planning Department, 701 Ocean Stree			Santa
Failure to post the site as required is groun			

WOLFE STORAGE BUILDING

GENERAL NOTES

1. CONTRACTOR LICENSE: THE CONTRACTOR(S) PERFORMING THE WORK
DESCRIBED BY THESE PLANS AND SPECIFICATIONS SHALL RE PROPERLY AND ENTLY LICENSED DURING THE EXECUTION OF THE PROJECT AND SHALL ERFORM WORK OUTSIDE THE LEGAL SCOPE OF ANY LICENSE

- 2. SCOPE: THE CONTRACTOR SHALL PROVIDE AND PAY FOR ALL LABOR, MATERIALS, TOOLS, EQUIPMENT AND MACHINERY, TRANSPORTATION, WATER, HEAT, ELECTRICAL, TELEPHONE, AND ANY OTHER RELATED ITEMS NECESSARY FOR THE PROPER EXECUTION AND TIMELY COMPLETION OF THE
- QUALITY CONTROL. IT IS THE EXPRESS INTENTION OF THESE PLANS AND SPECIFICATIONS TO REQUIRE A HIGH STANDARD OF WORK. IF, IN THE ORINION OF THE CONTRACTOR, ANY PORTION OF THE DOCUMENTATION HEREIN IS NICONSISTENT WITH THIS, THE ARCHITECT SHALL BE NOTHED PRIOR TO DESCUTING THE WORK AND ALLOWED REVISION THEIR IF FELT.
- 4. WARRANTY: THE CONTRACTOR WARRANTS TO THE OWNER THAT ALL MATERIALS AND EQUIPMENT FURNISHED UNDER THIS CONTRACT WILL BE NOW UNLESS OTHERWISE SPECIFICA, MOD THAT ALL WORK WILL BE OF GOOD QUALITY, PREE FROM FAULTS AND DEFECTS, AND IN CONFORMANCE WITH THE CONTRACT DRAWNINGS AND SPECIFICATIONS.
- 5 PERMITS: UNLESS OTHERWISE INSTRUCTED, THE OWNER SHALL PAY ALL PERMIT FEES INCLUDING UTILITIES. THE CONTRACTOR SHALL SECURE THE BULLDUS PERMIT AND ANY OTHER PERMITS PRIOR TO STARTING THE WORK AND COMPLY WITH ALL INSPECTION REQUIREMENTS THROUGH FINAL
- 6. LEGALANDTICES/CODE COMPLANCE: THE CONTRACTOR SHALL GIVE ALL NOTICES AND COMPLY WITH ALL LAWS, ORDINANCES, BUILDING CODES, ALL NOTICES AND COMPLY WITH ALL LAWS, ORDINANCES, BUILDING CODES, ALL PROPERTY HAS A LAW OF THE PERFORMANCE OF THE WORK. THE CONTRACTOR SHALL PROMPTLY NOTIFY THE ARCHITECT IN WRITING IF THE CONTRACTOR SHALL PROMPTLY NOTIFY THE ARCHITECT IN WRITING IT THE RECURRENETS THE CONTRACTOR SHALL OPERATE TO BEST MANAGEMENT PROMCTICES.
- 7. RESPONSIBILITY: THE CONTRACTOR SHALL BE SOLELY RESPONSIBLE FOR ALL CONSTRUCTION MEANS, METHODS, TECHNIQUES, SEQUENCES AND PROCEDURES SELECTED TO EXECUTE THE WORK THE CONTRACTOR SHALL COORDINATE ALL PORTIONS OF WORK WITHIN THE SCOPE OF THE
- SAFETY: THE CONTRACTOR SHALL BE RESPONSIBLE FOR INITIATING MAINTAINING & PROPERLY SUPERVISING ADEQUATE INDUSTRY STANDARD SAFETY PRECAUTIONS AND PROGRAMS IN CONNECTION WITH THIS WORK.
- 9 INSURANCE: LIABILITY INSURANCE SHALL BE MANTAINED BY THE CONTRACTOR TO PROTECT AGAINST ALL CLAMS LUDGE WORKMAN'S COMMERCATION, FOR SOME AND LINE OF BOOK INJURY MOUNT GOOD GEATH, THE CONTRACTOR SOME AND LINE OF BOOK INJURY MOUNT GOOD THE CONTRACTOR OF SOME AND LINE OF THE CONTRACTOR OF SOME AND LINE OF THE CONTRACTOR OF SOME AND LINE OF THE CONTRACTOR OF THE CONTRACTOR
- 10. CLEAN UP: THE CONTRACTOR SHALL KEEP THE PREMISES AND SITE FREE FROM ACCUMULATION OF WASTE MATERIALS DURING CONSTRUCTION BY PERIODIC CLEAN UP AND OFF.SITE DEBRIS REMOVAL FINAL CLEANUP AND DEBRIS DISPOSITION SHALL BE TO THE SATISFACTION OF THE OWNER
- 11. CONTRACTOR SHALL VISIT THE SITE AND VERIFY ALL EXISTING CONDITIONS PRIOR TO ANY WORK AND NOTIFY THE ARCHITECT OF ANY DISCREPANCIES BETWEEN THESE DRAWINGS AND EXISTING CONDITIONS AFFECTING THE WORK OR NATURE OF SPECIFIED MATERIALS AND/OR SCOPE OF DESIGN
- 12 ALL NOTES, DIMENSIONS, ETC. INDICATE NEW MATERIALS OR CONSTRUCTION UNLESS OTHERWISE NOTED.
- 13. BUILDING CODES: ALL CONSTRUCTION SHALL MEET THE REQUIREMENTS OF THE CALIFORNIA. BUILDING CODE (C.B.C), 2017 CA-BLDG, MECH, PLUMBING, CFC, 2017 CA ELEC AND 2017 CALIFORNIA ENERGY CODE AND ANY AMENDMENTS OF PRESIDING CITY OR COUNTY
- 14. NO LAND CLEARING OR GRADING SHALL OCCUR ON THE PROPERTY BETWEEN OCTOBER 15 AND APRIL 15 UNLESS AUTHORIZED BY THE DIRECTOR OF PLANNING AND BUILDING INSPECTION.
- ALL CUT AND/OR FILL OF SLOPES EXPOSED DURING THE COURSE CONSTRUCTION SHALL BE COVERED, SEEDED WITH NATIVE GRASSES O OTHERWISE TREATED TO CONTROL EROSION.
- 18. SHOP DRAWINGS: PRIOR TO FABRICATION, THE CONTRACTOR SHALL SUBMITTO THE ENGINEER FOR APPROVAL SHOP DRAWINGS FOR ALL STRUCTURAL STEE, REPROPCIOUS STEEL, QUIEL LAMINATED DEAMS AND PREFABRICATED TRUSSES: SHOP DRAWINGS ARE NOT CHANGE ORDERS. BUT PRIVATE TO DEMONSTRATE TO THE ENGINEER THAT THE CONTRACTOR INVERSITANCES THE REQUIREMENTS & DESIGN CONCEPTS OF THE PLAN. DETAILS A SPECIPICATION.
- CHANGE ORDERS: NO VERBAL CHANGE ORDERS SHALL BECOME LEGAL AND/OR BINDING.
- CONSTRUCTION, BRACING & SHORING: THE CONTRACTOR SHALL BE SOLELY RESPONSIBLE FOR ALL BRACING AND SHORING REQUIRED DURING CONSTRUCTION UNTIL ALL CONSTRUCTION IS COMPLETE.

FRONT PERSPECTIVE

PROJECT TEAM

JOHN WOLFE 142 SMITH RD.

CONTRACTOR: SSB CONSTRUCTION

STRUCTURAL: PACIFIC ENGINEERING GROUP

30 RYAN CT. MONTEREY, CA 93940

(831) 333-0644

C3 ENGINEERING

JENNIFER RUDOLPH 126 BONIFACIO PLACE - SUITE C

THE APPROVAL OF THESE PLANS AND SPECIFICATIONS DOES NOT PERMIT THE VIOLATION OF ANY SECTION OF THE BUILDING CODE, MUNICIPAL ORDINANCES, OR STATE LAWS.

THESE PLANS AND RELATED DOCUMENTS MUST BE AVAILABLE AT THE JOB SITE DURING ANY INSPECTION ACTIVITY.

3. DEFERRED SUBMITTAL FOR TANK/HYDRANT AND FIRE SPRINKLER

4. THE JOB COPIES OF THE BUILDING AND FIRE SYSTEMS MUST BE

5. AS A CONDITION OF SUBMITTAL OF THESE PLANS, THE SUBMITTER

COMPLIANCE WITH APPLICABLE SPECIFICATION, STANDARDS, CODES, AND ORDINANCES, AND FURTHER AGREE TO CORRECT ANY
DEFICIENCIES NOTED BY THIS REVIEW, SUBSEQUENT REVIEW,
INSPECTION, OR OTHER SOURCE, AND, TO HOLD HARMLESS AND

WITHOUT PREJUDICE, THE REVIEWER AND THE REVIEWING AGENCY.

DESIGNER, AND INSTALLER CERTIFY THAT PLANS AND DETAILS COMPLY WITH APPLICABLE SPECIFICATIONS, STANDARDS, CODES, AND ORDINANCES, AGREES THAT THEY ARE SOLELY RESPONSIBLE FOR

WATSONVILLE, CA 95076

SPRECKELS, CA 93962

STEPHEN W. GOLDMAN 1161 TERVEN AVE. SALINAS, CA 93901 (831) 424-1647

HOMELIFE DESIGN STUDIO - JOSHUA STEWMAN

(831) 920-8814 - joshua@homelifedesignstudio.com

OWNERS:

ENGINEER

ENGINEER

GENERAL NOTES:

ON-SITE DURING INSPECTIONS.



DRAWING INDEX ARCHITECTURAL

A-0.1	PROJECT TITLE PAGE
A-0.2	COLOR MATERIAL SAMPLES
A-0.3	FIRE NOTES
T-1	TOPOGRAPHY SITE PLAN
T-2	TOPOGRAPHY SITE PLAN
A-1.1	PROPOSED SITE PLAN
A-1.2	PROPOSED SECTION & PROPOSED ROOF/DRAINAGE PLAN
A-1.3	BEST MANAGEMENT PRACTICES
A-2.0	PROPOSED FLOOR PLAN
CMP	CONSTRUCTION MANAGEMENT DI ANIEDOSION CONTROL DI ANI

SAND CREEK DOST & DEAM

1 COVER SHEET	SHIND	CREEK FOST & BEAIN
	1	COVER SHEET
2 EXTERIOR ELEVATIONS	2	
3 EXTERIOR ELEVATIONS	3	EXTERIOR ELEVATIONS
4 BUILDING SECTION & WALL PLAN DETAIL	4	BUILDING SECTION & WALL PLAN DETAIL
5 MAIN FLOOR PLAN	5	MAIN FLOOR PLAN
6 LOFT FLOOR PLAN	6	

FIRE DEPT NOTES

1. THESE PLANS ARE IN COMPLIANCE WITH CALIFORNIA BUILDING AND FIRE CODES (2016 EDITION) AND PAJARO VALLEY FIRE PROTECTION DISTRICT

ALL BUILDING SHALL BE PROTECTED BY AN APPROVED AUTOMATIC FIRE SPRINKLER SYSTEM COMPLYING WITH THE CURRENTLY ADOPTED EDITION OF NFPA 13 D, AND ADOPTED STANDARDS OF THE PAJARO VALLEY FIRE

THE DESIGNER/INSTALLER SHALL SUBMIT (3) SETS OF PLANS AND CALCULATIONS FOR THE UNDERGROUND AND OVERHEAD RESIDENTIAL AUTOMATIC FIRE SPRINKLER SYSTEM TO THIS AGENCY FOR APPROVAL.

AN UNDERGROUND FIRE PROTECTION SYSTEM WORKING DRAWING MUST BE PREPARED BY THE DESIGNER/INSTALLER. THE PLANS SHALL
COMPLY WITH THE UNDERGROUND FIRE PROTECTION SYSTEM INSTALLATION POLICY HANDOUT, UNDERGROUND PLAN SUBMITTAL AND PERMIT, WILL BE ISSUED TO A CLASS B, CLASS C-16, CLASS C-36
OR OWNER BUILDER: NO EXCEPTIONS.

5. A 100-FOOT CLEARANCE SHALL BE MAINTAINED AROUND AND ADJACENT TO THE BUILDING OR STRUCTURE TO PROVIDE ADDITIONAL FIRE PROTECTION OR FIRE BREAK BY REMOVING ALL BRUSH, FLAMMABLE VEGETATION, OR

EXCEPTION: SINGLE SPECIMENS OF TREES, ORNAMENTAL SHRUBBERY OR SIMILAR PLANTS USED AS GROUND COVERS, PROVIDED THEY DO NOT FORM A MEANS OF RAPIDLY TRANSMITTING FIRE FROM NATIVE GROWTH TO ANY

6. ADDITIONAL NOTES - SEE A-0.3

SITE MAP



PROJECT DATA

ADDRESS	WATSONVILLE, CA 950	76				
ASSESSOR'S PARCEL#:	109-171-029					
ZONING:	A					
GENERAL DESIGNATION:	R-M					
TYPE OF CONSTRUCTION:	V-B					
FIRE SPRINKLED:	YES, TO BE INSTALLED NFPA 13 D, AND ADOP DISTRICT.	COMPLYING WIT TED STANDARDS	TH CURRENTLY ADOPTED OF THE PAJARO VALLEY	EDITION OF FIRE PROTECT		
LOT SIZE:	15.016 ACRES = 654,10	8 SQFT				
BUILDING SQFT:	(E) HOUSE = 2,876 SC	(FT	(P) STORAGE BUILDING = 1,853 SQFT			
LOT COVERAGE (SQFT):	10,564 / 654,108	= 1.6 %				
BUILDING COVERAGE:	EXISTING COVERAGE		PROPOSED COVERAGE			
	(E) HOUSE = (E) POOL & PATIO = (E) DRIVEWAY =	2,876 SQFT 4,934 SQFT 504 SQFT	(E) HOUSE = (E) POOL & PATIO = (E) DRIVEWAY = (P) STORAGE BLDG. = (P) LANDINGS =	504 SQFT		
	(E) TOTAL =	8,314 SQFT	(P) TOTAL = *1,906 SQFT OF NEW I			
GRADING ESTIMATE: CUT: 0 CY / FILL:0 CY						

PROJECT DESCRIPTION

THIS PROJECT WILL INCLUDE THE INSTALLATION OF A NEW 1.853 SOFT PREMANUFACTURED STORAGE BUILDING

CODE COMPLIANCE

2016 CALIFORNIA RESIDENTIAL CODE (CRC) AND 2016 CALIFORNIA GREEN BUILDING STANDARDS CODE, AND 2016 CALIFORNIA MECHANICAL, PLUMBING, ELECTRICAL, CFC, & 2016 CALIFORNIA ENERGY CODE

STUDIO

DESIGN

HOMELIFE

RESIDENTIAL DESIGN LEED AP (831) 920-8814

HOMELIFE

JOHN WOLFE STORAGE BUILDING

142 SMITH RD. WATSONVILLE, CA 95076

APN: 109-171-29 PROJECT NO:

JOHN WOLFE 142 SMITH RD WATSONVILLE, CA 95076

SHEET TITLE:

PROJECT TITLE PAGE

SCALE

DRAWN BY: TOM STEWMAN PLANNING PERMIT SURMITTAL DATE: BUILDING PERMIT SUBMITTAL DATE: DATE ISSUED FOR CONSTRUCTION:

A PLANNING RESPONSES 5/22/2019

SHEET NUMBER

SHEET 1 OF




















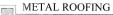



EXTERIOR SIDING

HOMELIFE DESIGN STUDIO

HOMELIFE DESIGN STUDIO

RESIGNAL PESIGN - LEED A PROCESSAL - LEED

PROJECT:

JOHN WOLFE STORAGE BUILDING

142 SMITH ROAD WATSONVILLE, CA 95076

APN: 109-171-29 PROJECT NO;

OWNER:

JOHN WOLFE 142 SMITH ROAD WATSONVILLE, CA 95076

SHEET TITLE:
COLOR MATERIAL
SAMPLES

SCALE:

DRAWN BY: TB

PRINT DATE: OCTOBER 31, 2019
PLANNING PERMIT SUBMITTAL DATE
BUILDING PERMIT SUBMITTAL DATE:

DATE ISSUED FOR CONSTRUCTION:



FILE:

Use of literal drawings and specifications is rectricted to the original project shifter which they were intrinded. The rule or reproduction by any method, in whole or in part, is problemed Visual council with these determines and specifications shall constitute prima time evidence of the acceptance of these restrictions.

SHEET NUMBER:

A-0.2

SHEET

OF _____ SH

TEL 837 - 920 - 8914 • PACIFIC GROVE, CALIFORNIA 93950 FEL 837 - 920 - 8914 • poshua@homesfedasgrotusto.com

FIRE DEPARTMENT NOTES:

ADDITIONAL NOTES & FIRE DEPARTMENT NOTES

FIRE DEPARTMENT NOTES:

- 1. ALL BUILDINGS SHALL HAVE A PERMANENTLY POSTED ADDRESS WHICH SHALL BE PLACED AT EACH DRIVEWAY ENTRANCE AND VISIBLE FROM BOTH DIRECTIONS OF TRACE, LONG THE ROOD, IN ALL CASES, WHICH SHALL BE PLACED AT EACH DRIVEWAY ENTRACK AND VISIBLE.

 FROM BOTH DIRECTIONS OF TRACE, LONG THE ROOD. IN ALL CASES, THE ADDRESS SHALL BE PROMED TO RECRIMINE OF CONSTRUCTION AND SHALL BE MAINTAINED THEREAFTER AND THE ADDRESS SHALL BE VISIBLE AND LEGIBLE FROM THE ROAD ON WHICH THE ADDRESS IS LOCATED.
- 2. SIZE OF LETTERS, NUMBERS, AND SYMBOLS FOR ADDRESS SHALL BE A MINIMUM OF 3° LETTER HEIGHT. X° STROKE, CONTRASTING WITH THE BACKGROUND COLOR OF THE SIGN.

 3. UNDBSTRUCTED VERTICLE CLEARANCE SHALL NOT BE LESS THAN 15 FOR ALL ACCESS ROADS. ACCESS DRIVEWAYS SHALL BE AN ALL
- WAS THER DRIVING SURFACE CAPABLE OF SUPPORTING 22 DORS, NOT EAST THAN E FOR INMOSTRACTED WORTH, AND A MAX, I SO "GROOK
 A, ALE FLAMASHED VEGETATION FOR OTHER COMBINISHED, GOOWITH SHALL AN ALL THIMS SMANLAN LEAR DISTANCE OF NOT LESS THAN
 30 ON EACH SIDE FROM STRUCTURE OR BUILDINGS. THIS SHALL NOT APPLY TO SINGLE SPECIMENS OF TEELS, SHUBBREY OR SMALLAR
 FLAMTS SUEDA GOOGNOTO, COVERS PROVIDED THAT THEY ON DOT FORM A MEANS OF FARIBLY TRANSSISTITION, FIRE FROM THE NATURE

 OF THE STATE OF THE STRUCTURE OF THE STRUCTURE

FIRE 007 - DRIVEWAYS:

DRIVEWAYS SHALL NOT BE LESS THAN 12' WIDE UNOBSTRUCTED, WITH AN DIVENDESTRUCTED THE GRADE SHARM IT? WIDE UNDISSIRUCTED, WITH AN UNDISSIRUCTED, WITH AN UNDISSIRUCTED, WITH GRADE FOR ALL DRIVEWAYS SHALL NOT EXCEED 15%. WHERE OF THE GRADE FOR ALL DRIVEWAYS SHALL NOT EXCEED 15%. WHERE OF 1.17 OF A SPHALL TUCKED 15% ALL DRIVEWAYS STRUCTURAL ROADWAY SURFACE FOR 1.17 OF A SPHALL TUCKED 15%. ALL DRIVEWAYS THE CONTROL OF SHARM SHALL BE REQUIRED. THE DRIVEWAY SHARM SHALL BE REQUIRED. THE DRIVEWAY SHARM SHAR SURFARATUS (2.2 DAS). AND EVEN SUPPLIES OF DRIVEWAY TURNS, AN ADDITIONAL SURFACE OF 4'SHALL BE ADDED, ALL DRIVEWAYS EXCEEDING 150'3N LENGTH, BUT LESS THAN 860' IN LENGTH, SHALL PROVIDE A TURNOUT NEAR THE MIDPOINT OF THE DRIVEWAY. WHERE THE DRIVEWAY EXCEEDS 800', TURNOUTS SHALL BE PROVIDED AT NO GREATER THE DRIVEWAY EXCEEDS 800°, TURNOUTS SHALL BE PROVIDED AT NO GREATE THAN 400° INTERVALS. TURNOUTS SHALL BE A MINIMUM OF 12° UNDE AND 30° LONG WITH A MINIMUM OF 25° TAFER AT BOTH ENDS. TURNAROUNDS SHALL BE REQUIRED ON DRIVEWAYS IN SIN EXCESS OF 180° OF SURFACE LENGTH AND SHALL HAVE A MINIMUM 25° TAFER AT BOTH ENDS. TURNAROUNDS SHALL BE REQUIRED ON DRIVEWAYS IN EXCESS OF 180° OF SURFACE LENGTH AND SHALL BE LOCATED WITHIN 50° OF THE RINARY BUILDING. THE MINIMUM TURNING RADIUS FOR A TURNAROUND SHALL BE 40° FROM THE CENTER TURN OF THE DRIVEWAY. IF A HAMMERHEAD "T' IS USED. THE TOP OF THE "T' SHALL BE A MINIMUM OF 06° IN LENGTH.

FIRE 008 - GATES:

ALL GATES PROVIDING ACCESS FROM THE ROAD TO A DRIVEWAY SHALL BE LOCATED AT LEAST 30° FROM THE ROADWAY AND SHALL BE OPEN TO ALLOW A VEHICLE TO STOP WITHOUT CBSTRUCTING TRAFFIC ON THE ROAD. GATE ENTRANCES SHALL BE AT LEAST THE WIDTH OF THE TRAFFIC LANE, BUT IN NO CASE LESS THAN 12' WIDE. WHERE A ONE-WAY ROAD WITH A SINGLE TRAFFIC LANE PROVIDES ACCESS TO A GATED ENTRANCE, A 40' TURNING RADIUS SHALL BE USED. WHERE GATES ARE TO BE LOCKED. THE INSTALLATION OF A KEY BOX OR OTHER ACCESTRABLE MEANS FOR IMMEDIATE ACCESS BY EMERGENCY

FIRE 008 - GATES:

ALL BUILDINGS SHALL BE ISSUED AN ADDRESS IN ACCORDANCE WITH SANTA ALL BULDINGS HALLA LE ISSUED AN ADDRESS IN A ACCORDANCE SCREET HACKSORY ACCORDANCE ACCURATION, SOUTHWAY AND ADDRESS AND ACCORDANCE SCREET ACCESSORY BUILDINGS SOUTHWAY ITS OWN PERMANENTLY POSTED ADDRESS. WHEN BUILDINGS SCALE HAVE ITS OWN PERMANENTLY POSTED ADDRESS. WHEN DICTIVE SCALE ADDRESS AND ADDRESS AN LETTERS, NUMBERS AND SYMBOLS FOR A DDRESSISS SHALL BE: A MINIMUM OF
4"HEIGHT, "FTROKE. CONTRASTING WITH THE BACKGROUND COLOR OF THE
SIGN, AND SHALL BE ARABIC. THE SIGN AND NUMBERS SHALL BE REFLECTIVE.
AND MADE OF NONCOMBUSTIBLE MATERIAL. ADDRESS SIGNS SHALL BE
PLACED AT EACH DRIVEWAY ENTRANCE AND AT EACH DRIVEWAY SPLIT.
ADDRESS SIGNS SHALL BE VISIBLE FROM BOTH DIRECTIONS OF TRAVEL ALONG
THE ROAD. IN ALL CASIS, THE ADDRESS SHALL BE POSTED AT THE BEGINNING
OF CONSTRUCTION AND SHALL BE MAINTAINED THEREASTER. ADDRESS SIGNS. OF CONSTRUCTION AND SHALL BE MAINTAINED THEREAFTER. ADDRESS SIGNS ALONG ONE-WAY ROADS SHALL BE WISIBLE FROM BOTH DIRECTIONS OF TRAVEL. WHERE MY ROADS SHALL BE WISIBLE FROM BOTH DIRECTIONS OF TRAVEL. WHERE MY SHALL BE MOUNTED ON A SINGLE SIGN. WHERE A CONTROL OF THE SHALL BE MOUNTED ON A SINGLE SIGN. WHERE A CONTROL OF THE SHALL BE ADDRESS ACCESS SOLIELY OF A SINGLE COMMERCIAL OCCUPANCY, THE ADDRESS ROSH SHALL BE HEALED AT THE HEARTST ROAD INTERSECTION PROVIDED PROVIDED FROM SHALL BE FRAIL CLEAR ADDRESS NUMBERS SHALL BE POSTED PRIOR OF COST OF QUESTION FIRST. CLEAR ADDRESS NUMBERS SHALL BE

FIRE 021 - FIRE PROTECTION EQUIPMENT & SYSTEMS -FIRE SPRINKLER SYSTEM (STANDARD):

THE BUILDING(S) AND ATTACHED GARAGE(S) SHALL BE FULLY PROTECTED WITH AUTOMATIC FIRE SPRINKLER SYSTEMS(S). INSTALLATION SHALL BE IN ACCORDANCE WITH THE APPLICABLE NFPA STANDARD. A MINIMUM OF (4) SETS OF PLANS FOR FIRE SPRINKLER SYSTEMS MUST BE SUBMITTED BY A CALIFORNIA LICENSED C-16 CONTRACTOR AND APPROVED PRIOR TO INSTALLATION. THIS REQUIREMENT IS NOT INTENDED TO DELAY ISSUANCE OF A BUILDING PERMIT. A ROUGH SPRINKLER INSPECTION MUST BE SCHEDULED BY THE INSTALLING CONTRACTOR AND COMPLETED PRIOR TO REQUESTING A FRAMING INSPECTION.

ACCESS ROAD / DRIVING REQUIREMENTS

THE ACCESS ROAD SHALL BE AN "ALL WEATHER" SURFACE.. "ALL WEATHER" SURFACE IS DEFINED AS A MINIMUM OF 6" OF COMPACTED AGGREGATE BASE ROCK, CLASS II OR EQUIVALENT, AND CERTIFIED IN WRITING BY A LICENSED ENGINEER TO 95% COMPACTION FOR GRADES UP TO AND INCLUDING 5%. FOR GRADES IN EXCESS OF 5% BUT NOT EXCEEDING 15%, OIL AND SCREEDS SHALL BE APPLIED TO A MINIMUM OF 6" OF COMPACTED AGGREGATE BASE ROCK. CLASS II OR EQUIVALENT, AND CERTIFIED IN WRITING BY A LICENSED ENGINEER TO 95% COMPACTION, FOR GRADES EXCEEDING 15%, 2" OF ASPHALTIC CONCRETE SHALL BE APPLIED OVER A MINIMUM OF 6" OF COMPACTED AGGREGATE BASE ROCK, CLASS II OR EQUIVALENT, AND CERTIFIED IN WRITING BY A LICENSED ENGINEER TO 95% COMPACTION

THE MAXIMUM GRADE OF THE ACCESS ROAD SHALL NOT EXCEED 20%, WITH GRADES GREATER THAN 15% NOT PERMITTED FOR DISTANCES OF MORE THAN

THE ACCESS ROAD SHALL HAVE A VERTICAL CLEARANCE OF 13'-6" FOR ITS

AN APPROVED TURN-A-ROUND SHALL BE PROVIDED FOR ACCESS ROADS AND DRIVEWAYS IN EXCESS OF 150 FEET IN LENGTH.

DRAINAGE DETAILS FOR THE ROAD OR DRIVEWAY SHALL CONFORM TO CURRENT ENGINEERING STANDARDS, INCLUDING EROSION CONTROL MEASURES

ALL PRIVATE ACCESS ROADS, DRIVEWAYS, TURN-A-ROLINDS, AND BRIDGES ARE THE RESPONSIBILITY OF THE OWNER(S) OF RECORD AND SHALL BE MAINTAINED TO ENSURE THE FIRE DEPARTMENT SAFE AND EXPEDIENT PASSAGE AT ALL

THE DRIVEWAY SHALL BE THEREAFTER MAINTAINED TO THESE STANDARDS AT ALL TIMES.

CULTURAL RESOURCES - ARCHAEOLOGICAL

STOP WORK WITHIN 50 METERS (165 FT.) OF UNCOVERED RESOURCES AND CONTACT THE SANTA CRUZ COUNTY PLANNING DEPARTMENT AND A QUALIFIED ARCHAEOLOGIST IMMEDIATELY IF CULTURAL, ARCHAEOLOGICAL, HISTORICAL, OR PALEONTOLOGICAL RESOURCES ARE UNCOVERED.

GEOTECHNICAL NOTE

GRADING SHALL CONFORM TO ALL RECOMMENDATIONS PREPARED IN THE GEOTECHNICAL INVESTIGATION PREPARED FOR THIS SITE, PRIOR TO THE CONTRACTOR REQUESTING A FOUNDATION INSPECTION, THE SOILS ENGINEER SHALL ADVISE THE BUILDING OFFICIAL THAT: 1) THE BUILDING FOOTING EXCAVATIONS AND BUILDING PAD WERE PREPARED IN ACCORDANCE WITH THE SOIL REPORT RECOMMENDATIONS. 2) THE FOUNDATION FORMING AND GRADING COMPLY WITH THE SOIL REPORT AND APPROVED PLANS. 3) DRAINAGE SYSTEM IS IN ACCORDANCE WITH THE SOIL REPORT.



JOHN WOLFE STORAGE BARN

142 SMITH RD. WATSONVILLE, CA 95076

APN: 109-171-29

PROJECT NO:

JOHN WOLFE 142 SMITH RD. WATSONVILLE, CA 95076


SHEET TITLE FIRE NOTES

DRAWN BY: TOM STEWMAN PRINT DATE: JUNE 4, 2019 PLANNING PERMIT SUBMITTAL DATE: BUILDING PERMIT SUBMITTAL DATE:



SHEET 3 OF 10 SHEETS


1042 EGAN AVE. PACIFIC GROVE, CALIFORNIA 93950 TEI, 831 - 920 - 8814 postuai@nometiledesignstudio.com

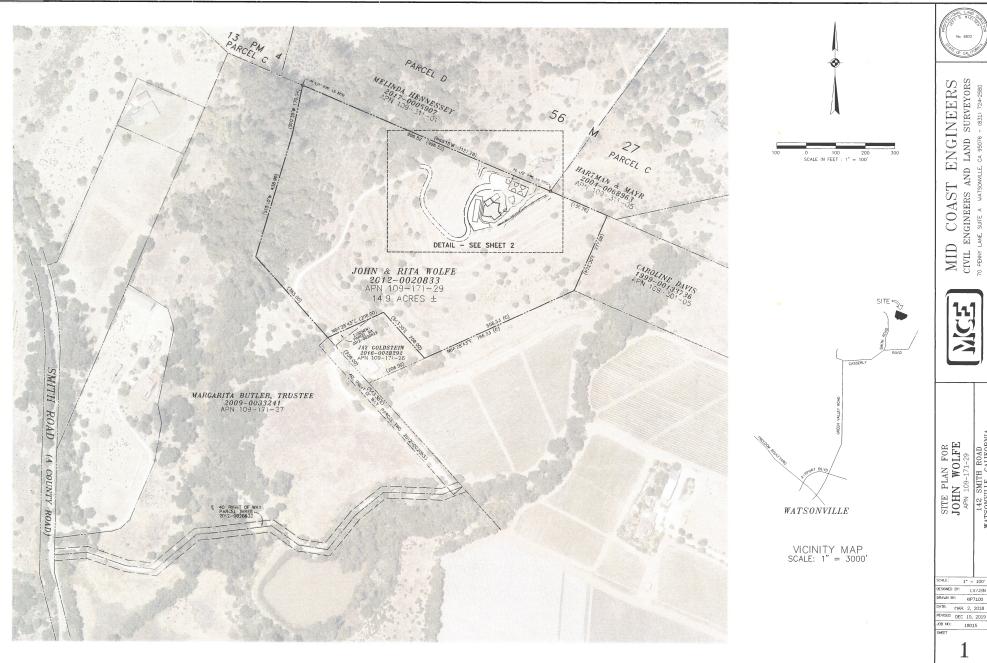





1" = 100' DESKINED BY: LV/JSN
DRAWN BY: KIP7100 KIP7100 DATE: MAR. 2, 2018

EVISED: DEC 10, 2019 JOB NO: 18015

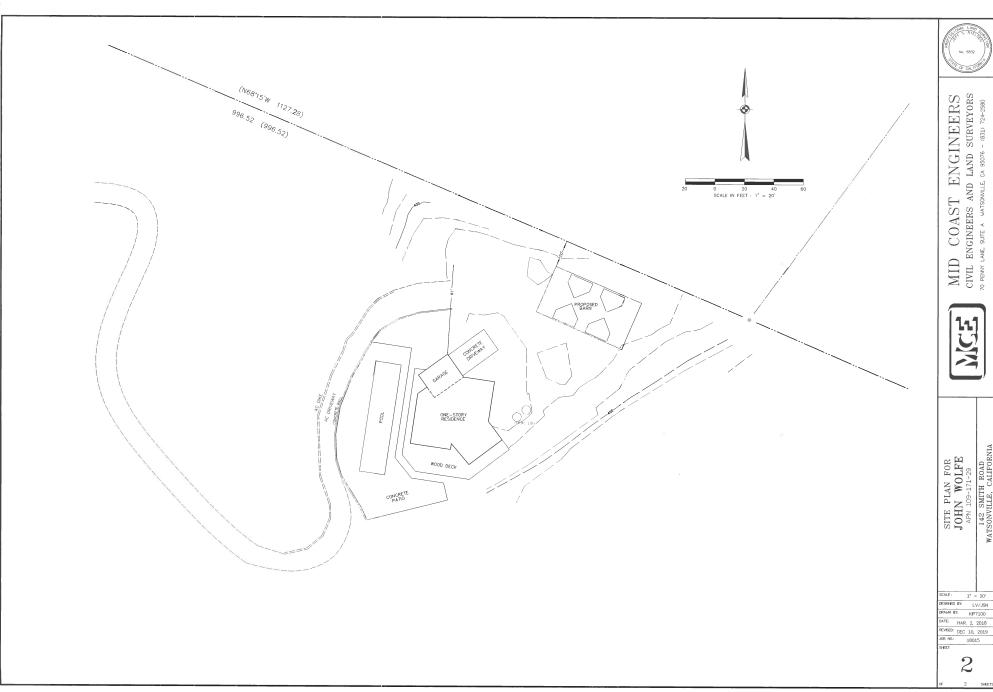

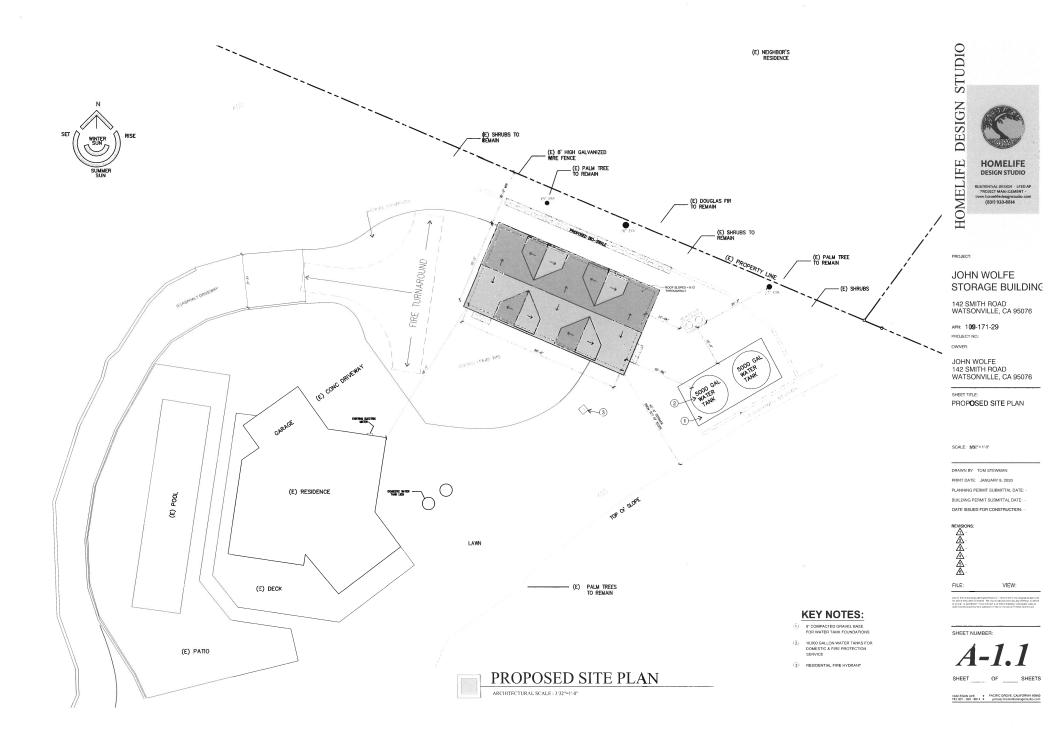

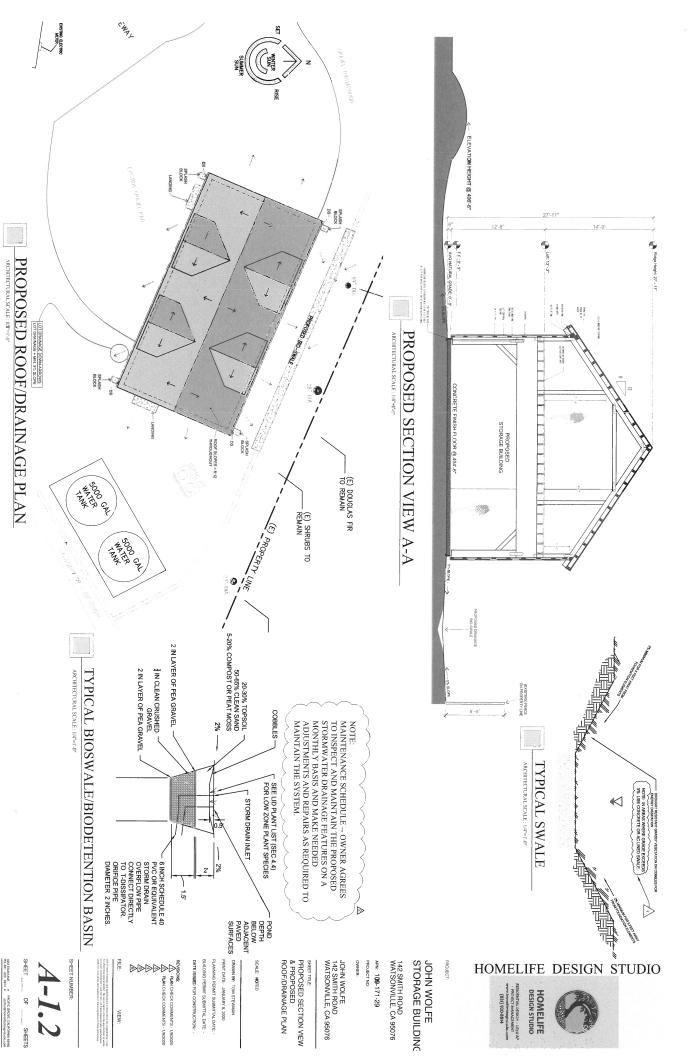

SANTA CRUZ COUNTY BEST MANAGEMENT PRACTICES

PART 2. STORMWATER POLLUTION CONTROL PLAN REQUIREMENTS

Section A -Plan Requirements

- A phased plan for controlling covion, sciliment drainage, and wante during the various planes of construction. This shall also include temporary planed grading contours if applicable.

 An inspection schedule by a stransm
- insertions exhalls by a tentement inserter that exhibit impostion of the loss extinction and frames control before prefixed exhibit even in extract of the control extract by the first proposition shall be plost downwarded exhibit by those downwarded exhibit proposition and the exhibit exhibit

- Caxer of Bare Solls. At level one of the fullowing erosion control measures must be indicated on the stormwater pollution control plan as a means to cover bare solid during the

- trosion control blankets placed within 100 feet of a riparian area or on sites with titler sensitive habitat must be biodegradable and must be noted on the plans. Examples of biodegradable and non-biodegradable evision control blankets are thous below.

- Seed and Straw Mulch is to be used for soil disturbed areas as a means for temporary Seed and straw mulch is to be used for soil disturbed areas as a means for temporary protection until permanent stabilization is established. It may be used on slopes up to 3:1 HzV (33%).
- Note: In acess that are not sensitive habitat, the seed shall be annual winter barley and the Straw shall be derived from rice, barley or wheat. In aces that are sensitive habitat, the seed mix and straw shall be accommended by the project biologist, be undicated on the plans, and approved by the Pla ming Department.

	Coronal Fiber
	Wood Fiber
Bonded Synthetic Fibers	Straw
Synthetic Fiber with Netting	Curled Wood Fiber
Plastic Mesh	Jute Mesh
Blankets	Blankets
Non-Biodegradable Erosion Contr	Biodegradable Erosion Control

If emsim control blankets are used as a method to control erosion, the plans must include Figure EC-1.

Section C - Sediment Control Requirements

Any project that involves ground disturbance shall include the fictivering minimum, sodiment control measures on their storms alor pollution control plan. The minimum sediment control measures shall be shown in plan view and shall include installation details and or more as shown facelin. Perluter Control. At best one of the following actionent control measures must be indicated on the stormwater pollution control plan as a means to prevent soil sediment form leaving the cite during the winter season.

- Elex Bolks (what Manda).

 Then this are to be placed at the down shop perimeter of the disturbance limit; to prevent or limit bediment from having the site, in arten areas or sixe deterily adjacent to street. Here this shall be placed the back of a debatt or can be limit actiment from entering the street. Here with on wanter on, enternth preferred our collision from entering the street. Here with one wanter on, enternth preferred our
- ber rolls are best used in low-exposure flow-sediment load areas. Fiber rolls at the or 3 slopes greater than 5: I (IV-Y) may require the use of 20 inch diameter ROLLS installations exhibiting the same protection (e.g., stacked smaller diameter fiber the etc.). Fiber rolls must be adequately trenched to be effective.

- Sit fances shall <u>not</u> be used on a slope, or across any contour line. If not installed a be same elevation throughout, sitt fences will exeate exestion.

- fences shalf not be used in strenms, is concentrated. clannels, drain inlets, or uny place when

The ends of the slit ferce shall be turned uphill to prevent stormwater from flowing around the fence.

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Storm Drain Inlet Protection

jects that include storm drain inlets or projects that drain into storm drains shall include asures on the stormwater pollution control plan to protect the inlets so silt and other lutants do not enter the storm drain system.

and rain intel protection consists of a sediment filter or an impounding area around or sum of a seven defin deep white, or can the lack Seven defin deep protection reasonably post orant before it creates the sound defin, allowing sediment to seable. Some configurations also crossors exiding the filtering, but usually the profiting action is in the general collinear to the filtering.

- Stabilized Construction Exit and Rocked Access Areas
- abblired construction exits are used to keep sediment from being tracked
- projects that include ground disturbance must include a stabilized construction unbest construction vehicles and equipment remain on paved surfaces at all times me construction.

STORAGE BUILDING JOHN WOLFE

- Plans shall show the location of the stabilized censtru construction details and notes Sublibed construction exits are to be 50 feet long x 12 feet wide (minimum) and one set of 3-6 inch rock.
- axes where the site cannot accommodate a stabilized construction exit that is 50 long, the plans shall incorporate an alternative subject to the approval of the number performent.

APN: 109-171-29 142 SMITH ROAD WATSONVILLE, CA 95076

Rocked Access Areas

Figure SC-5 must be shown on the plans.

- materials shall be disposed of properly.

Section D - Temporary Winter Drainage Control Requirements

Sediment Besid to be used when dollinge area is between 5 and 25 areas. Sediment basins are required to be used on sites where the disturbed draining area is between 5 area and 15 areas as a method to control draininge during construction, when the permanent draininge systems has not yet been installed.

Communion Medicilis.

All loses uschipide continuction materials that are not safricely being used (i.e. scil., expl., explice, appropriate, Typols, encore, bythered line, etc.) shall be convent and kerner.

All characters while it security and in wateright containing to the appropriate recording containment to prevent any shallong or leadings of in a natural, sold completely contained.

shall show the location and details of all sediment traps

inherent trags catable of impounding more than 1.200 cable yards shall be highed by a licensed civil engineer. The design shall include maintenance pitrements, including sediment and regention removal, to ensure continuous critin of the trap outlet and bypass structures.

oction E - Site Housekeeping Requirements

Acceptable methods to control numff on drivewrys and roadways is to install rolling dipts, gared bags, or bags neck borns series the driveway at 25-50 foot intervals to driven around to a temporary catch boatin or pipe that collects the water and drivets it to an adequate release point (such a: a sectiment trap or sediment basin).

projects shall include the following rainimum housekeeping notes on the storms arion control plan.

of contributing drainage area, respectively. Multiple traps and/or volume may be required to accommodate site specific rainfall and

recrete access auex, are used no control softment and evolum in areas on the project where evoluties and equipment park, travel and work. They are used primarily to keep construction whiches and equipment off of bare softs, All projects that include ground disturbance must include product necked access ands, unless construction, vehicles and equipment cruzials no paved surfaces at all times during construction.

Sediment: Trap / Sediment Basin At least one of the following drainage control measures must be indicated on the stormware pollution control plan as a means to control drainage draing the vinter scene. Sodiment traps and sediment basins must be designed by a licensed civil ongineer or architect.

isdiment. Trep (to be used when drainings; area is less, than 5 acres) sciament tapes are required to be used on sites where the disturbed draining rectainment tapes are required to be used on sites under during construction the less than 5 acres us a method to control draining of utility construction them the previously designed section has not set been installed. adiment trap is a containment area where sediment-laden runoff is youthly defained, allowing sediment to settle out before the runoff is harged. ment trays shall be located at the perimeter of the site at locations when the discharged offsite, at multiple locations within the project site when most control is needed, and/or around or upsispe from storm drain inleview newtone.

> Janagement Practices to prevent the off-site tracking of toose construction and ape materials shall be implemented. of construction materials to precipitation shall be minimized. This does a atterials and equipment that are designed to be outdoors and exposed and conditions (i.e. poles, equipment pads, cabines; conductors, insulator

liment basins should be located at the stormwater unifet from the site but not stream. A typical application would include temporary dikes, pipes, and/or unnels to divert runoff to the basin inlet.

orth thisis is a controlled storematter release structure formed by, as or et by construction of an enthusfurent of compacted soil. It is to trap scaliment before it leaves the construction sist. The board is a type measure with a design life of 12 to 28 months in most cases and is to intend until the site area is permanently protected against erostion or a stelleration bracin is constituted.

- al of Pay fine or wash waters or materials on importions or pervious site surfaces the summ duffine years all Pay proceeds the summ duffine years discharges of some finelline shall be contained (e.g., portable solute) to prevent discharges of some facilities and all the location of 20 first some same duffining propers or excerting water. In partial street or other amen of 20 first sown from an intel, street or different; stream, figurials area or other to finish.
- es shall be inspected regularly for leaks and spills and cleaned or
- posal containers at the end of every business day and during a rain event in week; disposal containers to the storm water drainings system of shall be prevented.
- ctively being used.

 effectively addition hazardous and non-hozardous spills shall be

- Equipment and materials for cleanay of spills shall be available on site and that spills and Mark shall be (cleaned in immediately) and dispersed of properly; and (secure to subsult areas and other washout areas that may extend additional pollutants shall be centimed on there is no discharge into the underlying sail and onto the surrounding areas.

<u>Control of Driveway/Readway Runoff</u> Projects that include driveways or readway, shall include provisions on the stormwater politions control plan to control drianage on the driveway or readway during the winter season if the final surfacing (e.g. aspletd) is not in place.

inent traps cayable of impounding more than 1,300 cubic yards shall be igned by a liceased civil engineer. The design shall include maintenance irrements, including sediment and vegetation removal, to ensure continuous crion of the trap oullet and bypass structures.

tediment traps shall be sized to accorrenodate a settling zone and sodimen torage zone with minimum volumes of 67 cubic yards/here and 33 cubic

BEST MANAGEMENT PRACTICES

JOHN WOLFE 142 SMITH ROAD WATSONVILLE, CA 95076

- Which's ("ingragad Melintums."

 Viesures, shall be waten in precess of ingenee, or fied in 'risk' in to the ground, soom therines or unfector waters.

 All opportunest or wholes, which are to be fielded, minimized and served roome shall be in a designated area filled with appropriate IMPs.

 Leaks shall be immediately operated and leaked restricteds shall be disposed of properly.

- in ferdiform and other landscape materials when they are not actively being seed, onlines the application of any condible landscape material within 2 says before a sected line seem of ultraing periods of preceipitrion.

 by condible landscape material at quantities and application rates according to the condition of the condition of the condition and productions by knowledgeable and landscape the condition on the sead occurring a condition and materials when the condition that the condition of the condition

PRINT DATE: APRIL 15, 2019
PLANNING PERMIT SUBMITTAL DATE: BUILDING PERMIT SUBMITTAL DATE: -DRAWN BY: THOMAS BONYNGE


DATE ISSUED FOR CONSTRUCTION:


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SHEET - OF - SHEETS






INSPECTION - PRIOR TO LAND DISTURBANCE PRIOR TO LAND DISTURBANCE, THE APPLICANT SHALL SCHEDULE AN INSPECTION WITH PRIOR TO FINAL INSPECTION, THE OWNER/APPLICANT SHALL SCHEDULE AN INSPECTION WITH RMA-ENVIRONMENTAL SERVICES TO ENSURE THAT ALL DISTURBED AREAS HAVE BEEN STABILIZED & THAT ALL TEMPORARY EROSION & SEDIMENT CONTROL MEASURES THAT ARE NO LONGER NEEDED HAVE BEEN REMOVED.

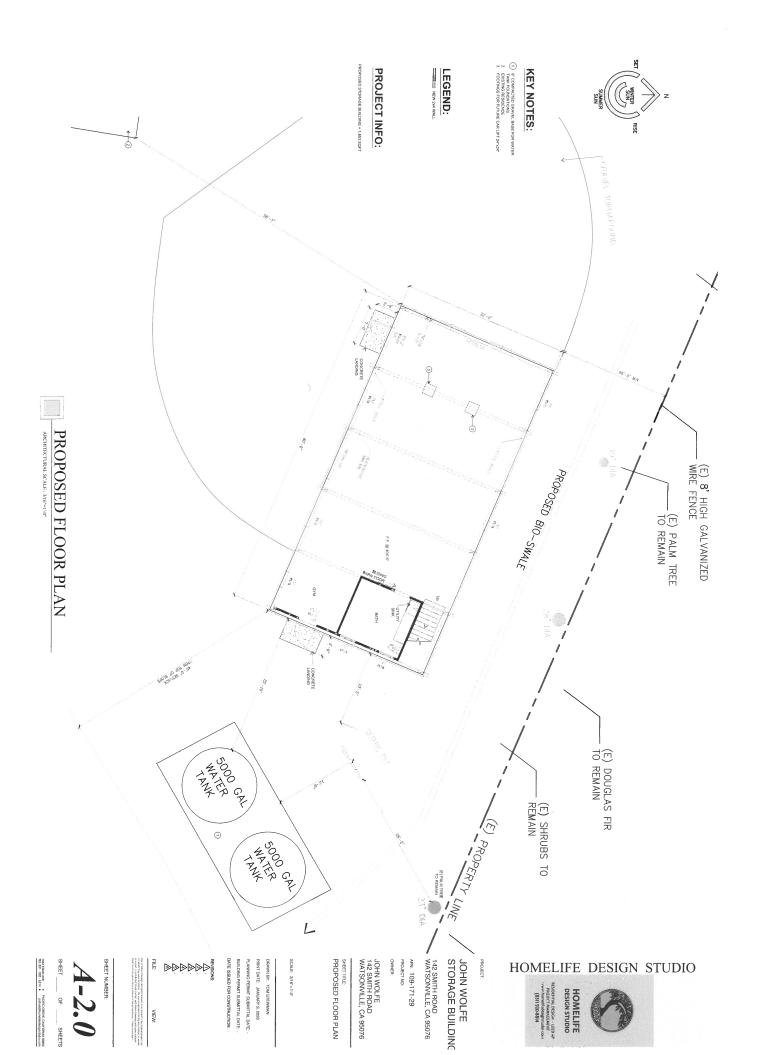RMA-ENVIRONMENTAL SERVICES TO ENSURE ALL NECESSARY SEDIMENT CONTROL MEASURES ARE IN PLACE AND THE PROJECT IS COMPLIANT WITH MONTEREY COUNTY

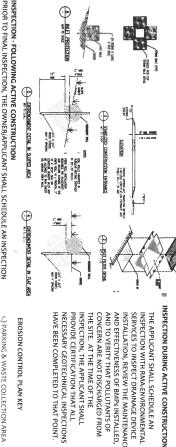GRADING AND EROSION CONTROL REGULATIONS.

EROSION CONTROL PLAN

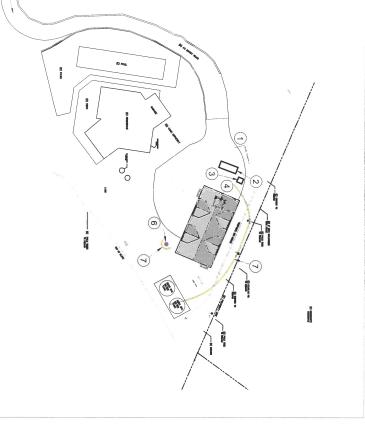

142 SMITH RD. WATSONVILLE, CA 95076

INSPECTION, THE APPLICANT SHALL SERVICES TO INSPECT DRAINAGE DEVICE INSTALLATION, REVIEW THE MAINTENANCE HAVE BEEN COMPLETED TO THAT POINT NECESSARY GEOTECHNICAL INSPECTIONS PROVIDE CERTIFICATION THAT ALL CONCERN ARE NOT DISCHARGED FROM AND EFFECTIVENESS OF BMPs INSTALLED, INSPECTION WITH RMA-ENVIRONMENTAL THE APPLICANT SHALL SCHEDULE AN THE SITE. AT THE TIME OF THE AND TO VERITY THAT POLLUTANTS OF

EROSION CONTROL PLAN KEY

1.) PARKING & WASTE COLLECTION AREA

4.) JOB SITE TOOL STORAGE - IN STORAGE BUILDING

5.) CONSTRUCTION ENTRANCE CONCRETE WASHOUT

7.) STRAW WATTLE

VICINITY MAP



to 1231 Buena Vista Dr., Watsonville, CA 95076 from 142 Smith Rd., Watsonville, CA 95076

HAULING TRUCK



CONSTRUCTION NOTES

- ALL WORK SHALL TAKE PLACE DURING DAYLIGHT HOURS, MONDAY FRIDAY, 8 AM TO 5PM
 WATER ALL ACTIVE CONSTRUCTION AREAS AT LEAST TWICE PER DAY,
 REQUENCY SHOULD BE BASED UPON THE TYPE OF OPERATION, SOIL,
 NO. WAYNG TO COLOR.
- 3. ALL GRADING ACTIVITIES SHALL BE HALTED DURING PERIODS OF HIGH
 WINDS (1.5 MPH).
 WINDS (1.5 MPH).

DESIGN STUDIO

- HAUL TRUCKS SHALL MAINTAIN 2 FEET FREEBOARD AND BE COVERED.
 COVER INACTIVE STORAGE PILES.
 THE SIGNED BERMITS AND THE APPROVED CONSTRUCTION PLANS SHALL
 BE MAINTAINED IN A CONSPICUOUS LOCATION AT THE CONSTRUCTION
 DOB SITE AT ALL TIMES, AND THAT COPIES ARE AVAILABLE FOR AGENCY
 REVIEW UPON REQUEST. ALL BERSONS INVOLVED WITH THE
 CONSTRUCTION SHALL BE BRIEFED ON THE CONTENT AND MEANING OF

HOMELIFE DESIGN STUDIO

- THE PERMITS AND THE APPROVED CONSTRUCTION PLANS, AND THE PRINTIS AND THE APPROVED CONSTRUCTION PLANS, AND THE PUBLIC REVIEW REQUIREMENTS APPLICABLE TO THEM, PRIOR TO COMMENCEMENT OF CONSTRUCTION STATE.

 2. EQUIPMENT WASHING, REFUELING AND SERVICING SHALL TAKE PLACE ONLY ONSITE. APPROPRIATE BEST MANAGEMENT PRACTICES SHALL BE USED TO EMSURE THAT NO SPILLS OF PETROLEUM PRODUCTS OR OTHER CHEMICALS TAKE PLACE DURING THESE ACTIVITIES. SEE THE EROSION CONTROL PLAN FOR FURTHER SECTICATIONS.

 5. THE CONSTRUCTION SITE SHALL MAINTAIN GOOD CONSTRUCTION SITE HOUSEKEEPING CONTROLS AND PROCEDURES (E.G.: CLEANUP ALL LEAKS, DRIPS, AND OTHER SPILLS IMMEDIATELY, KEEP MATERIALS COVERED AND OUT OF THE RAIN, INCLUDING COVERING EXPOSED PILES OF SOILS AND WASTES, DISPOSE OF ALL WASTES PROPERLY, PLACE TRASH RECEPTACLES ON SITE OR THAT PURPOSE, AND COVER OPEN TRASH RECEPTACLES ON SITE OR THAT PURPOSE, AND COVER OPEN TRASH RECEPTACLES ON SITE OR THAT PURPOSE, AND COVER OPEN TRASH RECEPTACLES ON SITE OF CONSTRUCTION AS WELL AS AT THE END OF EACH WORKDAY, AT A MINIMUM, SILT TENCES, OR EQUIVALENT ADDRAFALS, SHALL BE INSTALLED AT THE ROMESTER OF THE COMMENCEMENT OF CONSTRUCTION AS WELL AS AT THE END OF EACH WORKDAY, AT A MINIMUM, SILT TENCES, OR EQUIVALENT ADDRAFALTS, SHALL BE INSTALLED AT THE PERMITTER OF THE CONSTRUCTION SITE TO PREVENT CONSTRUCTION-RELATED RUNOFF AND
- OR SEDIMENT FROM LEAVING THE SITE.

CONSTRUCTION COORDINATOR

AND 24-HOUR PHONE NUMBERS) SHALL BE CONSPICUOUSLY POSTED AT THE ODB STITE IN A MANURER THAT THE CONTACT INFORMATION IS REDLIV VISIBLE FROM PUBLIC VIEWING AREAS, THE POSTING SHALL INDICATE THAT THE CONSTRUCTION COORDINATOR SHOULD BE CONTACTED TO ANSWER ANY QUESTIONS THAT ARISE DURING CONSTRUCTION (IN CASE OF BOTH REGULAR INQUIRES AND IN EMERGENCIES). THE CONSTRUCTION COORDINATOR SHALL RECORD THE NAME, PHONE NUMBER AND ANTURE OF ALL COMPLAINTS AND TAKE REMEDIAL ACTION, IT NECESSARY, WITHIN 24 HRS OF RECEIPT OF THE COMPLAINT OR INQUIRY. CONTRACTOR SHALL PROVIDE A CONSTRUCTION COORDINATOR THAT CAN BE CONTACTED DURING CONSTRUCTION, SHOULD QUESTIONS ARISE DURING CONSTRUCTION (1N CASE OF BOTH REGULAR INQUIRES AND IN EMERGENCIES). THEIR CONTACT INFORMATION (INCLUDING THEIR ADDRESS

CONSTRUCTION ACTIVITY DESCRIPTION

DURATION: APR 2020 - OCT 2020

MONDAY THRU FRIDAY 8AM - 5PM

8 WORKERS 4 REGULAR PICKUP TRUCKS

80% RECYCLE RATE FOR LUMBER.

TRASH AND UNRECYCLED DEBRIS ARE COLLECTED ON STIE IN A PORTABLE TRAILER AND REMOVED BY TOWING BEHIND A REGULAR PICKUP TRUCK ONCE A MONTH TO THE MARINA LANDFILL.

AREA 1: VEHICULAR PARKING ON EXISTING ASPHALT DRIVEWAY AREA 2: MATERIAL STOCKPILE AREA 3: PORTY POTTY AREA 4: JOB SHACK

THE ONLY GRADING TO BE DONE IS TO CUT THE FOOTINGS. THERE IS NO IMPORT OR EXPORT OF DIRT.

HOMELIFE

STORAGE BUILDING JOHN WOLFE

142 SMITH RD. WATSONVILLE, CA 95076 APN: 109-171-29

JOHN SMITH 142 SMITH RD. WATSONVILLE, CA 95076

CONSTRUCTION MANAGEMENT PLAN

RINT DATE: OCTOBER 30, 2019 ANNING PERMIT SUBMITTAL DATE: N BY: TOM STEWMAN

VIEW

SHEET NUMBER

유

GENERAL CONTRACTOR SHALL VERIFY ALL DIMENSIONS AND JOB SITE CONDITIONS BEFORE COMMENCING GENERAL NOTES AND RECOMMENDATIONS

WORK AND SHALL REPORT ANY DISCREPENCIES TO SAND CREEK POST & BEAM.

APPLICABLE COPES OR REGILATIONS IN YOR AREA ME RECOMPEND THAT THE MORE STRINGENT PROVISION BE FOLLOWED DIRNING CONSTRUCTION, VARIATIONS REGULEED BY LOCAL BILLDING OFFICIALS SHALL NOT BE CODES/REGILATIONS, THE PROJECTS STRUCTURAL REQUIREMENTS, AND/OR EXISTING CONDITIONS SPECIFIC TO THE PLANS TO YOUR LOCAL INSPECTOR TO MAKE SURE THEY SATISFY STATE OR LOCAL BUILDING BINDING ON THE DESIGNER OR SAND CREEK POST & BEAM. SITE. IN THE EVENT OF A CONFLICT BETWEEN SPECIFICATIONS CONTAINED WITHIN THIS SET OF PLANS AND TAILOR THIS PLAN TO YOUR SITUATION BECAUSE LOCAL CODES VARY WE SUGGEST YOU TAKE THESE AN ARCHITECT OR ENGINEERING FIRM, ADDITIONAL PROFESSIONAL SERVICES MAY BE REQUIRED TO 2. THESE DRAWINGS PROVIDE SUGGESTED DESIGNS AND MATERIALS ONLY AND ARE NOT PRODUCED BY

3. DEEY EFFORT HAS BESH MADE TO ELIMINATE ERRORS DIRHIG HE PREPARATION OF THEES DRAMINES, BIT BECAMES SAND CREEK POST I BEAM CANNOT GIMENNIES AGAINST THE POSSIBILITY OF HAVAIL BROOK, IT BECOMES THE OBLIGATION OF THE MOST TO YEAR'S THE ACCURACY OF ALL DETAILS AND DIMENSIONS AND PERSONALLY BE RESPONSIBLE FOR THEM.

4. USE WRITTEN IDMENSIONS. DO NOT USE SCALED DIMENSION. IF DIMENSION IS NEEDED CONSILT SAND CREEK POST (BEAM BEFORE PROCEEDING.

MECHANICAL/ELECTRICAL CONTRACTOR FOR THEIR USE. 5. ALL MECHANICAL AND ELECTRICAL PLANS AND SPECIFICATIONS ARE DESIGNIBILID FIRNISHED BY THE

6. ALL TIMBERS ARE FULL DIMBISION ROUGH SAMI WILESS NOTED. SILL FLATE 15 2% EASTERN RED CEDAR. ME RECOMMEND SILL SEALER DE INSTALED BENEATH THE SILL FLATE.

BOLT CLEARANCE. THE INTERIOR OF THE BARN. THE SIDING OR FRANING MAY NEED TO BE NOTCHED SLIGHTLY FOR PLATE AND 1. WHERE FEASIBLE INSTALL THE BOLTS IN THE PLATE JOINERY SO THAT THE NUTS CAN BE ACCESSED FROM

8. VERIFY MINDOM AND DOOR ROUGH OPENINGS BEFORE FRANING.

BE PROVIDED BY GENERAL CONTRACTOR. CONTRACTOR INSTALL Z FLASHING @ ALL BREAKER BOARD LOCATIONS. IF Z FLASHING IS INSTALLED IT IS TO 9. WE RECOMMEND IX3 BREAKER BOARD BE INSTALLED AT SIDING SPLICES. WE RECOMMEND THAT THE

CUSTOMER OR GENERAL CONTRACTOR. OR PENETRATIONS AS REGUIRED BY 6000 CONSTRUCTION PRACTICES. FLASHING TO BE PROVIDED BY 10. EXTERIOR FLASHING TO BE INSTALLED AT ALL CONNECTIONS BETWEEN ROOFS, WALLS, AND PROJECTIONS

II. BE AWARE THAT EXCESSIVE LOADS PLACED IN THE LOFT MAY CAUSE STRUCTURAL DAMAGE

THE SAND CREEK POST & BEAM MATERIALS LIST ARE TO BE PROVIDED BY THE BIYER 12. ANY MATERIALS SHOWN ON THESE DRAWINGS WHICH ARE NOT WRITTEN IN YOUR CONTRACT OR INCLUDED IN

RECOMMEND FOUNDATION DESIGN TAKE THIS INTO CONSIDERATION AND RELATED DETAILS, FOOTINGS AND DETAILS SHOWN ARE FOR ILLUSTRATION ONLY, POST AND BEAM FRANCED STRUCINESS TRANSMIT HEAVY CONCENTRATED LOADS THROUGH THE POSSS TO THE FOUNDATION, ME CONDITIONS AND GRADE VARIATION TO BE BUILDERS FINAL DETERMINATION FACTOR IN SIZING OF FOOTINGS SATISFY THE LOCAL BUILDING CODE REGUIREMENTS, SOIL CONDITION, FROSTLINE DEPTH, LOCAL CODES, HIDDEN THESE DRAWINGS. IT IS THE RESPONSIBILITY OF THE BUYER, OR ON SITE FOUNDATION CONTRACTOR TO LOCAL BUILDING CODE SPECIFICATIONS TAKE PRECEDENCE OVER THE STANDARD INFORMATION SHOWN IN


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00/00/2019	00/00/2019	00/00/2019	00/00/2019	00/00/2019	00/00/2019	00/00/2019	12/19/2019	10/10/2019	10/03/2019	DATE:	REVISION HISTORY
	:		:	:			LOFT MINDOWS, MOVED STAIRS, SHORTENED HEIGHT OF BUILDING	BENT CHANGES	INITIAL DRAWINGS	DESCRIPTION	


STEEL IN SECTION BATT INSULATION IN SECTION

SAND OR GRAVEL IN SECTION CONCRETE IN SECTION

INSULATION NAILBASE IN SECTION

ARCH ROOF BOARD AND BATTEN SIDING

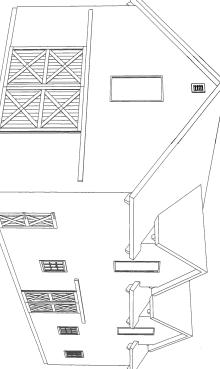

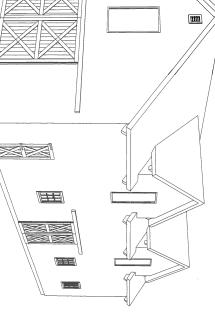

- ROOF FINISH MATERIAL - LOFT MINDOWS

- FOUNDATIONS

BY SAND CREEK POST AND BEAM

DRAMINGS

밀

AR

NOT PROVIDED

_IST BELOW ARE ITEMS SHOWN IN

NOT INTENDED FOR USE AS CONSTRUCTION DRAWINGS (SHEET #1) ARE REPRESENTATIONAL ONLY AND ARE

OVER SHEET NOTE: LINE 3D DIAGRAMS ON COVER SHEET

SHEET INDEX

- COVER SHEET
- EXTERIOR ELEVATIONS

 EXTERIOR ELEVATIONS
- MAIN FLOOR PLAN BUILDING SECTION
- LOFT FLOOR PLAN

PROJECT LOCATION

ADDRESS: 1535 SUNSET WAY, APTOS, CA 95003

MOOD TYPE


STRUCTURAL FRAMING: PONDEROSA PINE #2 OR BETTER

BUILDING ERECTION SAFETY NOTES.

THE CONTRACTOR IS RESPONSIBLE FOR INFLIDENTING JOB STIE SAFETY AND CONSTRUCTION PROXIDERS IN ACCORDANCE WITH INNTOWN, STATE, AND JOXAL SAFETY REQUIRENTS. THE ADEQUACY AND SAFETY OF THE SOLE RESPONSIBILITY OF THE GENERAL CONTRACTOR.

SYMBOLS

MOOD IN SECTION

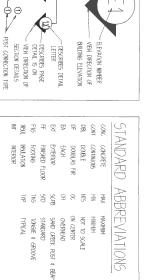



CUSTOMER: JOHN MOLFE

JOB CODE:

I-blbOM

REVISION: 2 (12-19-19)

STYLE:

PONDEROSA BARN

DRAWN BY:

116 W. 1st St SAND CREEK POST & BEAM

WAYNE, NE 68787

PH: (402) 833-5600 FAX: (402) 833-5602 Toll-free: 1 886-489-1680

SHEET #: 1

DRAWING STATUS: NOT FOR CONSTRUCTION

