

APTOS BRANCH LIBRARY

7695 SOQUEL DRIVE APTOS, CA 95003

PLANNING SUBMITTAL

NOVEMBER 9, 2020

COUNTY STAMP AND ISSUANCE




Anderson Brulé
Architects

325 South First Street, 4th Floor San Jose, California 95113 408.298.1885 | www.aba-arch.com

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NO. DATE REVISIONS

PROJECT TITLE:

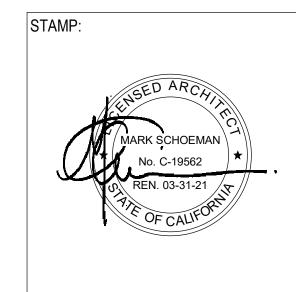APTOS BRANCH LIBRARY

7695 SOQUEL DR. APTOS, CA 95003

PROJECT NO.	20040)5
DATE:	11/9/20)2
SHEET TITLE:		

COVER SHEET

SCALE:

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G000

PROJECT DESCRIPTION

Google

STAFF, CHILDREN'S, ADULT'S AND TEEN'S WHILE ALLOWING PRIVACY WITH THE OUTER CORNERS OF THE BUILDING MASS.

Seascape Golf Club

THE APTOS BRANCH OF THE SANTA CRUZ COUNTY PUBLIC LIBRARY SYSTEM HAS OUTGROWN ITS CURRENT FACILITIES. IN ORDER FOR THE LIBRARY TO FUNCTION IN ITS CURRENT AND PROPOSED SERVICES, THE LIBRARY REQUIRES A NEW FACILITY OF APPROXIMATELY12,000 SQUARE FEET. THE CURRENT FACILITY IS APPROXIMATELY 7,500 SQUARE FEET. THE GOAL OF THIS PROJECT IS TO PROVIDE TARGET PROGRAMS AND SERVICES THAT CAN WORK WITHIN THE PROJECT CONSTRAINTS. AND MEET THE MISSION STATEMENT FOR THE SANTA CRUZ COUNTY PUBLIC LIBRARY SYSTEM.

THE SKEWED BUILDING ORIENTATION UTILIZES THE FULL POTENTIAL OF THE SITE'S SOLAR ORIENTATION, RESPECTS THE NEIGHBORHOOD SCALE AND CONTEXT, PROVIDES ICONIC VIEWS INTO THE SITE AND OUT TO THE COMMUNITY, AND MANAGES SITE TRAFFIC FLOW. THE SCALE AND PROPORTION OF THE PROPOSED DESIGN IS A RESULT OF CAREFUL CONSIDERATION OF THE NEIGHBORHOOD SCALE AND MASS. THE BUILDING HAS BEEN LOWERED ALONG THE EASTERN EDGE TO PRESERVE NEIGHBORS' PRIVACY AND VIEWS. ONE OF THE PRIMARY OBJECTIVES WAS TO LOWER THE LIBRARY BUILDING AS MUCH AS POSSIBLE WHILE MAINTAINING SMOOTH FLOW FROM PARKING TO THE MAIN ENTRY TO MITIGATE SCALE. SECURITY AND ACCESS CONCERNS.

THE MASSING PAYS HOMAGE TO THE CULTURAL HISTORY OF APTOS' LUMBERMILLS, APPLE ORCHARDS AND THE RAILROAD WITH THE GABLE/BARN FORM THAT EVOLVED WITH THE MASSING STUDY. THE STUDY OF INTERIOR SPACE ADJACENCIES CALLED FOR A DISTINCTIVE TALLER MASS AT THE MAIN CIRCULATION SPINE AT +/- 21 FEET IN HEIGHT WITH MAIN ENTRY AND MARKETPLACE AT NORTH AND ICONIC WINDOW OUT TO THE COMMUNITY AT SOUTH. THE FEATURE AIDS WAYFINDING PROVIDING UNOBSTRUCTED SIGHTLINES THROUGH THE LIBRARY. THE PRESENCE OF THE COMMUNITY ROOM IS REINFORCED WITH A TALLER MASS, AS IS THE ADULT'S STACK AREA. THE LOWER INTIMATE MASSING AT THE CHILDREN'S AREA IS INTENDED TO CREATE SPACE THAT IS NOT JUST SCALE APPROPRIATE, BUT SHELTERED AND COZY, IDEAL FOR STORY TIME. THE TEEN'S SPACE IS ALSO A LOWER MASS APPROPRIATE TO THE SIZE OF THE SPACE AND CREATE A WARM, CASUAL SPACE WITH ACCESS TO LIGHT AND VIEWS. THE ROTATED BUILDING INTENTIONALLY CAPTURES OUTDOOR SPACES FOR

THE FENESTRATION, THE ARRANGEMENT OF WINDOWS AND DOORS ON THE LIBRARY'S EXTERIOR ELEVATIONS, VARIES BETWEEN TALLER LARGER STOREFRONT WINDOWS AT THE COMMUNITY-FACING SPACES TO SMALLER PUNCHED WINDOWS RESPECTFUL OF NEIGHBORS. THE TALLER GLAZING AT THE ADULT'S WING AT THE LIBRARY'S SOUTHERN END SERVES AS A WINDOW FROM THE COMMUNITY INTO THE LIBRARY. WINDOWS ARE STRATEGICALLY PLACED CLOSER TO THE CEILING AT THE TALLER MASSES TO CAPTURE DIFFUSED DAYLIGHT FROM THE NORTH. OPENINGS ARE STAGGERED, SO THEY ARE SHADED DURING WARM MONTHS YET BRING WARMTH AND LIGHT DURING THE WINTER MONTHS.

THE EXTERIOR MATERIALS ARE A SIMPLE JUXTAPOSITION OF WOOD AND PLASTER THAT CREATE A TIMELESS LIBRARY. THE MATERIALS ARE USED STRATEGICALLY TO DRAW ATTENTION TO THE ICONIC MASS AND MAIN ENTRY WITH WARM WOOD CLADDING. THE BUILDING'S EXTERIOR COLOR AND FINISHES CREATE CONTRAST BETWEEN THE COOL LIGHT-COLORED PLASTER AND THE WARM MATERIALS USED AT THE MAIN ENTRY AND TALLER CIRCULATION SPINE.

THE PROJECT REORIENTS THE PARKING SPACES FROM ANGLED TO STRAIGHT, INCREASING EFFICIENCY, ACCOMMODATING 73 AUTOMOBILES, INCLUSIVE OF THE REQUIRED ACCESSIBLE AND ELECTRIC CHARGING SPACES. THE ENTIRE PARKING LOT WILL BE REPAIRED AND SLURRY SEALED. ALL-NEW STRIPING WILL REFLECT THE REVISED PARKING LAYOUT. THE DESIGN MEETS THE COUNTY'S REQUIRED 20 FEET SETBACKS ON ALL SIDES.

	EXISTING	PROPOSED
BUILDING (GSF)	8,800 GSF*	12,490 GSF
BUILDING (NSF)	7,547 NSF*	11,955 NSF
OCCUPANT LOAD	216**	336**
BUILDING HEIGHT	21' - 7 1/2"	24' - 4 1/2"

BALCONIES AND SIMILAR PROJECTIONS ON BUILDINGS OF TYPES III, IV AND V CONSTRUCTION SHALL

AN AUTOMATIC SPRINKLER SYSTEM SHALL BE PROVIDED THROUGHOUT STORIES CONTAINING GROUP A-3 OCCUPANCIES AND THROUGHOUT ALL STORIES FROM THE GROUP A-3 OCCUPANCY TO AND INCLUDING THE

AUTOMATIC SPRINKLER SYSTEMS SHALL BE DESIGNERED AND INSTALLED IN ACORDANCE WITH SECTIONS

SECTION 903.3.1 - STANDARDS

SPRINKLER SYSTEMS SHALL BE DESIGNED AND INSTALLED IN ACCORDANCE WITH SECTION 903.3.1.1 UNLESS OTHERWISE PERMITTED BY SECTIONS 903.3.1.2 AND 903.3.1.3 AND OTHER CHAPTERS OF THIS CODE. AS APPLICABLE.

SECTION 903.3.1.1 - NFPA 13 SPRINKLER SYSTEMS

WHERE THE PROVISIONS OF THIS CODE REQUIRE THAT A BUILDING OR PORTION THEREOF BE EQUIPPED THROUGHOUT WITH AN AUTOMATIC SPRINKLER SYSTEM IN ACCORDANCE WITH THIS SECTION, SPRINKLERS SHALL BE INSTALLED THROUGHOUT IN ACCORDANCE WITH NFPA 13 AS AMENDED IN CHAPTER 35 EXCEPT AS PROVIDED IN SECTION 903.3.1.1.1 AND 903.1.1.2.

GENERAL BUILDING LIMITATIONS

SECTION 504.1 GENERAL

THE HEIGHT, IN FEET, AND THE NUMBER OF STORIES OF A BUILDING SHALL BE DETERMINED BASED ON THE TYPE OF CONSTRUCTION, OCCUPANCY CLASSIFICATION AND WHETHER THERE IS AN AUTOMATIC SPRINKLER SYSTEM INSTALLED THROUGHOUT THE BUILDING.

SECTION 504.3 - HEIGHT IN FEET - THE MAXIMUM HEIGHT, IN FEET, OF A BUILDING SHALL NOT EXCEED THE LIMITS SPECIFIED IN TABLE 504.3.

SPECIAL DETAILED REQUIREMENTS BASED ON OCCUPANCY & USE

SECTION 449 - PUBLIC LIBRARYIES [SL AND SFM] 449.1 - AUTOMATIC SPRINKLES SYSTEM

449.2 - SYSTEM MONITORING REQUIREMENT ALL FIRE PROTECTION SYSTEMS SHALL BE MONITORED BY A FIRE ALARM SUPERVISING STATION IN ACCORDANCE WITH THE NFPA 72.

449.3 - BOOK RETURN SLOTS

ANY INTERIOR BOOK RETURN WITH A SLOT PIERCING THE EXTERIOR WALL SHALL HAVE A SEPARATE SPRINKLER HEAD AND BE ENCLOSED IN FIRE-RATED CONSTRUCTION

449.4 - AUTOMATIC SPRINKLER AND EXTINGUISHING SYSTEMS

SHEET INDEX

COVER SHEET SHEET INDEX AND GENERAL INFORMATION

GENERAL

G000

G001

CIVIL

C0.0

TS-1

TS-2

C1.0

C2.0

C2.1

C3.0

C4.0

C4.1

C4.2

C5.0

C5.1

L1.02

L1.03

L5.00

L5.01

L5.02

L6.00

A110

A150

A200

A210

A300

A400

M1.1

MECHANICAL

LANDSCAPE

ARCHITECTURAL

COVER SHEET EXISTING SITE (SOUTH) EXISTING SITE (NORTH) SITE PLAN GRADING & DRAINAGE PLAN (NORTH) **GRADING & DRAINAGE PLAN (SOUTH)** UTILITY PLAN STORMWATER CONTROL PLAN STORMWATER MITIGATION DETAILS **DETENTIONCAL CALCULATIONS OFF-SITE IMPROVEMENT PLAN** OFF-SITE IMPROVEMENT PLAN

OVERALL LANDSCAPE SITE PLAN MATERIALS ENLARGEMENT PLAN MATERIALS ENLARGEMENT PLAN OVERALL AND TREE PLANTING PLANTING ENLARGEMENT PLAN PLANTING ENLARGEMENT PLAN SITE LIGHTING PLAN

SITE PLAN **ENLARGED SITE PLAN** SITE DEMOLITION PLAN FLOOR PLAN **ROOF PLAN EXTERIOR ELEVATIONS** SITE SECTION AND MASSING PERSPECTIVES

ROOF PALN MECHANICAL (FOR REFERENCE)

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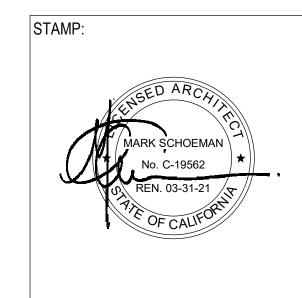
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APTOS BRANCH LIBRARY

7695 SOQUEL DR. **APTOS, CA 95003**

PROJECT NO.		200405
DATE:	1	11/9/2020
SHEET TITLE:		

SHEET INDEX AND **GENERAL** INFORMATION

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PROJECT SITE:

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APTOS, CA, 95003

ABBREVIATIONS

AGGREGATE BASE

AD	ACCRECATE DAGE	1144	III Y LIVI
ARV	AIR-RELEASE VALVE	IRR	IRRIGATION
BFP	BACKFLOW PREVENTER	JB	JUNCTION BOX
BO	BLOW-OFF VALVE	JT	JOINT TRENCH
BRW	BOTTOM OF RETAINING WALL	LF	LINEAR FOOT
BSW	BACK OF SIDEWALK	LIP	LIP OF GUTTER
BVC	BEGIN VERTICAL CURVE	LOG	LIMIT OF GRADING
BW	BOTTOM OF WALL	LP	LOW POINT
CATV	CABLE TELEVISION	MFS	MECHANICAL FILTRATION SYSTEM
СВ	CATCH BASIN	MH	MANHOLE
CI	CURB INLET	N	NORTH
CIP	CAST IRON PIPE	NE	NORTHEAST
CL	CENTERLINE	NW	NORTHWEST
CMP	CORRUGATED METAL PIPE	ОН	OVERHEAD
CMU	CONCRETE MASONRY UNIT	PCC	PORTLAND CEMENT CONCRETE
CO	CLEANOUT	PE	POLYETHYLENE
COMM	COMMERCIAL	PP	POWER POLE
CONC	CONCRETE	PL	PROPERTY LINE
COTG	CLEANOUT TO GRADE	PRC	POINT OF REVERSE CURVE
DIP	DUCTILE IRON PIPE	PIV	POST-INDICATOR VALVE
DOM	DOMESTIC	PV	PAVEMENT
	DETAIL	PVC	
DTL			POLYVINYL CHLORIDE PIPE
DWG	DRAWING	R	RADIUS
DWY	DRIVEWAY	RCP	REINFORCED CONCRETE PIPE
E	EAST, ELECTRICAL	ROW	RIGHT-OF-WAY
EG	EXISTING GROUND	RPPB	REDUCE PRESSURE PRINICIPLE BACKFLOW
EP	EDGE OF PAVEMENT	RW	RECYCLED WATER
(E)	EXISTING	S	SOUTH, SLOPE
(E)		SD	STORM DRAIN
EX.	EXISTING		
FC	FACE OF CURB	SE	SOUTHEAST
FDC	FIRE DEPARTMENT CONNECTION	SDMH	STORM DRAIN MANHOLE
FG	FINISH GRADE	SS	SANITARY SEWER
FF	FINISH FLOOR	SSMH	SANITARY SEWER MANHOLE
FH	FIRE HYDRANT	STA	STATION
FL	FLOWLINE	STD	STANDARD
FNC	FENCE	SW	SIDEWALK, SOUTHWEST
FO	FIBER OPTIC	T	TELEPHONE
		TC	TOP OF CURB
FT	FOOT/FEET	TRAN	TRANSFORMER
FW	FIRE WATER		
G	GAS	TRW	TOP OF RETAINING WALL
GB	GRADE BREAK	TW	TOP OF WALL
HT	HEIGHT	USA	UNDERGROUND SERVICE ALERT
HDPE	HIGH-DENSITY POLYETHYLENE	VG	VALLEY GUTTER
HP	HIGH POINT	W	WEST, WATER
INT	INTERSECTION	WM	WATER METER
1141	MILITALOTION	WV	WATER VALVE
		** *	**************************************

LEGEND


LEGEND				
DESCRIPTION	PROPOSED			
CATCH BASIN				
CURB INLET				
CLEANOUT STRUCTURE				
FIRE HYDRANT	~			
GUY ANCHOR	\leftarrow			
MANHOLE STRUCTURE				
WATER THRUST BLOCK	•			
WATER METER				
WATER VALVE	\otimes			
COMMUNICATION LINE	сомм			
ELECTRICAL LINE	———Е——			
FIBER OPTIC LINE	F0			
FIRE WATER LINE	———— FW————			
GAS LINE	G			
IRRIGATION LINE	IRR			
JOINT TRENCH LINE	JT			
OVERHEAD LINE	——— ОН ————			
RECYCLED WATER LINE	RW			
STORM DRAIN LINE	SD			
SANITARY SEWER LINE	ss			
TELEPHONE LINE	т			
CABLE TV LINE	TV			
WATER LINE	w			

SCHEMATIC IMPROVEMENT PLANS

FOR

APTOS LIBRARY

7695 SOQUEL DRIVE APTOS, CALIFORNIA

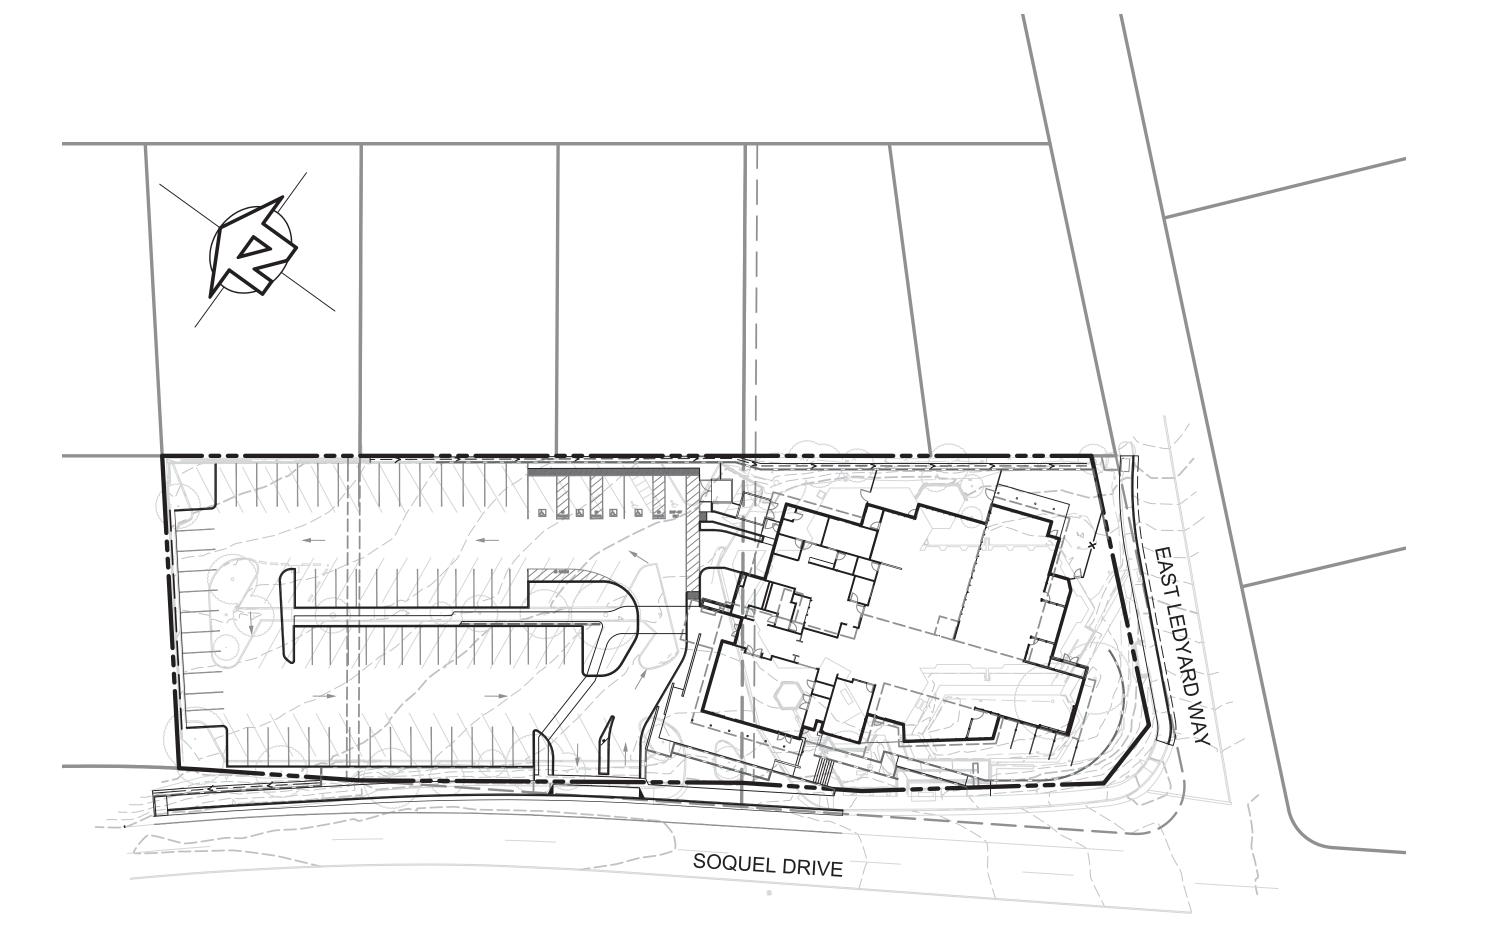

PLAN VIEW



Anderson Brulé


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NO.	DATE	REVISIONS
1	09/25/2020	50% SCHEMATIC DESIGN
2	10/08/2020	PLANNING SUBMITTAL
3	11/09/2020	PLANNING SUBMITTAL

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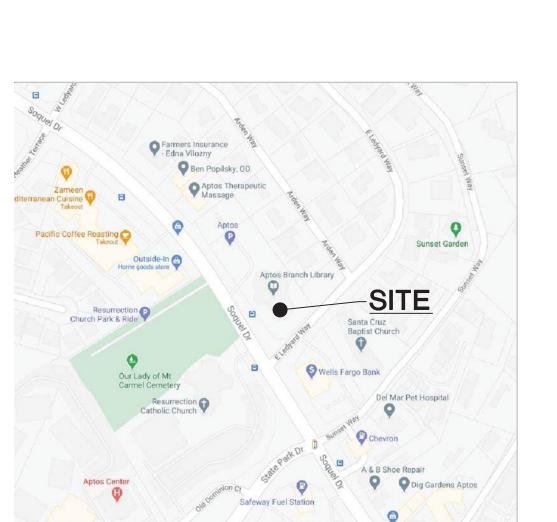
2004050

DATE:		9/25/
SHEET TI	TLE:	
SCHEMATIC	COVER SHEET	

SCALE:

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C0.0

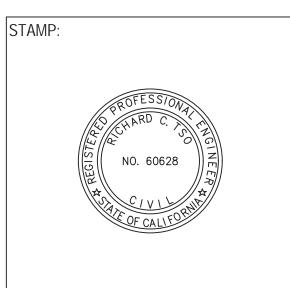

MAP DATA © GOOGLE

BENCHMARK

THE BENCHMARK FOR THIS SURVEY IS SANTA CRUZ COUNTY BENCHMARK "1991" #13, WHICH IS A BRASS DISK IN A MONUMENT BOX, LOCATED AT ALONG SOQUEL DRIVE,

BENCHMARK ELEVATION = 178.89' (NAVD88)

BASIS OF BEARINGS

THE BASIS OF BEARINGS FOR THIS SURVEY IS BETWEEN MONUMENTS #12 AND #13, FOUND ALONG SOQUEL DRIVE AS SHOWN ON THAT MAP FILED IN VOLUME 86 OF MAPS, AT PAGE 14, SANTA CRUZ COUNTY RECORDS.

DESCRIPTION


COVER SHEET


BASIS OF BEARINGS = S 31°53'00" E

INDEX OF SHEETS

SHEET NO.

TS-1	EXISTING SITE (SOUTH)
TS-2	EXISTING SITE (NORTH)
C1.0	SCHEMATIC SITE PLAN
C2.0	SCHEMATIC GRADING & DRAINAGE PLAN (NORTH)
C2.1	SCHEMATIC GRADING & DRAINAGE PLAN (SOUTH)
C3.0	SCHEMATIC UTILITY PLAN
C4.0	SCHEMATIC STORMWATER CONTROL PLAN
C4.1	SCHEMATIC STORMWATER MITIGATION DETAILS
C4.2	SCHEMATIC STORMWATER MITIGATION CALCULATIONS
C5.0	SCHEMATIC PLAN AND PROFILE - SOQUEL DR
C5.1	SCHEMATIC PLAN AND PROFILE - E. LEDYARD

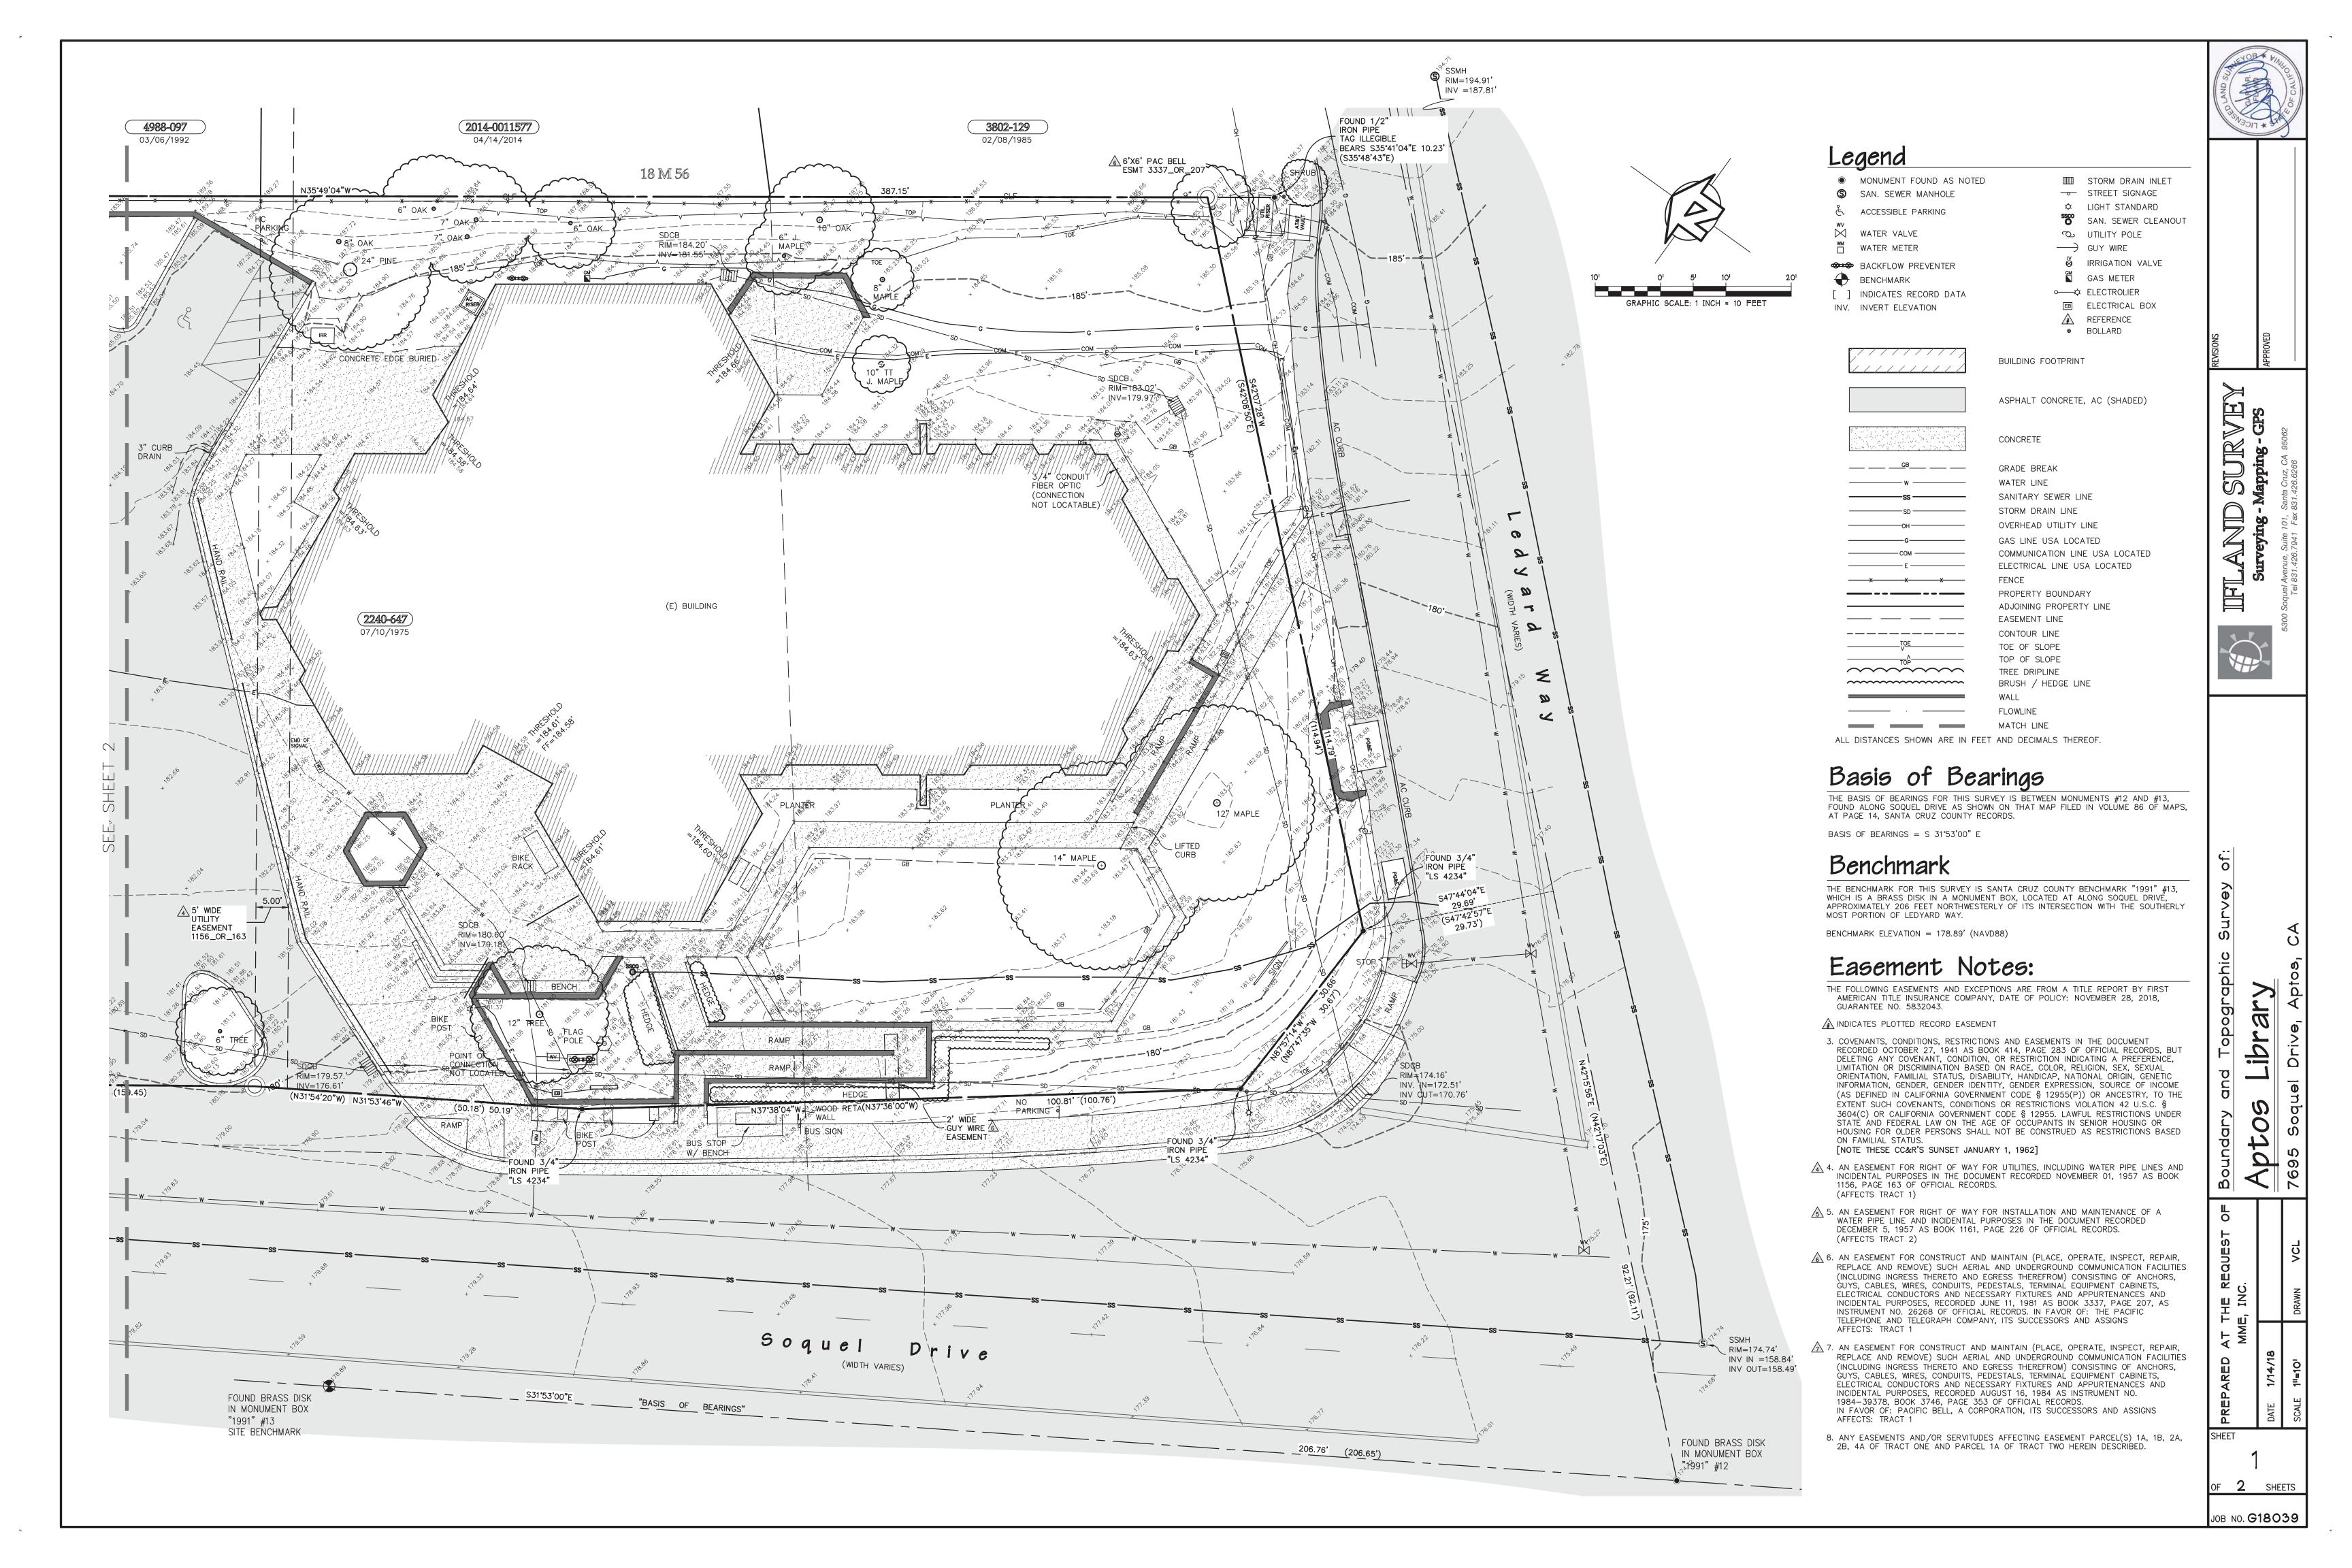

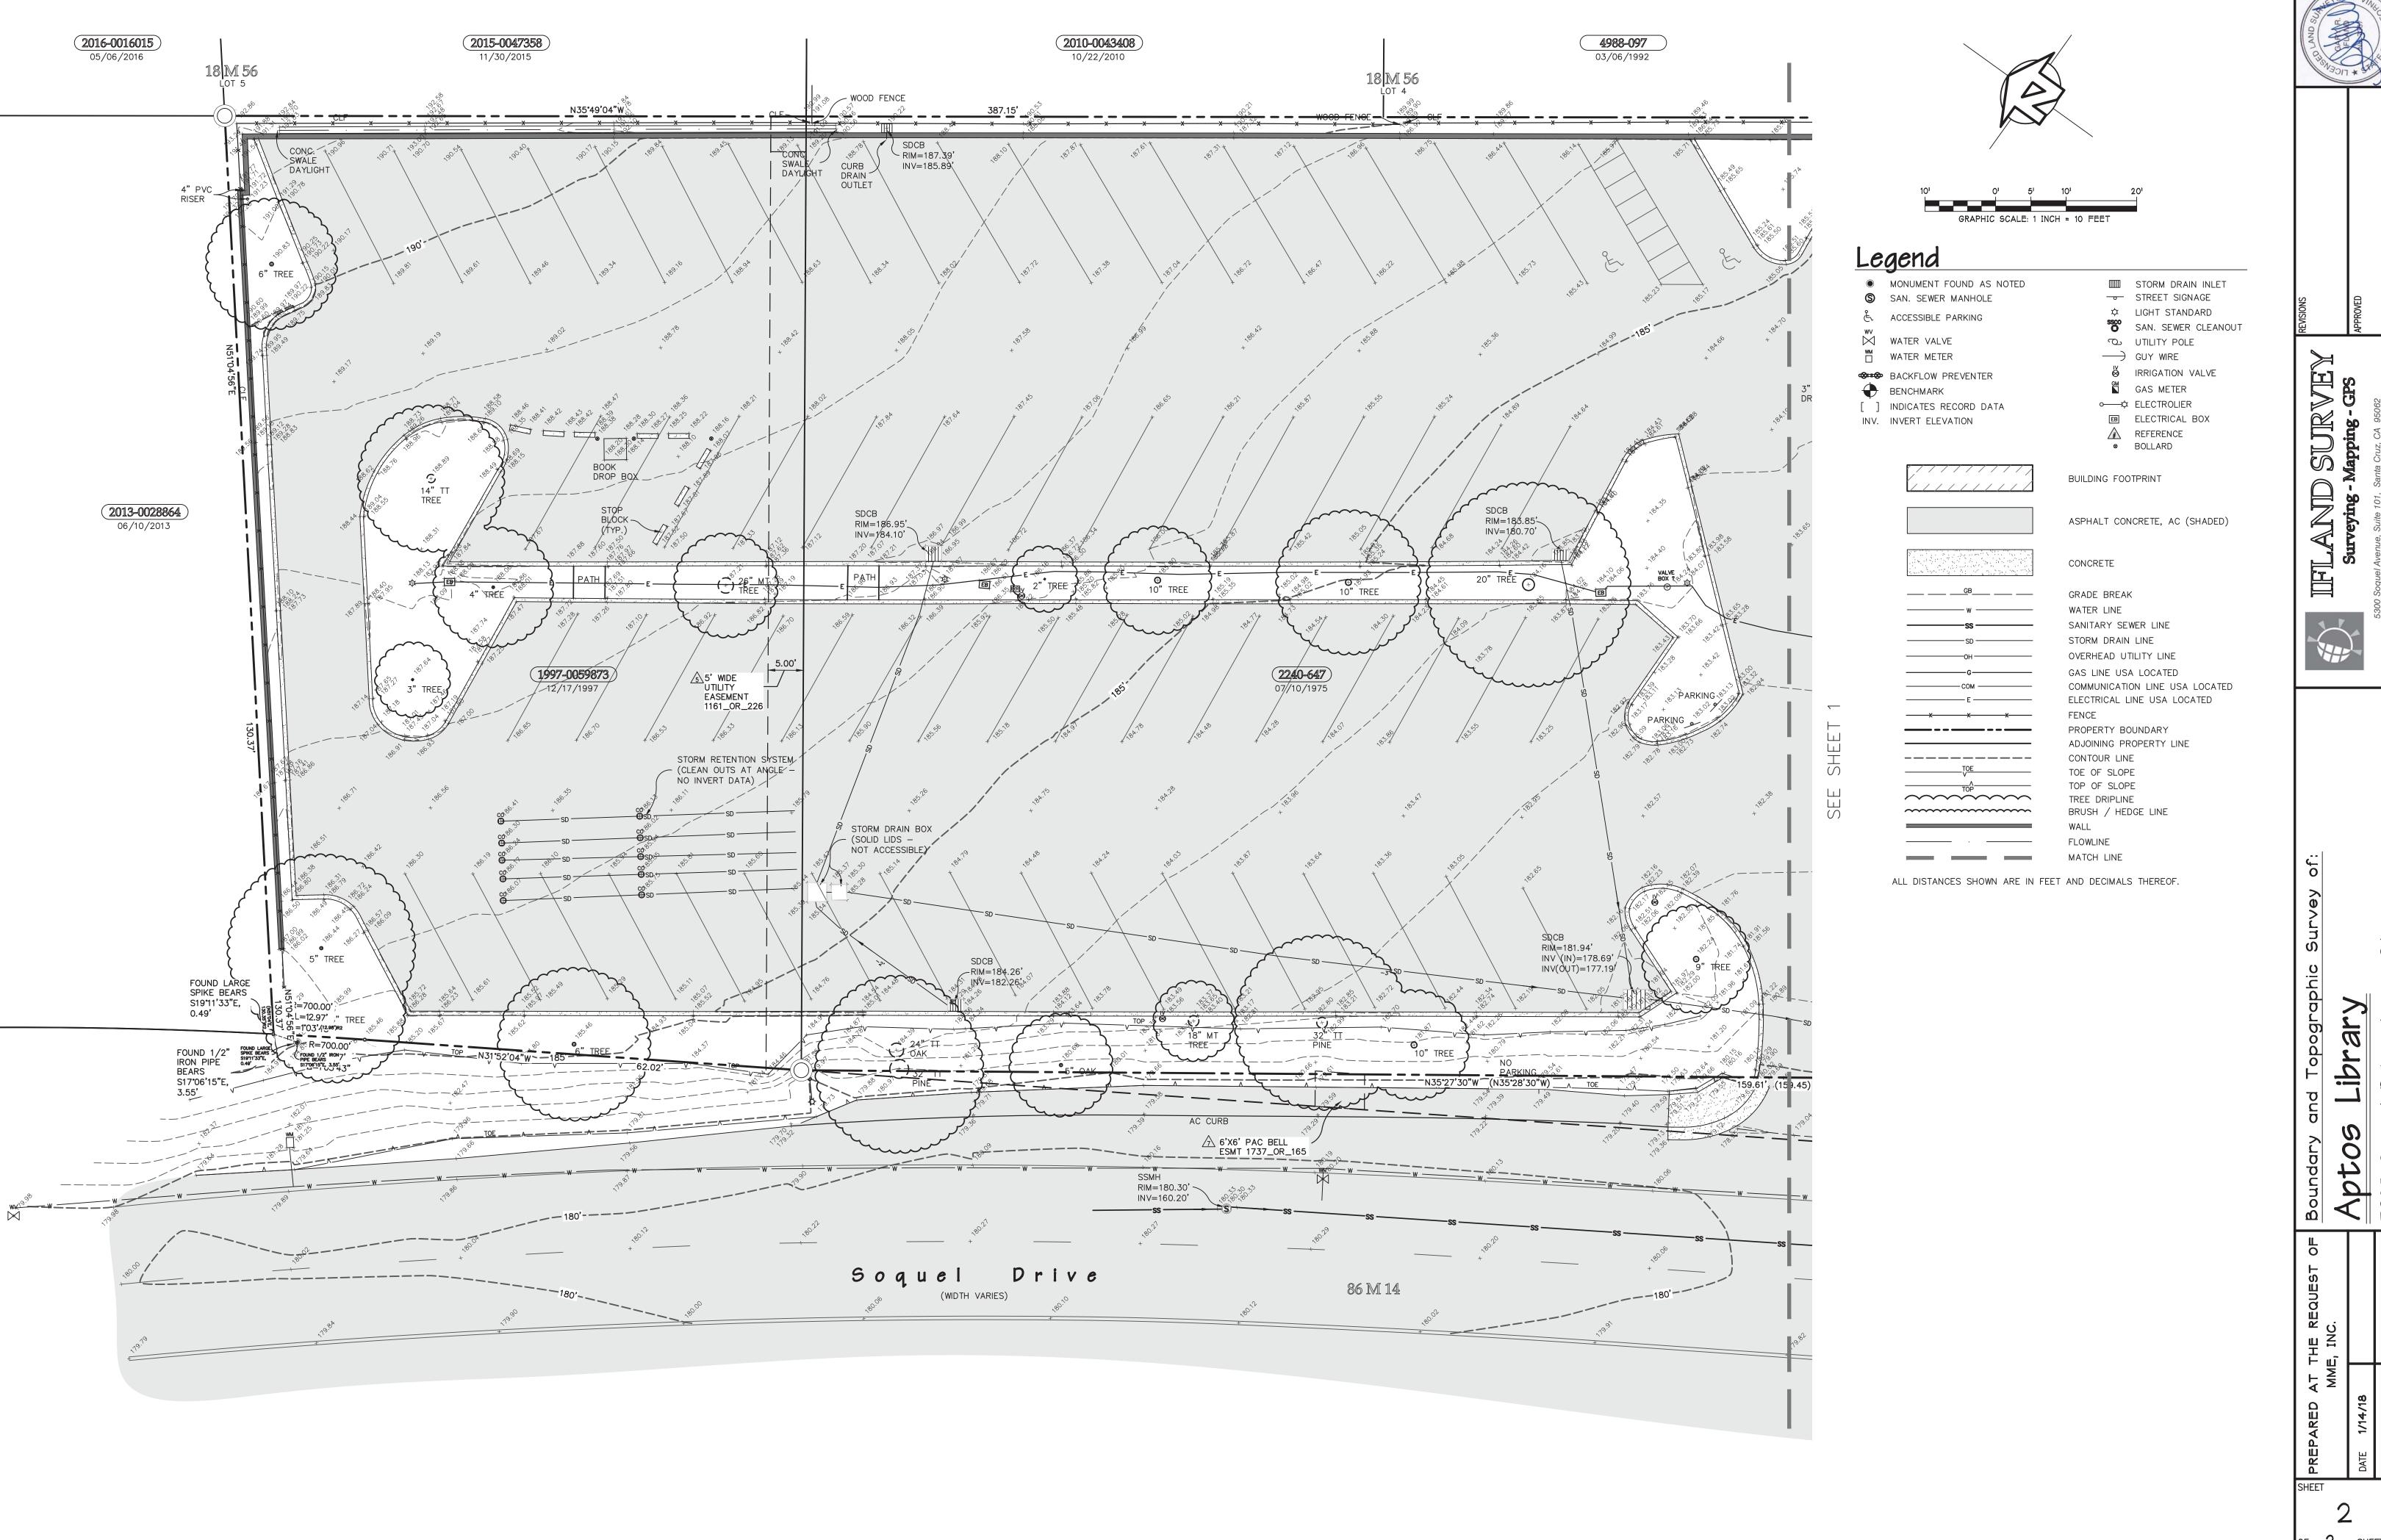

F 2 SHEETS

JOB NO. **G18039**

PARKING ANALYSIS

42 STANDARD STALLS COMPACT STALLS ADA VAN ACCESSIBLE STALL ADA STALLS STANDARD EV CHARGERS

ADA SIZE EV CHARGER

73 TOTAL STALLS

1. MAJORITY OF EXISTING RETAINING WALL ON NORTHERLY AND EASTERLY SIDE OF THE PROJECT TO REMAIN IN ORDER TO MINIMIZE DISTURBANCE TO ADJACENT RETAINED SOIL. PORTIONS TO BE REBUILT OVER EXISTING WALL LOCATION.
2. EXISTING FUNCTIONING STORM DRAIN DETENTION SYSTEM IN NORTH PARKING LOT TO

NOTES

- 3. EXISTING STREET CROSS SLOPE BETWEEN 7 AND 12% REWORK OF PAVEMENT SHOWN HATCHED IS REQUIRED TO CREATE 5% MAX CROSS-SLOPE FOR BIKE LANE PER COUNTY
- 4. ALL PARKING LOT CURBS IMMEDIATELY ADJACENT TO DRIVE AISLES SHALL BE PAINTED RED WITH "NO PARKING - FIRE LANE" STENCILED IN 4" WHITE LETTERS ON THE FACE OF
- 5. REFER TO LANDSCAPE PLANS FOR SITE ELEMENTS NOT SHOWN HEREON SUCH AS NEW TREES, PLANTINGS, DECORATIVE PAVING, AND SITE LIGHTING.
- 6. EXISTING PARKING LOT STALLS SHALL BE RE-STRIPED AS SHOWN HEREON.




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1	09/25/2020	50% SCHEMATIC DESIGN
2	10/08/2020	PLANNING SUBMITTAL
3	11/09/2020	PLANNING SUBMITTAL

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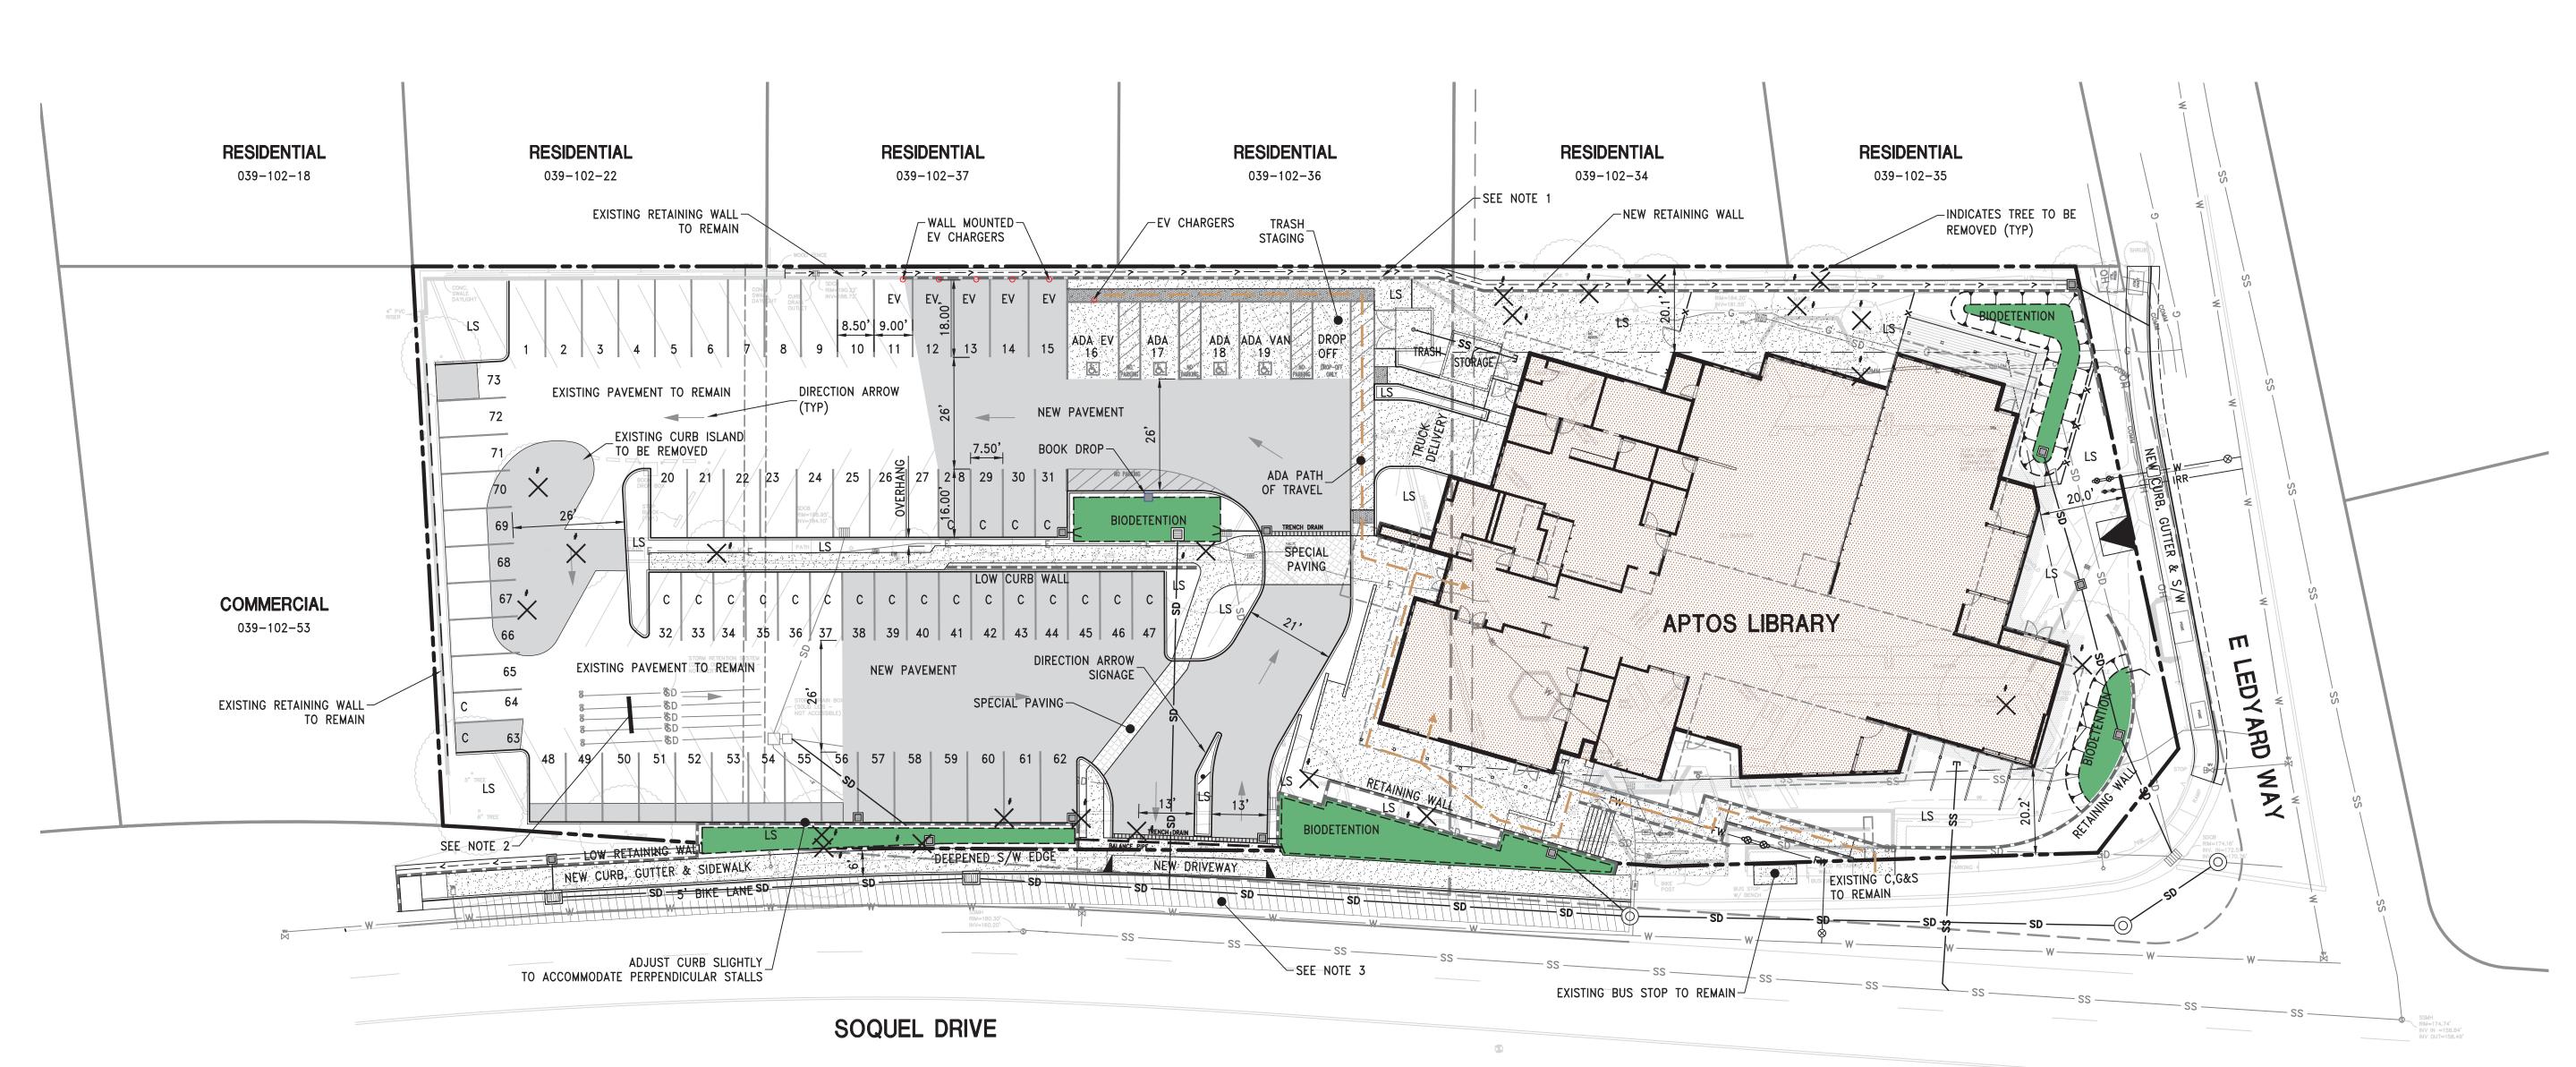
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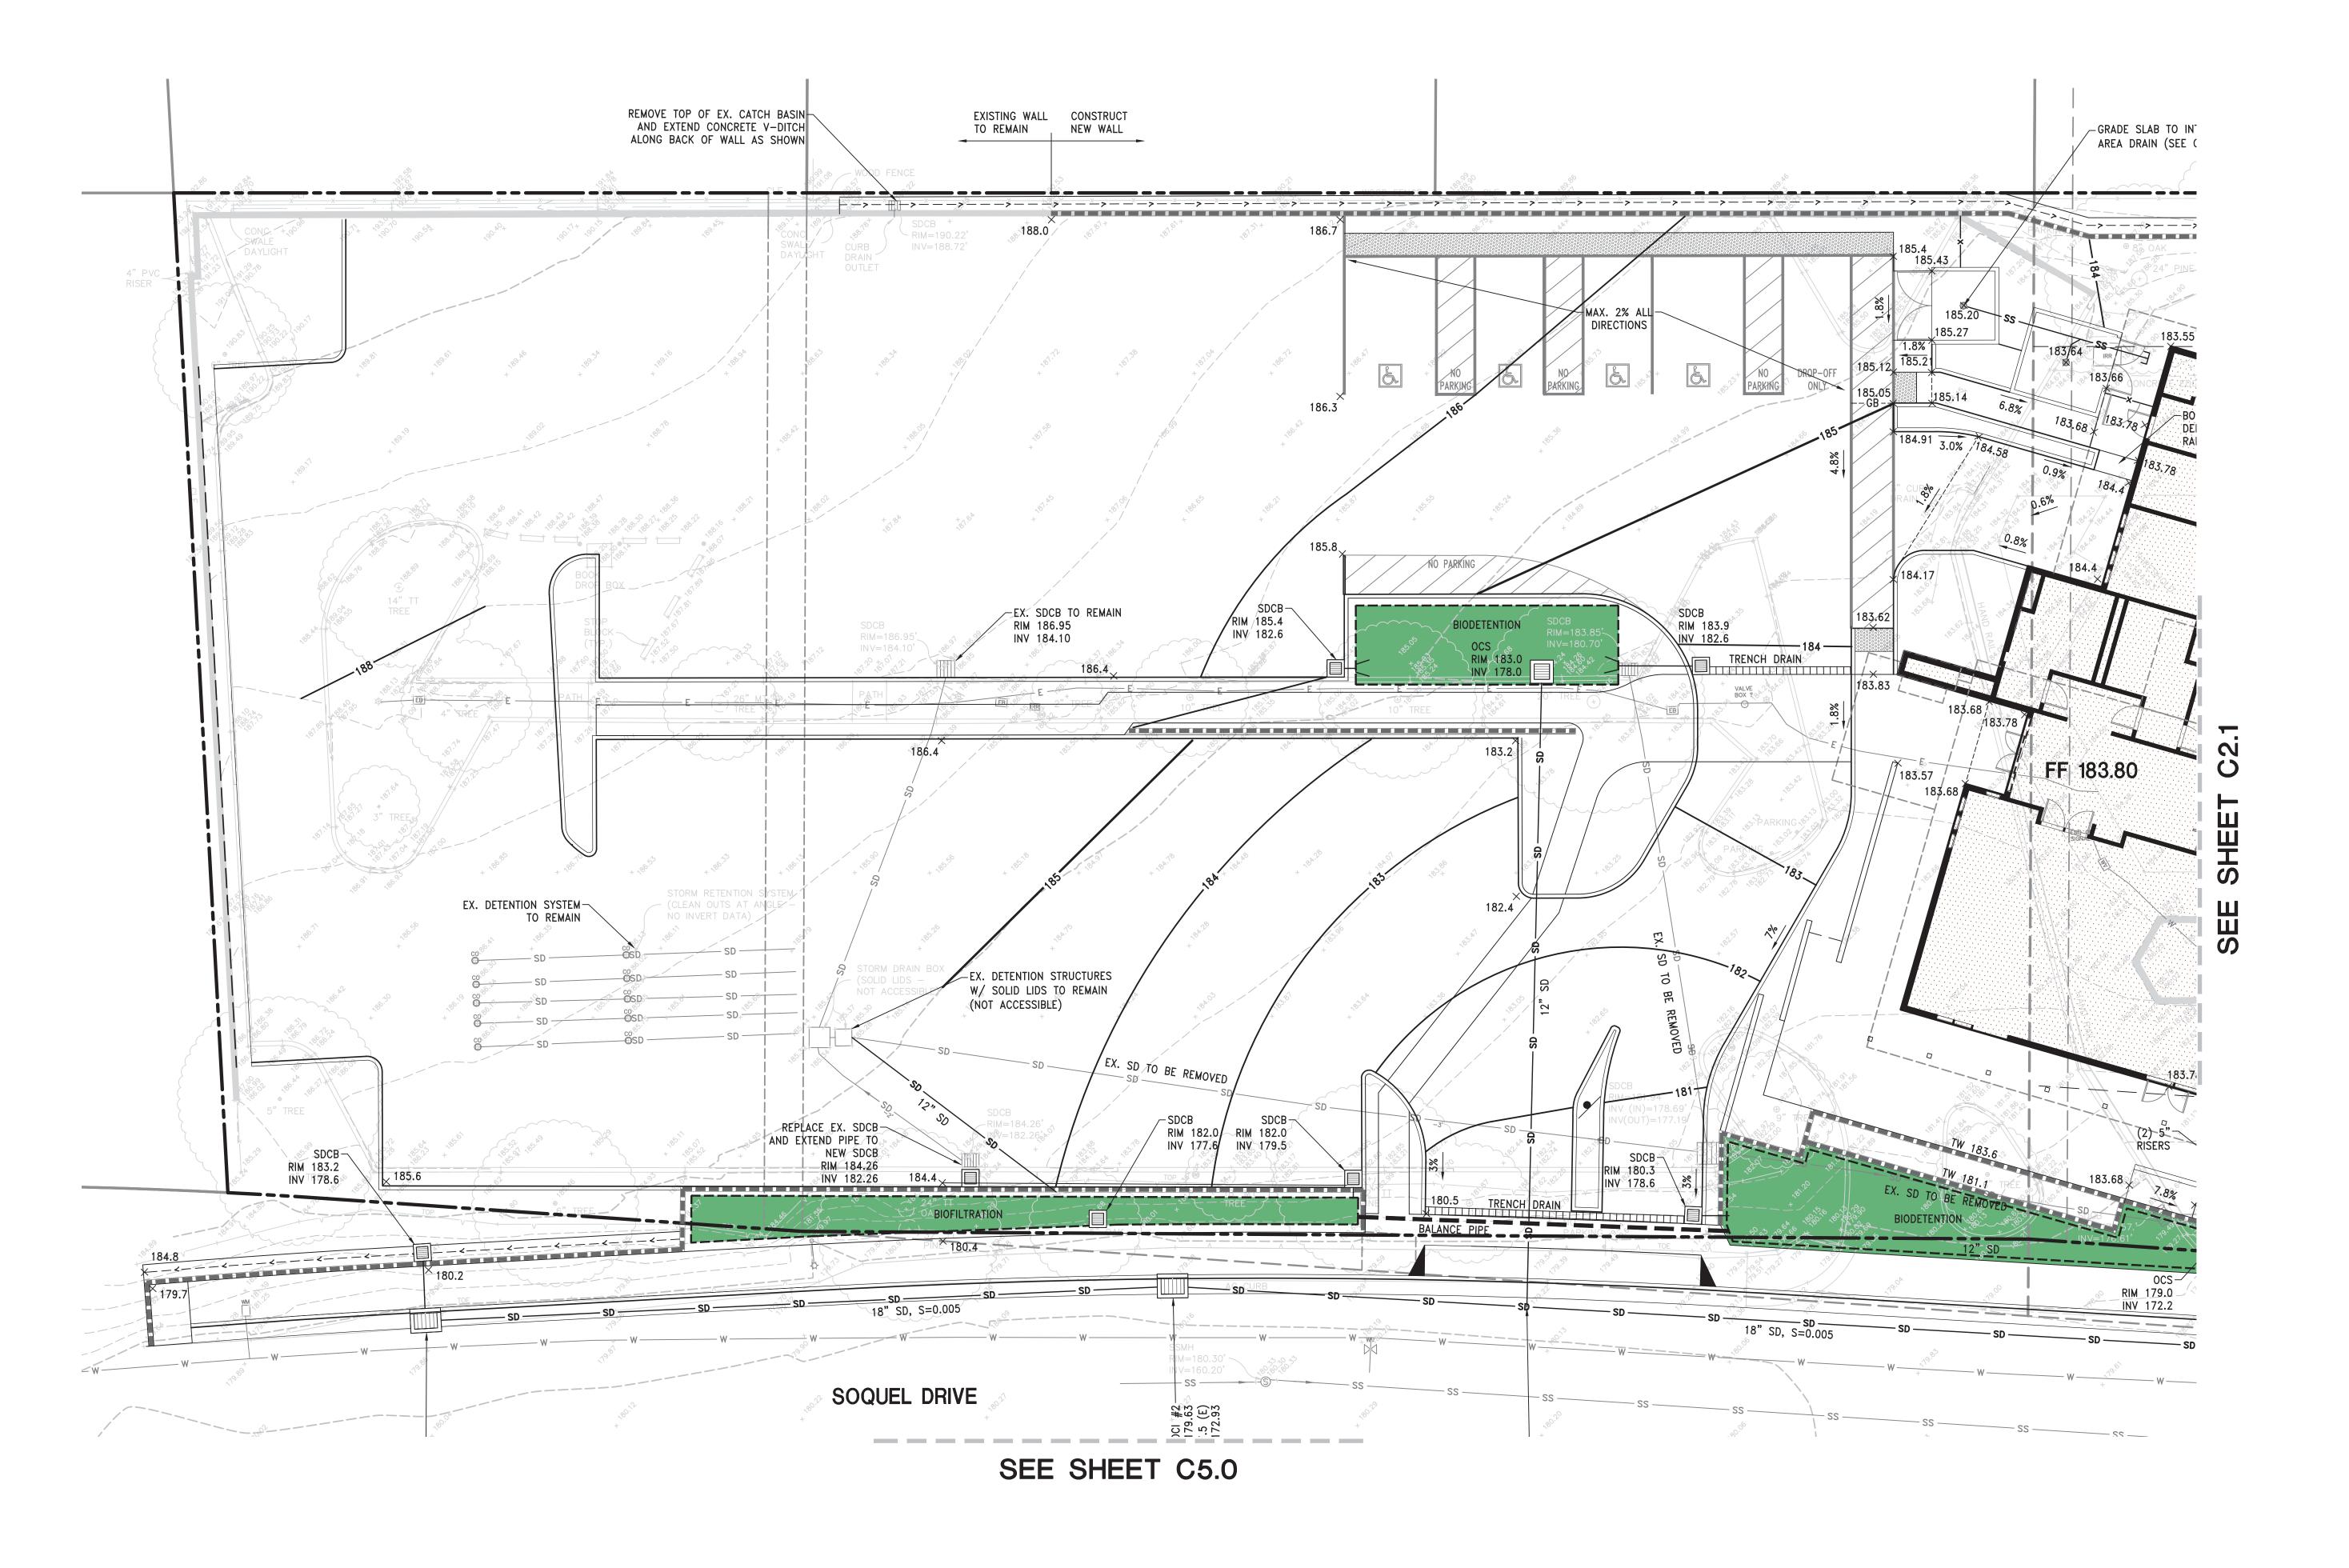
PROJECT	NO.	200405
DATE:		9/25/202
SHEET TIT	LE:	
SCHEMATIC	SITE F	PLAN

SCALE:

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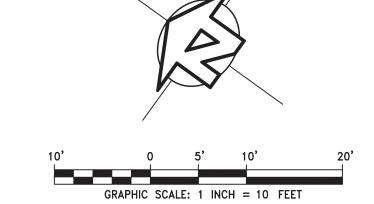
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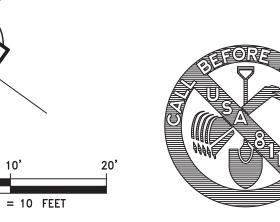


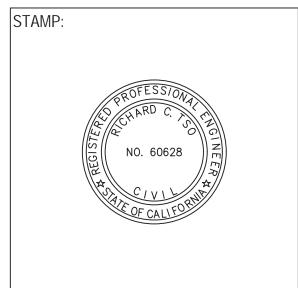

<u>NOTES</u>

- APPROXIMATELY 5,110 CY OF OVER-EXCAVATION CUT REQUIRED PER SOILS REPORT.
 APPROXIMATELY 2,150 CY OF RE-WORKED FILL REQUIRED PER SOILS REPORT. NATIVE FILL
- MATERIAL PROPOSED WHILE SUBJECT TO SOILS FIELD REVIEW AND APPROVAL.
- 3. APPROXIMATELY 300 CY OF SOIL EXPORT FROM PARKING LOT GRADING AND TRENCH SPOILS.
- 4. APPROXIMATELY 400 CY OF SOIL EXPORT FROM BIODETENTION FACILITIES.
 5. REFER TO C4.0 FOR STORMWATER CONTROL PLAN INFORMATION







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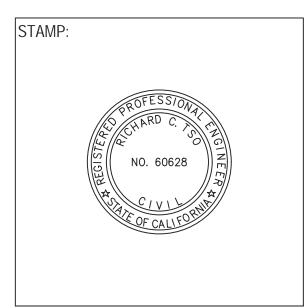
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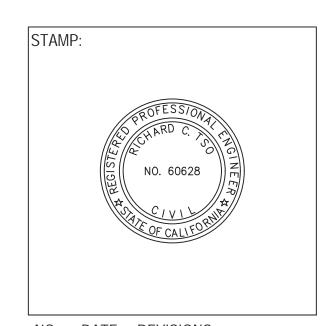
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ATIC	GRADIN	1G &

DRAINAGE
PLAN
(SOUTH)

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C2.1

FIRE FLOW DATA					
	FLOW DATA P	ROVIDED BY SOQUEL C	REEK WATER DISTRICT	09/12/2020.	
HYDRANT #	STATIC PRESSURE (PSI)	RESIDUAL PRESSURE (PSI)	FLOW (GPM)	FLOW @ 20PSI (GPM)	TEST DATE
30	99	94	964	3831	AUG 2002
35	NO	DATA	AVAILABLE		
1170	100	55	1087	1450	JAN 2002

NOTES:

- 1. ALL DOMESTIC, FIRE, AND IRRIGATION SERVICES SHALL BE INSTALLED PER SOQUEL CREEK WATER
- 2. ALL SANITARY SEWER LATERALS SHALL BE INSTALLED PER COUNTY SANITATION DISTRICT STANDARDS. 3. EXISTING WATER MAINS IN SOQUEL DRIVE AND EAST LEDYARD WAY ARE SCHEDULED FOR REPLACEMENT AND RELOCATION PER SOQUEL CREEK WATER DISTRICT PLANS, CWO 16-008, DATED MAY 21, 2020. SHOULD THESE IMPROVEMENTS BE INSTALLED PRIOR TO FINAL DESIGN OF THE LIBRARY, THE UTILITY PLAN WILL BE MODIFIED ACCORDINGLY TO SHOW THE RELOCATED WATER MAINS, AND ADJUST NEW UTILITIES SERVING THE LIBRARY AS MAY BE APPROPRIATE. SUPPLEMENTAL SURVEY OF THE RELOCATED MAINS WILL BE REQUIRED PRIOR TO FINAL UTILITY DESIGN.




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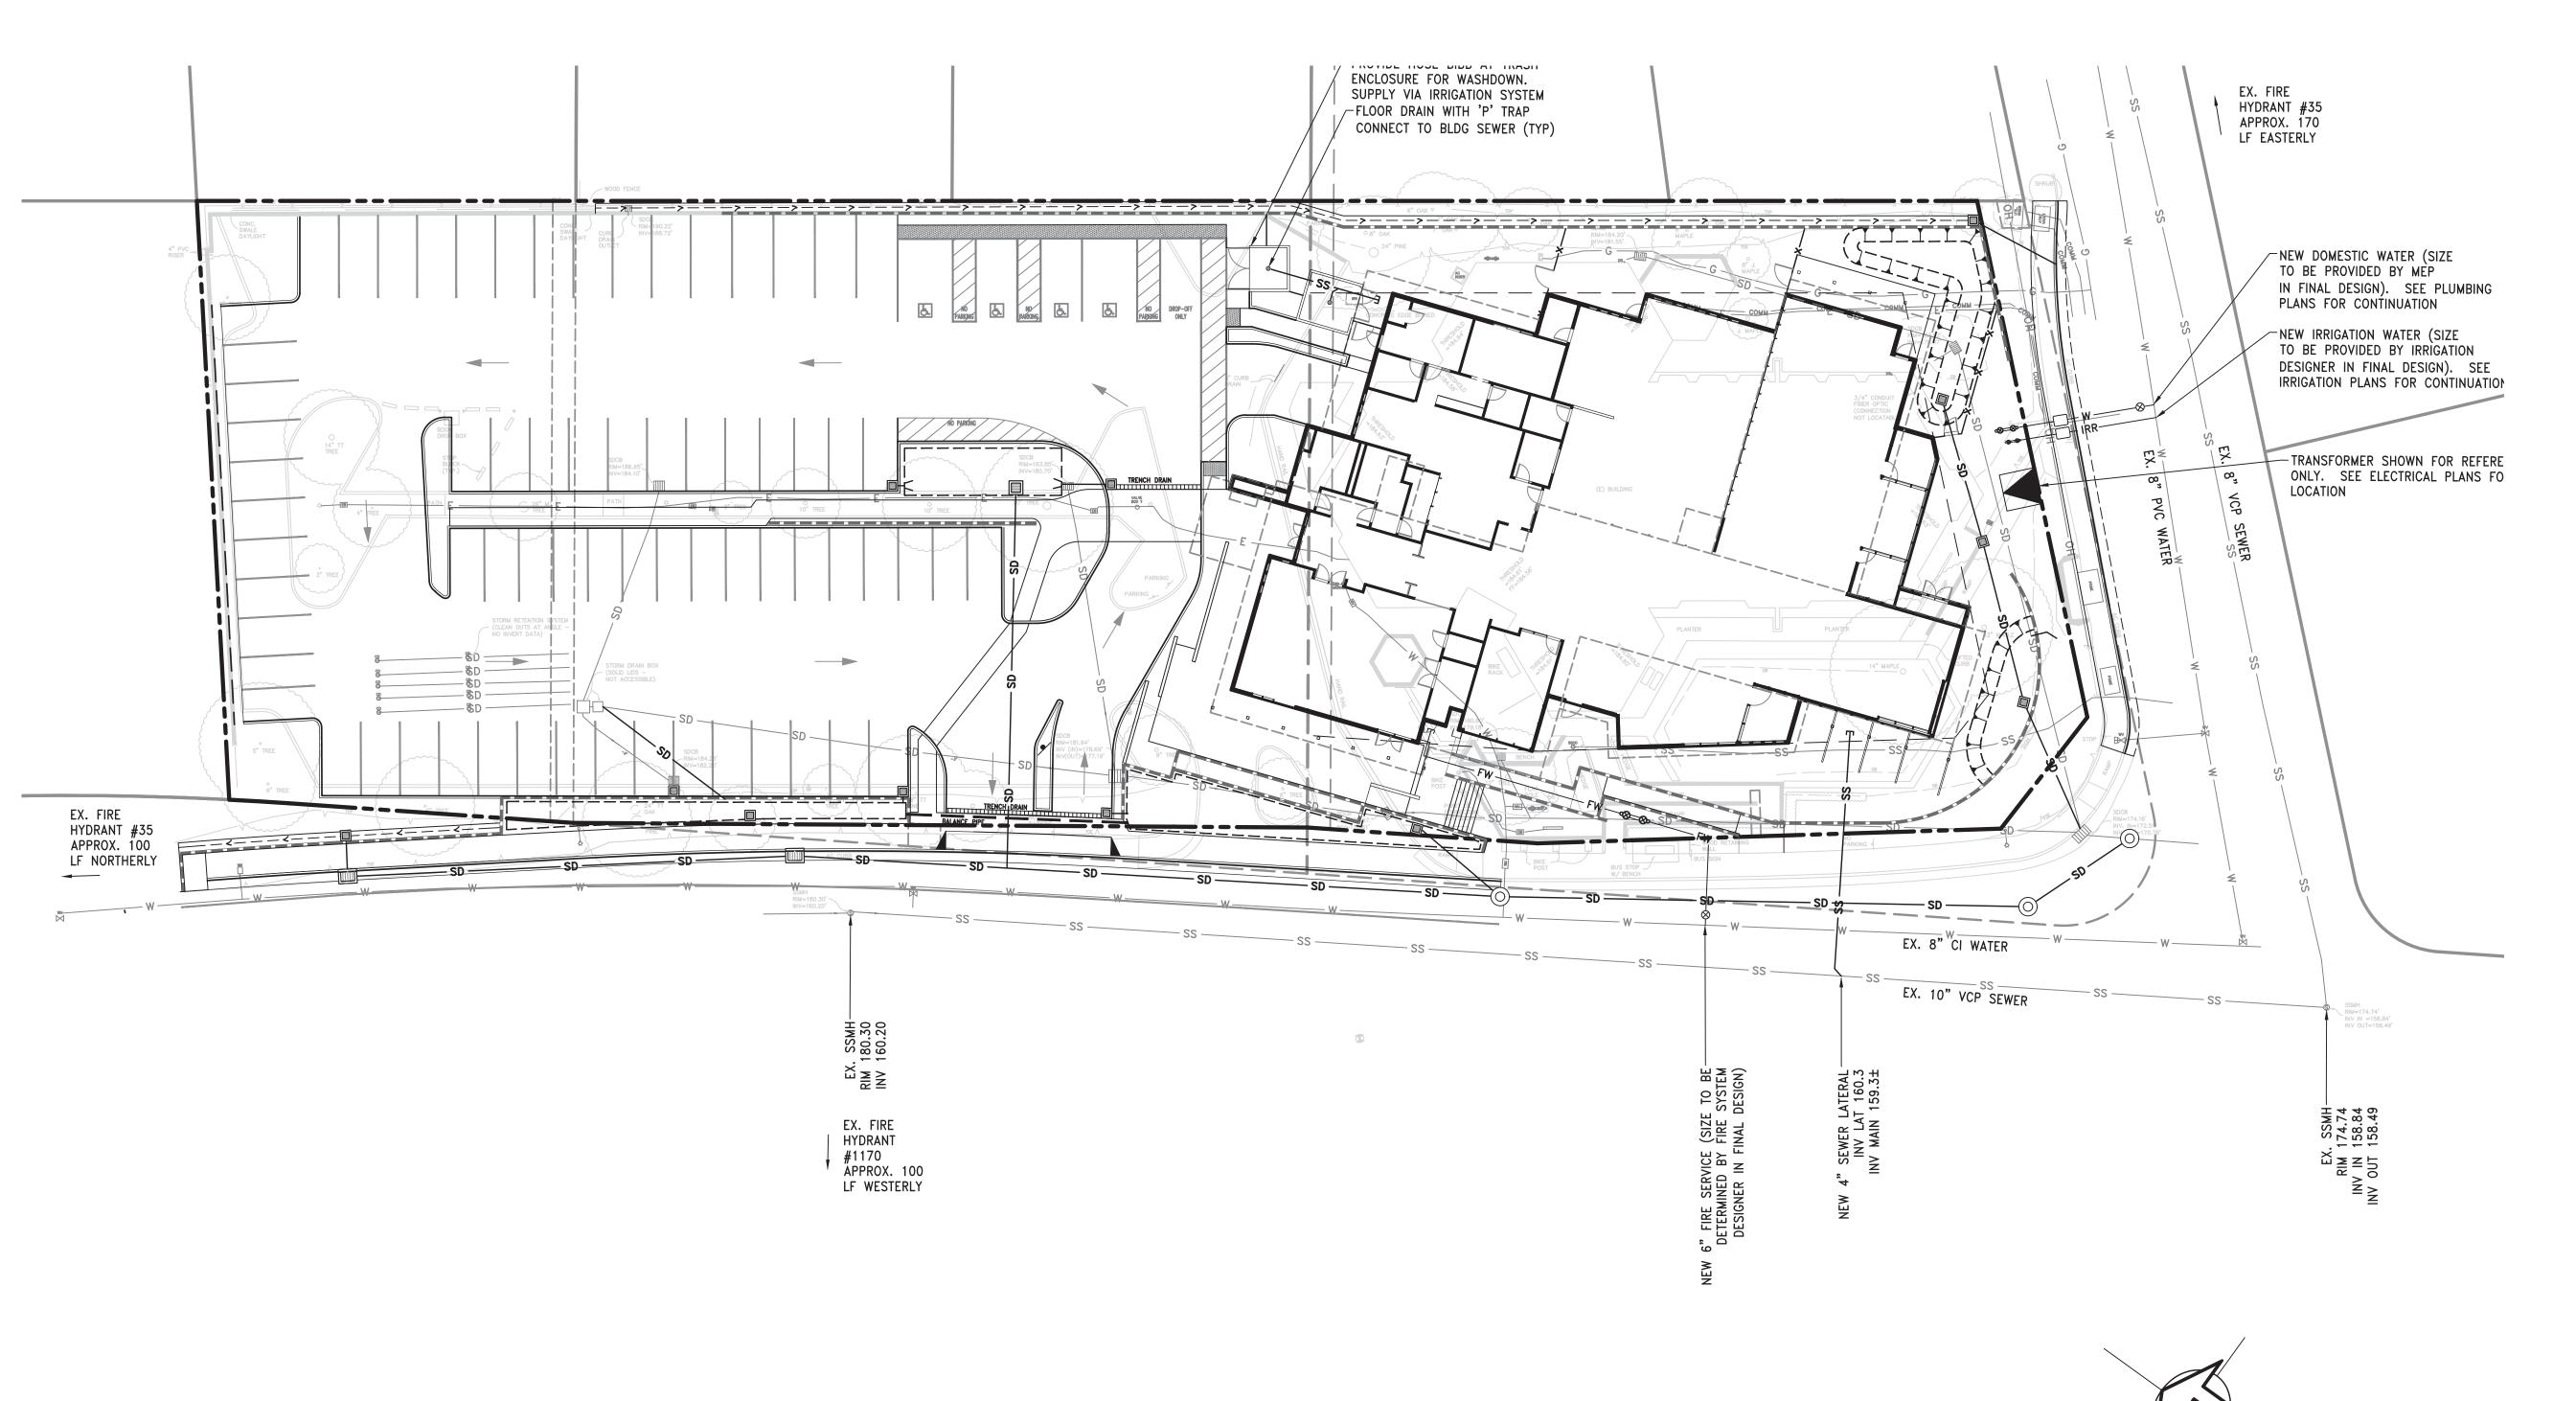
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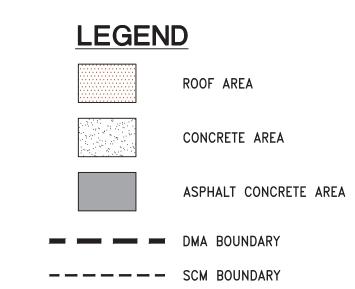
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SHEET TITI	LE:	
SCHEMATIC	UTILITY PLAN	

SCALE:

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C3.0



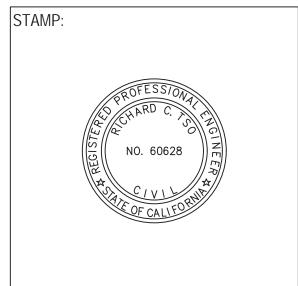

NOTES:

- 1. TREATMENT OF RUNOFF FROM IMPERVIOUS SURFACES WILL BE PROVIDED VIA RAINGARDENS DISTRIBUTED AROUND THE SITE (SCM's 1-4).
- 2. ONSITE RETENTION IS INFEASIBLE DUE TO THE VERY LOW INFILTRATION RATES DETERMINED BY THE SOILS ENGINEER AS DESCRIBED IN APPENDIX B OF THE COUNTY PROVIDED SOILS REPORT BY PACIFIC CREST ENGINEERS, DATED NOVEMBER 2019.
- 3. DETENTION WILL BE PROVIDED VIA CUDO CUBES, ARCH CHAMBERS, OR CLEAN, WASHED, ANGULAR DRAIN ROCK LOCATED WITHIN EACH SCM AND BELOW THE REQUIRED BIOSOIL MIX, WITH THE EXCEPTION OF THE UPPER PARKING LOT WHICH HAS ITS OWN DETENTION SYSTEM CONSTRUCTED IN 2009. REFER TO C4.2 FOR SIZING CALCULATIONS.
- 4. SAFE OVERFLOW OF 25-YEAR DESIGN STORM EVENTS IS PROVIDED VIA THE ON-SITE PIPE NETWORK THAT IS SIZED TO ACCOMMODATE SUCH FLOWS.
- 5. PERVIOUS PAVEMENT IS NOT PROPOSED FOR PARKING STALLS DUE TO EXCESSIVE SLOPES.
- 6. REFER TO C2.0 AND C2.1 FOR DRAINAGE SYSTEM DESIGN INFORMATION.
- 7. REFER TO THE PRELIMINARY STORMWATER REPORT FOR DOWNSTREAM ASSESSMENT.

		7.11.1.
ROOF	0.9	0 SF
HARDSCAPE	0.9	8662 SF
LANDSCAPE	0.3	279 SF
TOTAL AREA	i=	8941 SF
TOTAL IMPERVIOUS AREA	0.9	8662 SF
MIN. RG @ 4%		346 SF
RG PROVIDED		352 SF
DMA 2 AREA		Act San Country
	С	AREA

DMA 1 AREA BREAKDOWN

	С	AREA
ROOF	0.9	4284 SF
HARDSCAPE	0.9	16664 SF
LANDSCAPE	0.3	1368 SF
TOTAL AREA	-	22316 SF
TOTAL IMPERVIOUS AREA	0.9	20948 SF
MIN. RG @ 4%		838 SF
RG PROVIDED		1010 SF

DMA 3 AREA	BREAK	NWOC
	С	AREA
ROOF	0.9	6349 SF
HARDSCAPE	0.9	244 SF
LANDSCAPE	0.3	2300 SF
TOTAL AREA	3 	8893 SF
TOTAL IMPERVIOUS AREA	0.9	6593 SF
MIN. RG @ 4%		264 SF
RG PROVIDED		265 SF

	С	AREA
ROOF	0.9	3390 SI
HARDSCAPE	0.9	0 SF
LANDSCAPE	0.3	877 SF
TOTAL AREA	_	4267 S
TOTAL IMPERVIOUS AREA	0.9	3390 S
MIN. RG @ 4%		136 SF
RG PROVIDED		200 SF

*NOTE: HARDSCAPE INCLUDES CONCRETE AND AC SURFACES

OOF	0.9	4284 SF	
SCAPE	0.9	16664 SF	CONCLUTANTS LOCO.
SCAPE	0.3	1368 SF	CONSULTANTS LOGO:
L AREA	_	22316 SF	
MPERVIOUS REA	0.9	20948 SF	OC IFLAND
G @ 4%		838 SF	ENGINEERS
ROVIDED		1010 SF	5300 SOQUEL AVE, SUITE 101 SANTA CRUZ, CA 95062
			TEL (831) 426-5313
MA 3 AREA	BREAK	DOWN	FAX (831) 426-1763
	atini area	O SUCCESSION OF	1

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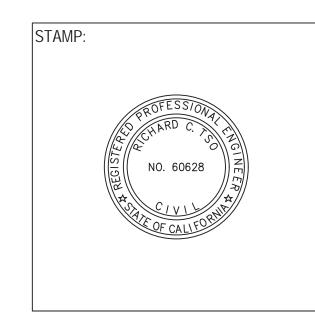
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NO.	DATE	REVISIONS
1	09/25/2020	50% SCHEMATIC DESIGN
2	10/08/2020	PLANNING SUBMITTAL
3	11/09/2020	PLANNING SUBMITTAL

PROJECT TITLE:


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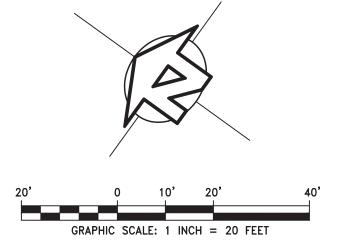
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DATE:		9/25/2020
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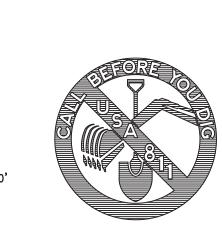
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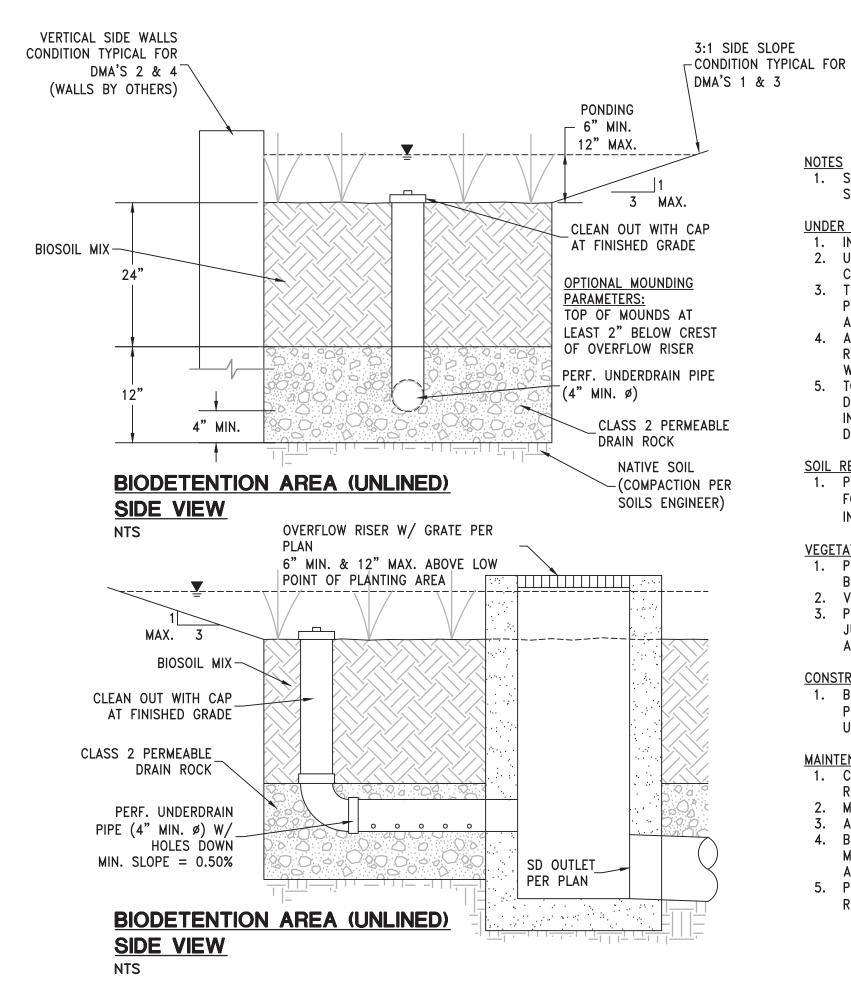
C4.0



SOQUEL DRIVE





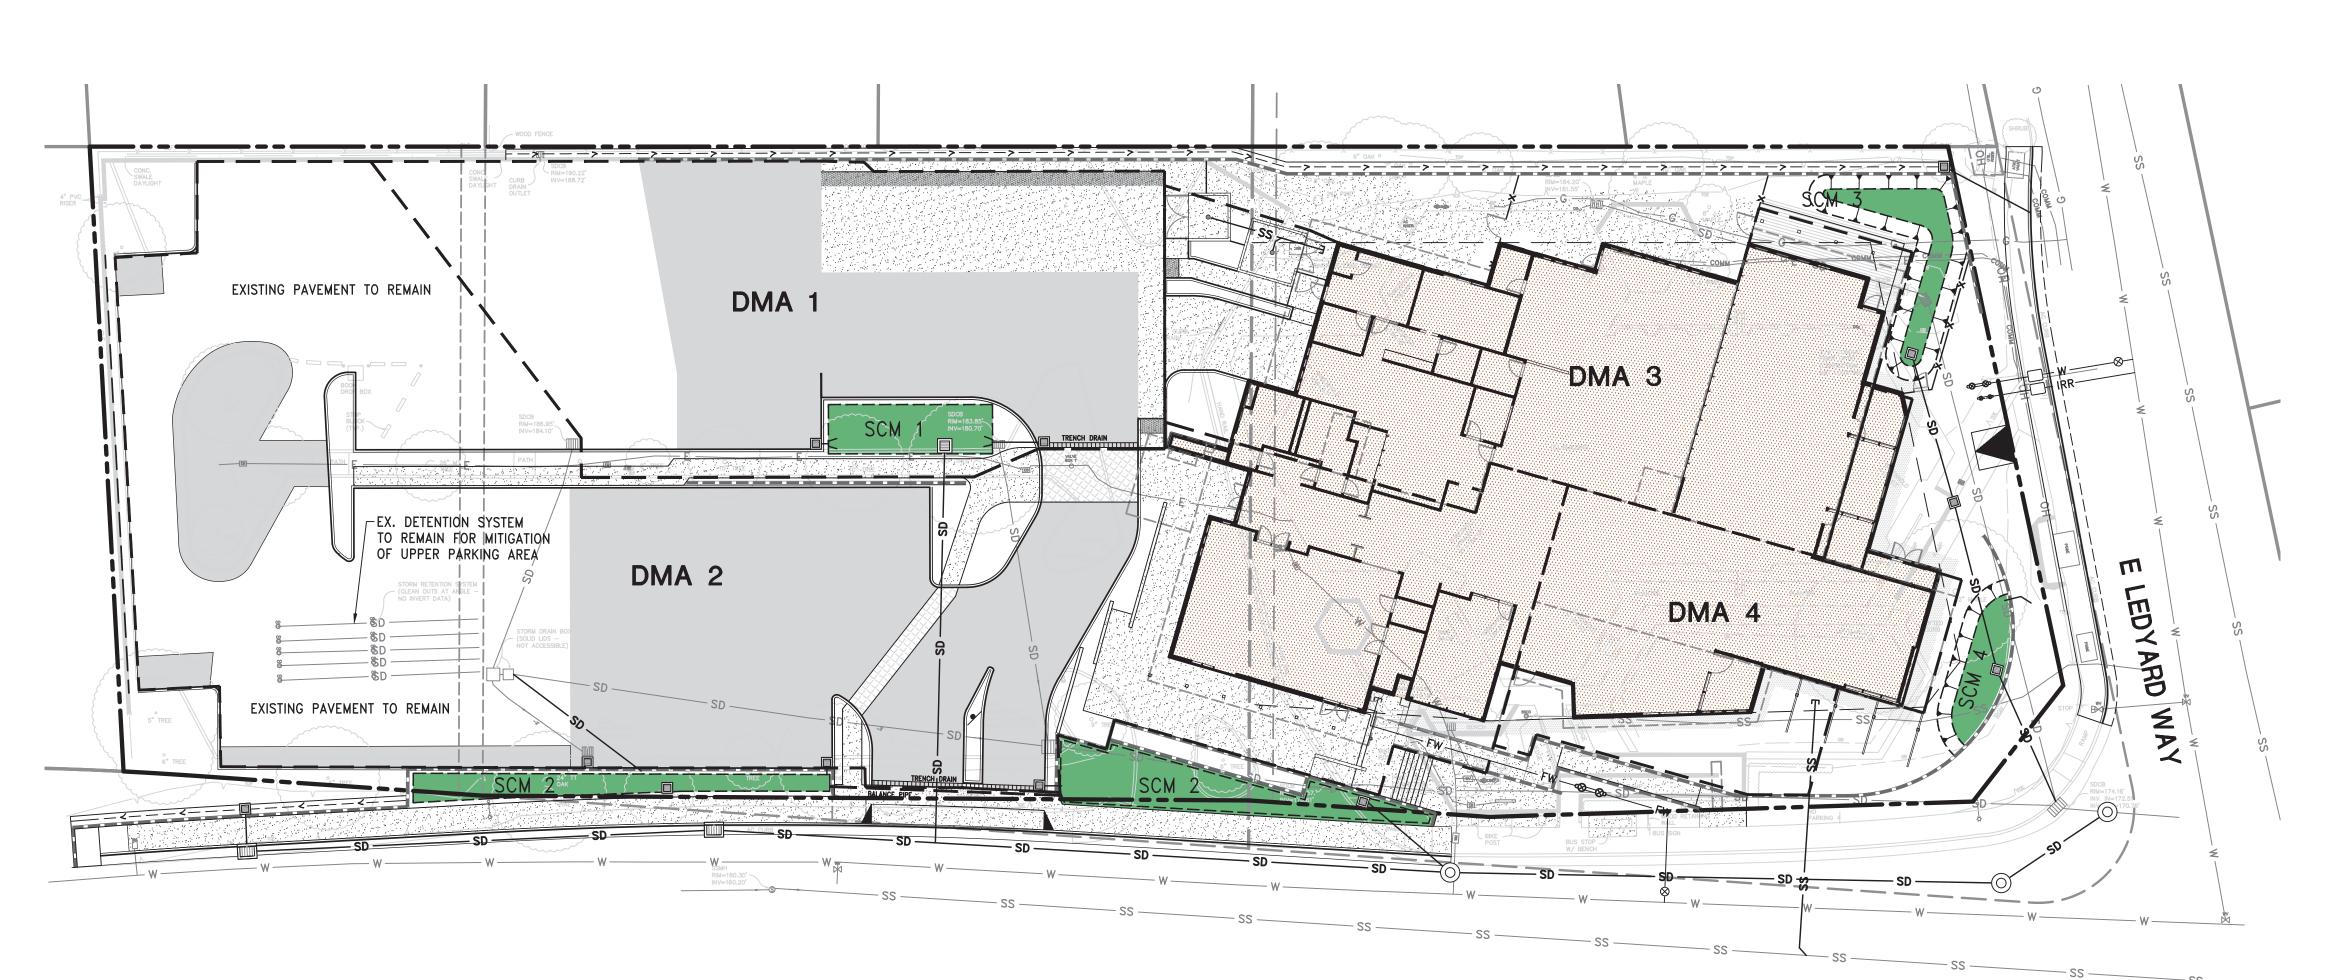

1. SURFACE OF THE PLANTING BED SHALL BE RELATIVELY LEVEL BUT MAY HAVE A SLIGHT SLOPE TO DISTRIBUTE WATER THROUGHOUT SURFACE AREA. UNDER DRAIN AND OVERFLOW 1. INSTALL WATERPROOFING AS NECESSARY TO PROTECT ADJACENT BUILDING WALLS.

2. UNDER DRAIN SHALL CONSIST OF A MINIMUM 4 INCH DIAMETER PERFORATED PIPE WITH CLEANOUTS AND CONNECTION TO A STORM DRAIN OR DISCHARGE POINT. 3. THE UNDER DRAIN TRENCH SHALL INCLUDE A MINIMUM 12 INCH THICK LAYER OF CLASS 2

PERMEABLE DRAIN ROCK. PLACE UNDER DRAIN WITH PERFORATIONS FACING DOWNWARD, AT

4. A CLEANOUT FOR THE UNDER DRAIN SHALL BE PROVIDED, CONSISTING OF A VERTICAL, RIGID, NON PERFORATED PVC PIPE, WITH A MINIMUM DIAMETER OF 4 INCHES AND A WATERTIGHT CAP FIT FLUSH WITH THE PLANTER BED SURFACE.

5. TO AVOID CLOGGING, FILTER FABRIC SHALL NOT BE USED IN OR AROUND THE THE UNDER DRAIN OR BETWEEN THE BIOTREATMENT SOIL MIX AND THE DRAIN ROCK. IF DESIRED, A 2 INCH PEA GRAVEL LAYER MAY BE USED BETWEEN THE BIOTREATMENT SOIL MIX AND THE DRAIN ROCK.

SOIL REQUIREMENTS

A MINIMUM 0.5% SLOPE.

1. PLANTING SOILS SHALL MEET THE BIOTREATMENT SOIL MIX SPECIFICATIONS APPROPRIATE FOR THE JURISDICTION. A MINIMUM INFILTRATION RATE OF 5 IN/HR AND A MAXIMUM INFILTRATION RATE OF 10 IN/HR ARE REQUIRED.

1. PLANT SPECIES SELECTED SHALL BE SUITABLE FOR BIODETENTION AREA LOCATION, BIOTREATMENT SOILS AND OCCASIONAL INUNDATION.

2. VEGETATION SHOULD NOT BLOCK INFLOW, CREATE SAFETY ISSUES OR OBSTRUCT FACILITIES. 3. PLANTING SELECTIONS ARE SUBJECT TO THE LANDSCAPING REQUIREMENTS OF THE LOCAL JURISDICTION AND SHALL BE SELECTED BY A LICENSED LANDSCAPE ARCHITECT OR

CONSTRUCTION REQUIREMENTS 1. BIODETENTION AREAS ARE NOT INTENDED TO WORK AS CONSTRUCTION PHASE BMP'S. PROTECT THE AREA FROM CONSTRUCTION SITE RUNOFF; DIVERT RUNOFF FROM UNSTABILIZED AREAS AWAY FROM COMPLETED BIORETENTION AREAS.


1. CONDUCT BIANNUAL EVALUATION OF THE HEALTH OF THE VEGETATION AND REMOVE AND

REPLACE DEAD OR DYING PLANTS. MAINTAIN VEGETATION AND THE IRRIGATION SYSTEM.

AVOID THE USE OF PESTICIDES AND QUICK RELEASE SYNTHETIC FERTILIZERS.

4. BEFORE THE WET SEASON BEGINS, VERIFY THAT THERE IS SUFFICIENT BIOTREATMENT SOIL MEDIA TO EFFECTIVELY FILTER STORMWATER. REMOVE ACCUMULATIONS OF SEDIMENT, LITTER AND DEBRIS AS NECESSARY.

5. PERIODICALLY CHECK DOWNSPOUTS, INLETS AND OVERFLOW PIPING. REMOVE DEBRIS AND REPAIR/REPLACE DAMAGED OR DISCONNECTED PIPES.

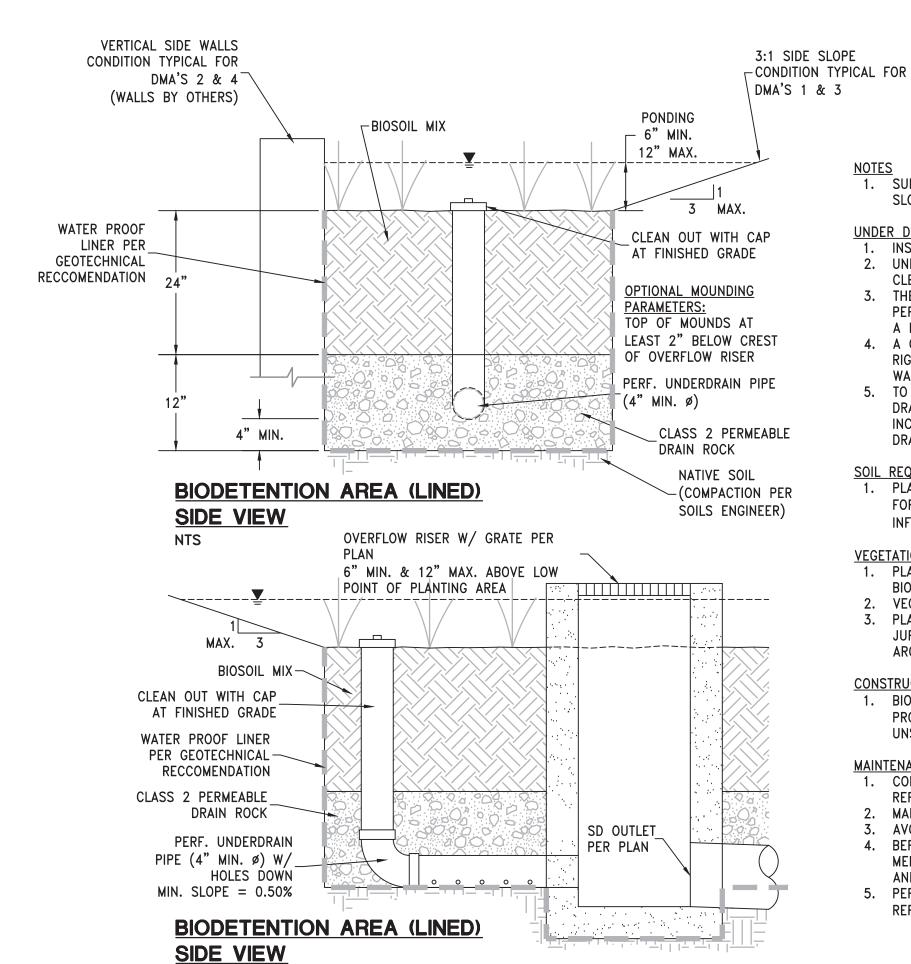

NTS

1. SURFACE OF THE PLANTING BED SHALL BE RELATIVELY LEVEL BUT MAY HAVE A SLIGHT SLOPE TO DISTRIBUTE WATER THROUGHOUT SURFACE AREA.

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<u>MAINTENANCE</u>

1. CONDUCT BIANNUAL EVALUATION OF THE HEALTH OF THE VEGETATION AND REMOVE AND REPLACE DEAD OR DYING PLANTS.

2. MAINTAIN VEGETATION AND THE IRRIGATION SYSTEM.

3. AVOID THE USE OF PESTICIDES AND QUICK RELEASE SYNTHETIC FERTILIZERS.

4. BEFORE THE WET SEASON BEGINS, VERIFY THAT THERE IS SUFFICIENT BIOTREATMENT SOIL MEDIA TO EFFECTIVELY FILTER STORMWATER. REMOVE ACCUMULATIONS OF SEDIMENT, LITTER AND DEBRIS AS NECESSARY.

5. PERIODICALLY CHECK DOWNSPOUTS, INLETS AND OVERFLOW PIPING. REMOVE DEBRIS AND REPAIR/REPLACE DAMAGED OR DISCONNECTED PIPES.

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STAMP: NO. 60628

NO. DATE REVISIONS 09/25/2020 50% SCHEMATIC DESIGN 10/08/2020 PLANNING SUBMITTAL 11/09/2020 PLANNING SUBMITTAL

PROJECT TITLE:

PROJECT NO.

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DATE: 9/25/2020 SHEET TITLE: **STORMWATER**

2004050


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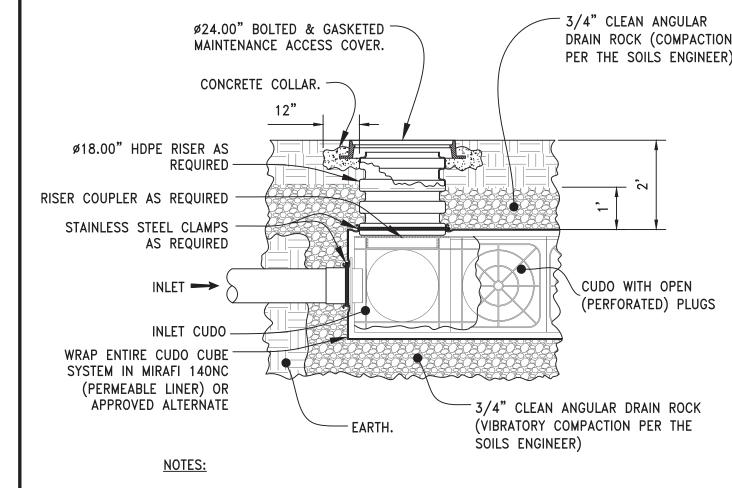
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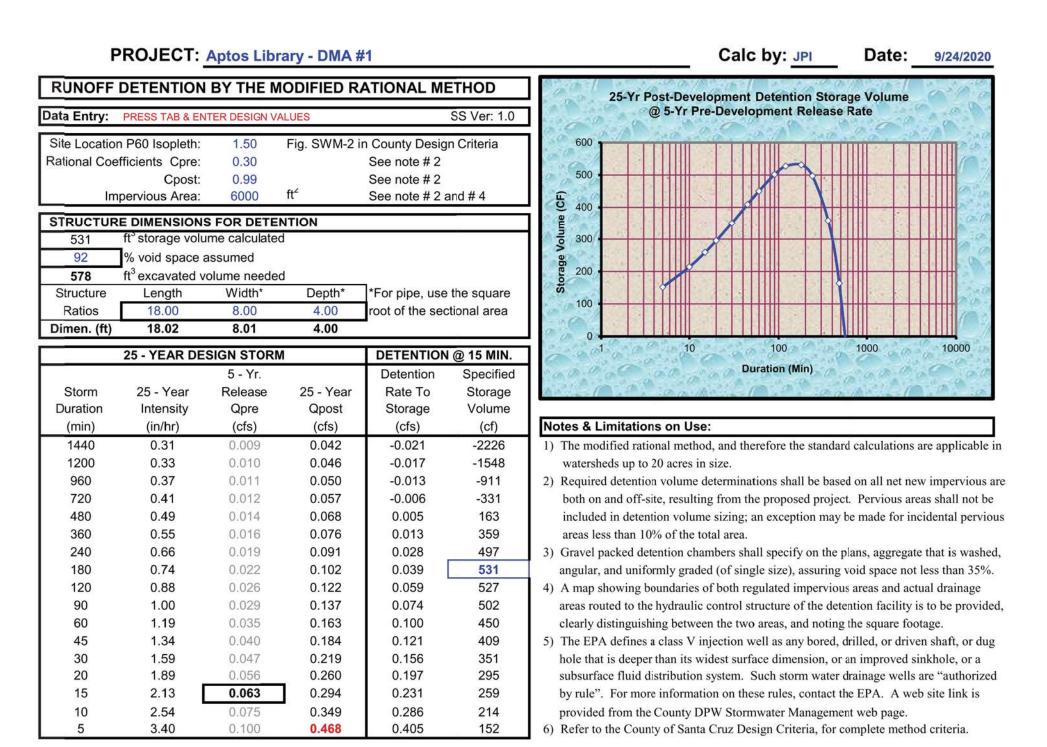
3





1. REFER TO CUDO INSTALLATION SPECIFICATIONS FOR MORE INFORMATION. 2. FOR GRAPHICAL PURPOSES, ONLY THE TOP ROW OF CUBES IS SHOWN. ACTUAL SYSTEM DEPTH IS GREATER.

TYPICAL MAINTENANCE ACCESS TO CUDO CUBE SYSTEM NTS

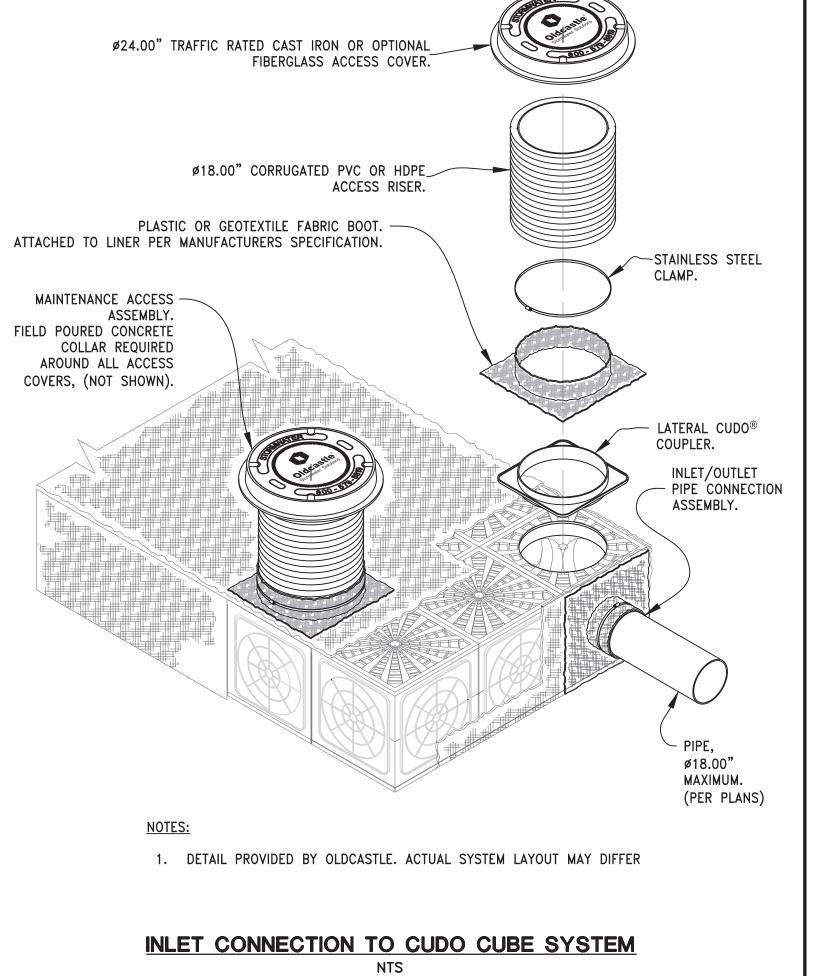

RUNOFF DETENTION BY THE MODIFIED RATIONAL METHOD Site Location P60 Isopleth: Fig. SWM-2 in County Design Criteria Rational Coefficients Cpre: 0.30 See note # 2 0.99 Cpost: See note # 2 Impervious Area: 11557 ft² See note # 2 and # 4 STRUCTURE DIMENSIONS FOR DETENTION 1024 ft³ storage volume calculated 92 % void space assumed 1113 ft³ excavated volume needed Width* Depth* *For pipe, use the square Ratios 4.00 root of the sectional area Dimen. (ft) 35.59 7.91 25 - YEAR DESIGN STORM **DETENTION @ 15 MIN.** Detention 5 - Yr. Storm 25 - Year Release Rate To Storage Duration Storage Intensity Qpre Qpost Volume (min) (in/hr) (cfs) (cfs) (cfs) 1440 0.31 0.082 -4287 1200 0.088 -0.033 -2982 0.33 0.019 960 0.37 0.097 -0.024 0.021 720 0.41 0.024 -0.012 -637 0.110 480 0.49 0.028 0.130 0.009 315 360 0.55 0.147 0.026 692 0.032 240 0.66 0.037 0.175 0.053 957 180 0.74 0.042 0.197 0.076 1024 angular, and uniformly graded (of single size), assuring void space not less than 35%. 120 0.88 0.050 0.234 0.113 1015) A map showing boundaries of both regulated impervious areas and actual drainage 1.00 0.057 0.265 0.143 966 areas routed to the hydraulic control structure of the detention facility is to be provided, 1.19 0.067 0.314 0.193 868 clearly distinguishing between the two areas, and noting the square footage. 0.234 788 1.34 0.076 0.355 1.59 0.421 0.300 675 0.090 20 0.379 1.89 0.500 569 15 2.13 0.121 0.565 0.444 500 0.550 2.54 0.671 413 0.779 292 0.901

PROJECT: Aptos Library - DMA #4

0.30

6.00

Release

Qpre

0.005

0.006

0.006

0.007

0.008

0.009

0.011

0.012

0.015

0.017

0.020

0.022

0.027

0.036

Qpost

(cfs)

0.024

0.026

0.028

0.032

0.038

0.043

0.051

0.058

0.069

0.078

0.092

0.104

0.124

0.147

0.166

0.197

0.264

0.033

0.042

0.057

0.069

0.088

0.111

0.130

0.161

0.229

298

283

254

231

198

167

147

121

Data Entry: PRESS TAB & ENTER DESIGN VALUES

Cpost:

STRUCTURE DIMENSIONS FOR DETENTION 300 ft³ storage volume calculated

% void space assumed

326 ft³ excavated volume needed

28.00

Dimen. (ft) 27.73 5.94

25 - Year

Intensity

(in/hr)

0.31

0.33

0.37

0.41

0.49

0.55

0.66

0.74

0.88

1.00

1.19

1.34

1.59

1.89

2.13

2.54

3.40

Impervious Area: 3390 ft²

Length Width*

25 - YEAR DESIGN STORM

Site Location P60 Isopleth:

Rational Coefficients Cpre:

Storm

Duration

1440

1200

960

720

480

360

240

180

120

45

30

20

15

PROJECT: Aptos Library - DMA #2


Calc by: JPI 25-Yr Post-Development Detention Storage Volume @ 5-Yr Pre-Development Release Rate **Duration (Min)** Notes & Limitations on Use:) The modified rational method, and therefore the standard calculations are applicable in watersheds up to 20 acres in size.) Required detention volume determinations shall be based on all net new impervious are both on and off-site, resulting from the proposed project. Pervious areas shall not be included in detention volume sizing; an exception may be made for incidental pervious areas less than 10% of the total area. 3) Gravel packed detention chambers shall specify on the plans, aggregate that is washed,

5) The EPA defines a class V injection well as any bored, drilled, or driven shaft, or dug hole that is deeper than its widest surface dimension, or an improved sinkhole, or a subsurface fluid distribution system. Such storm water drainage wells are "authorized by rule". For more information on these rules, contact the EPA. A web site link is

provided from the County DPW Stormwater Management web page. 6) Refer to the County of Santa Cruz Design Criteria, for complete method criteria.

NOTE: DETENTION FOR DMA 2 IS ONLY FOR THAT PORTION OF THE SOUTHERLY PARKING LOT THAT IS BEING MODIFIED, AS THE NORTHERLY PARKING LOT HAS AN EXISTING DETENTION SYSTEM PROVIDING MITIGATION.

Calc by: JPI PROJECT: Aptos Library - DMA #3 Date: 9/24/2020 RUNOFF DETENTION BY THE MODIFIED RATIONAL METHOD 25-Yr Post-Development Detention Storage Volume @ 5-Yr Pre-Development Release Rate Data Entry: PRESS TAB & ENTER DESIGN VALUES SS Ver: 1.0 Site Location P60 Isopleth: Fig. SWM-2 in County Design Criteria Rational Coefficients Cpre: 0.30 See note # 2 See note # 2 Cpost: Impervious Area: 6593 ft² See note # 2 and # 4 STRUCTURE DIMENSIONS FOR DETENTION 584 ft³ storage volume calculated % void space assumed 635 ft³ excavated volume needed Length Width* Depth* *For pipe, use the square 6.00 4.00 root of the sectional area 32.00 Dimen. (ft) 30.03 5.63 25 - YEAR DESIGN STORM DETENTION @ 15 MIN. **Duration (Min)** Detention Rate To Storm 25 - Year Release 25 - Year Storage Duration Storage Volume Intensity Qpre Qpost (in/hr) (cfs) Notes & Limitations on Use: 1440 0.31 0.047 -0.023 -2446 1) The modified rational method, and therefore the standard calculations are applicable in 0.010 1200 0.050 0.33 0.011 -0.019 watersheds up to 20 acres in size. 960 0.37 0.012 0.055 -0.014 -1001 Required detention volume determinations shall be based on all net new impervious are 0.41 0.063 -0.007 720 0.013 both on and off-site, resulting from the proposed project. Pervious areas shall not be -363 480 0.49 0.016 0.074 0.005 180 included in detention volume sizing; an exception may be made for incidental pervious 360 0.55 0.015 0.018 0.084 395 areas less than 10% of the total area. 240 0.66 0.021 0.100 0.030) Gravel packed detention chambers shall specify on the plans, aggregate that is washed, 0.74 180 0.024 0.112 0.043 584 angular, and uniformly graded (of single size), assuring void space not less than 35%. 120 0.88 0.029 0.134 0.064 579 4) A map showing boundaries of both regulated impervious areas and actual drainage 1.00 0.032 0.151 0.082 551 areas routed to the hydraulic control structure of the detention facility is to be provided, 1.19 0.179 0.110 0.038 clearly distinguishing between the two areas, and noting the square footage. 45 1.34 0.043 0.202 0.133 450 5) The EPA defines a class V injection well as any bored, drilled, or driven shaft, or dug 1.59 0.171 0.052 0.240 385 hole that is deeper than its widest surface dimension, or an improved sinkhole, or a 1.89 20 0.286 0.216 324 subsurface fluid distribution system. Such storm water drainage wells are "authorized 0.069 15 2.13 0.323 0.253 285 by rule". For more information on these rules, contact the EPA. A web site link is 2.54 0.383 0.314 235 provided from the County DPW Stormwater Management web page. 3.40 0.514 0.445 167 6) Refer to the County of Santa Cruz Design Criteria, for complete method criteria.

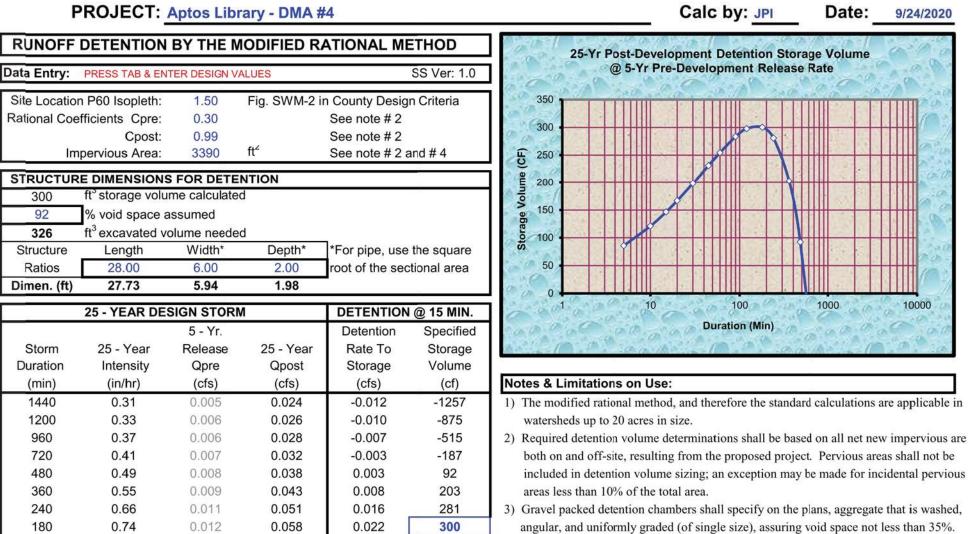

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clearly distinguishing between the two areas, and noting the square footage.

6) Refer to the County of Santa Cruz Design Criteria, for complete method criteria.

PROJECT NO. 2004050

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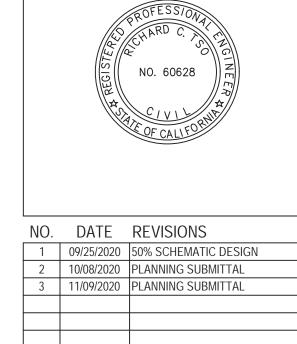
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COMPANION

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NO.	DATE	REVISIONS
1	09/25/2020	50% SCHEMATIC DESIGN
2	10/08/2020	PLANNING SUBMITTAL
3	11/09/2020	PLANNING SUBMITTAL

PROJECT TITLE:


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PROJECT	NO.	2004050
DATE:		9/25/2020
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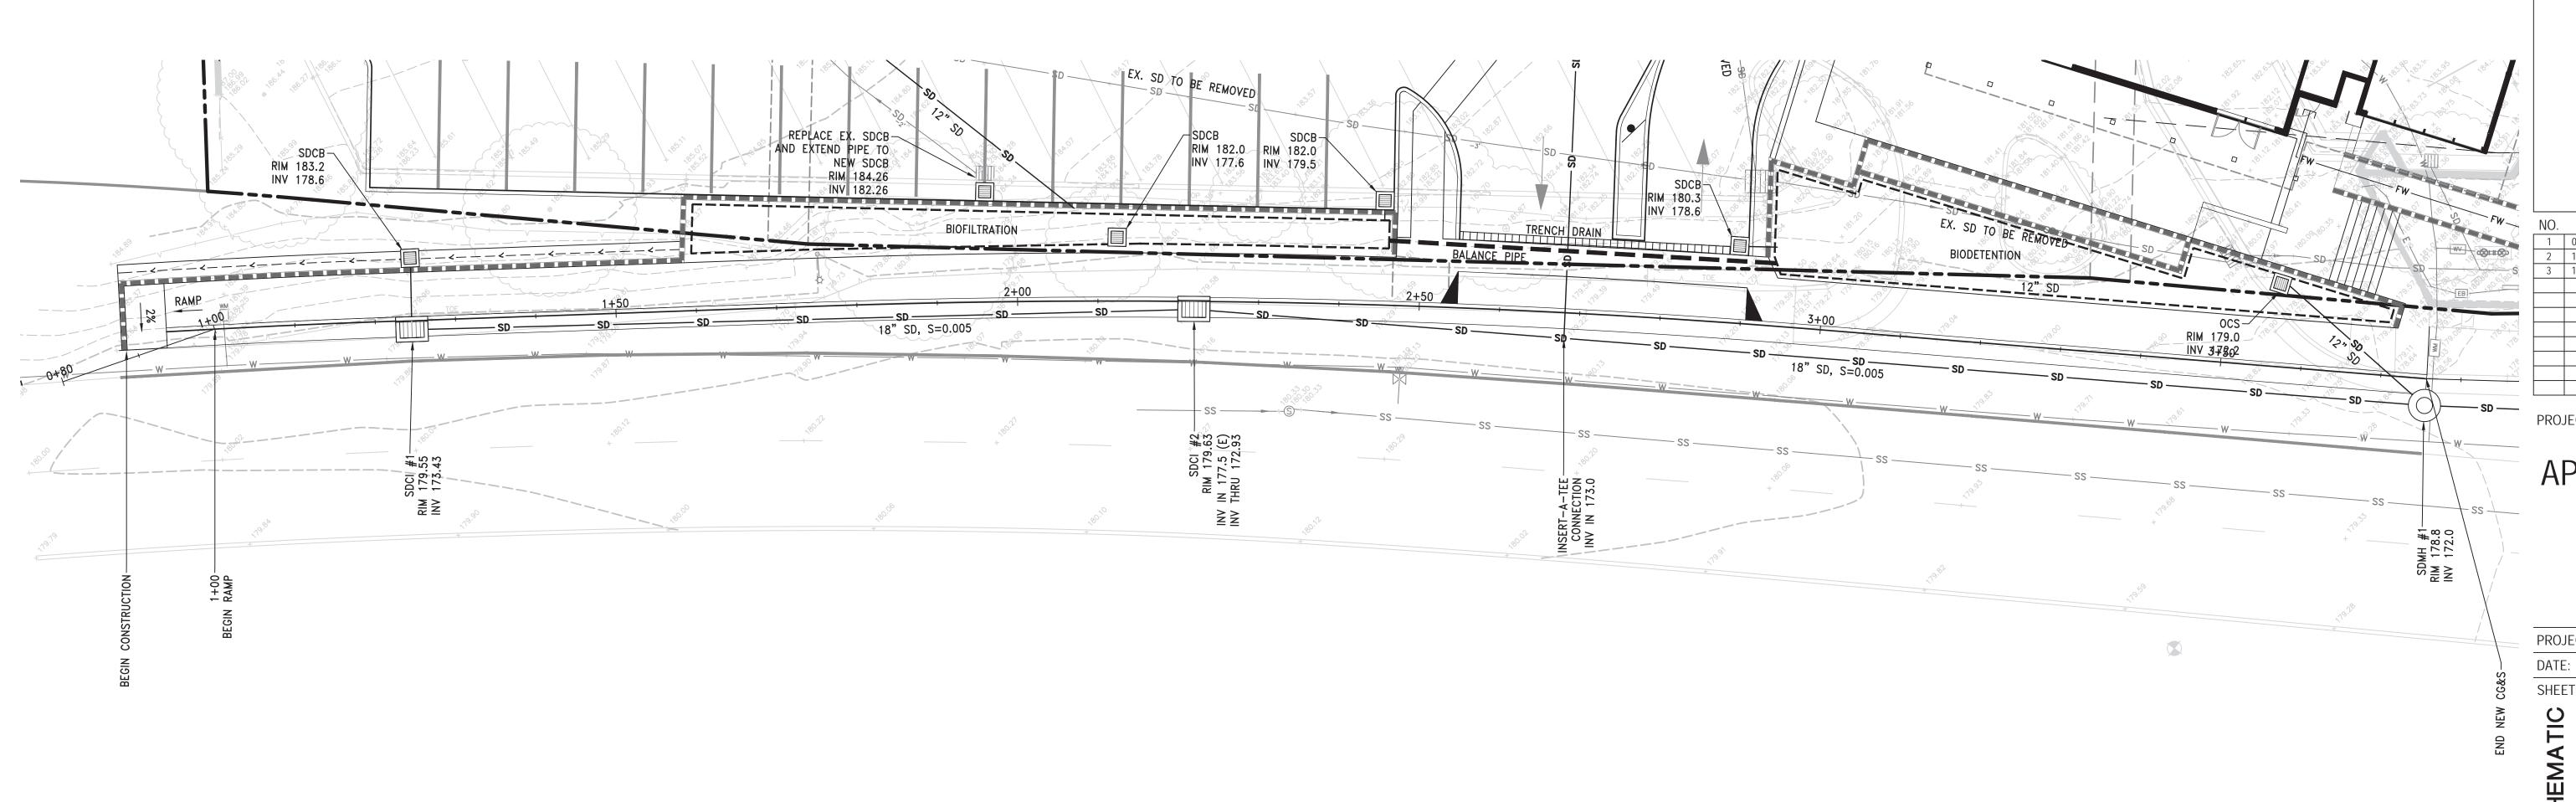
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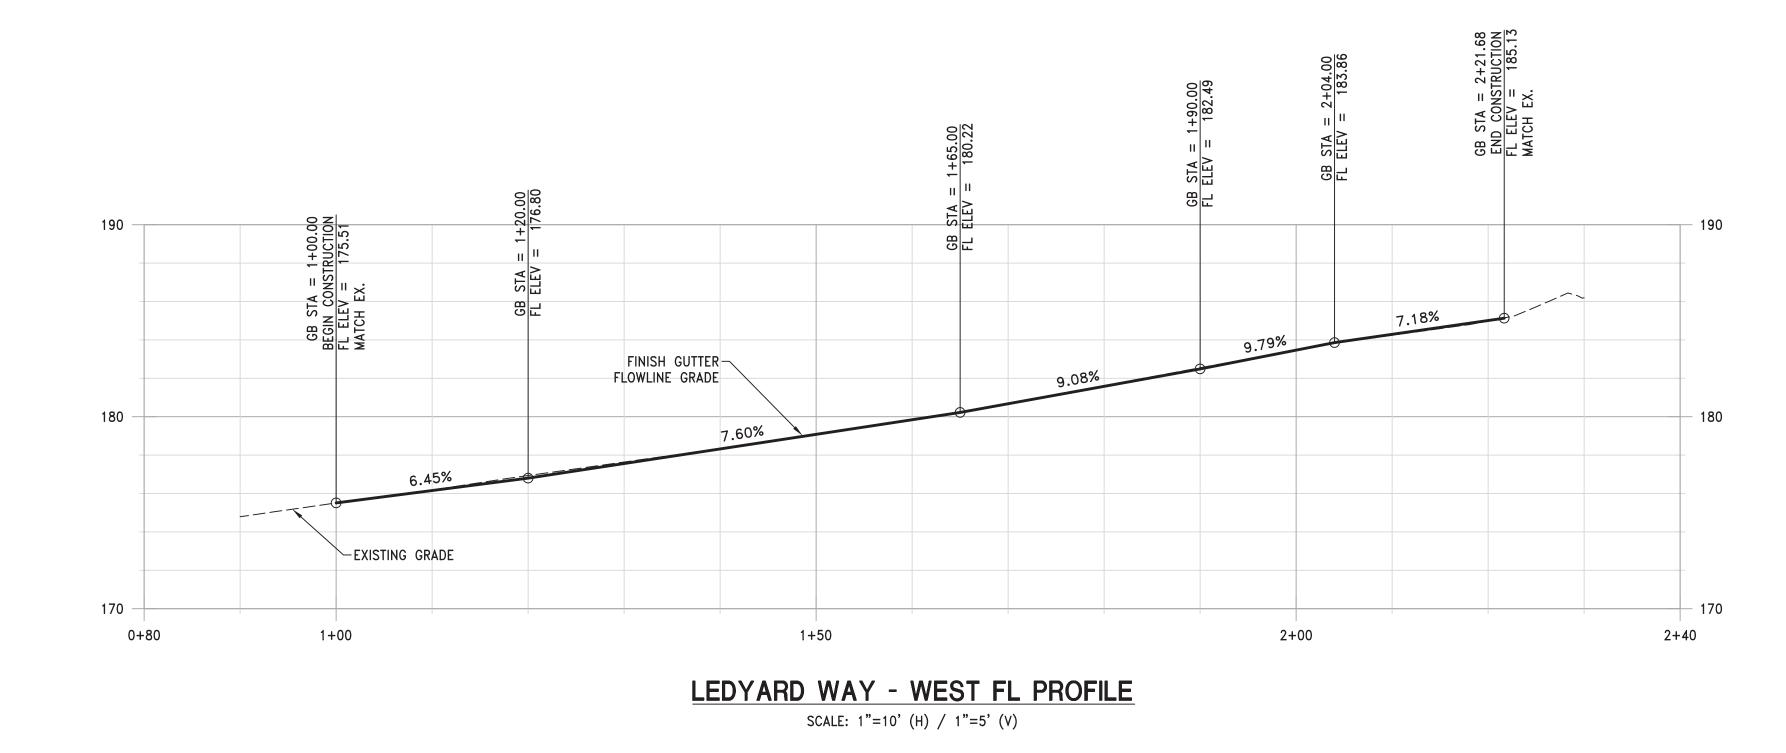
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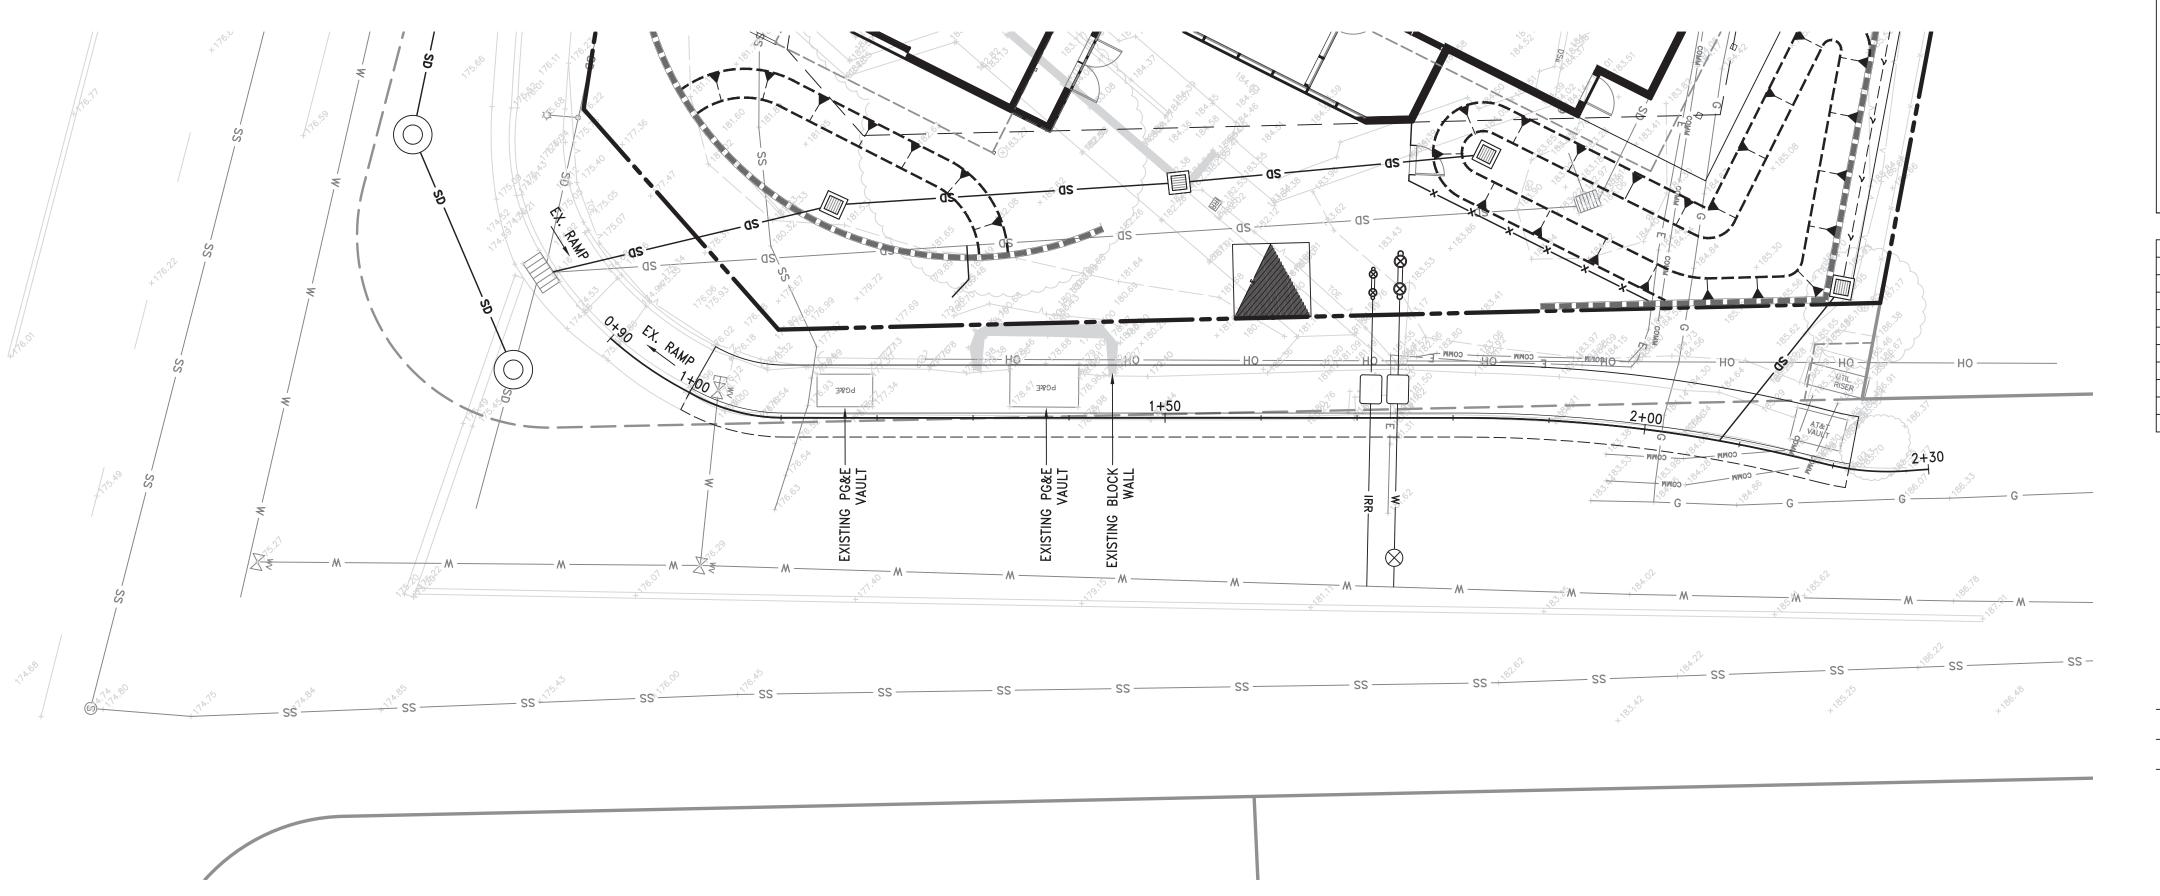



SOQUEL DRIVE - NORTH FL PROFILE

SCALE: 1"=10' (H) / 1"=5' (V)





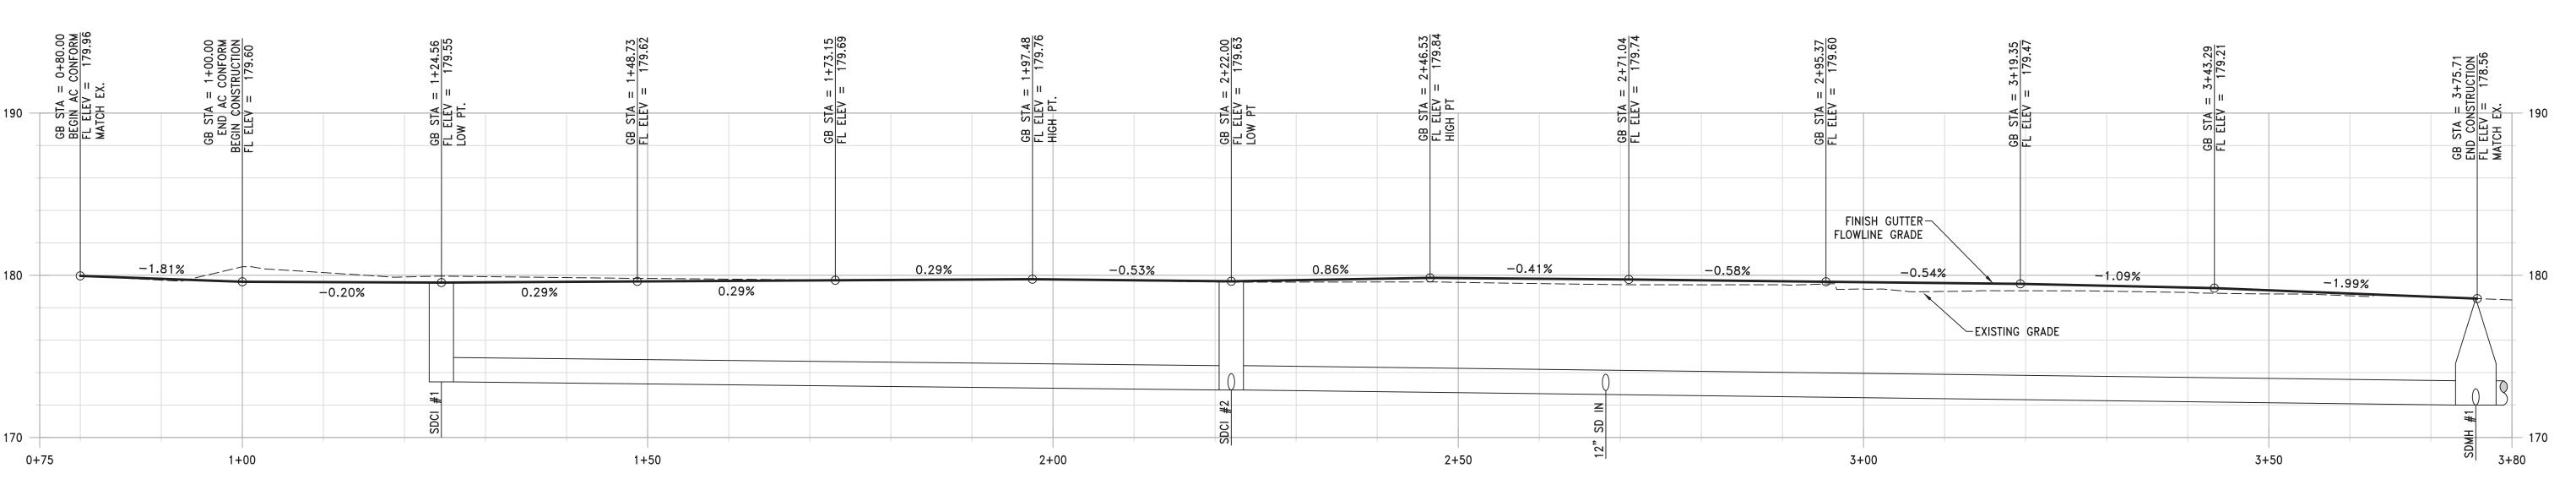

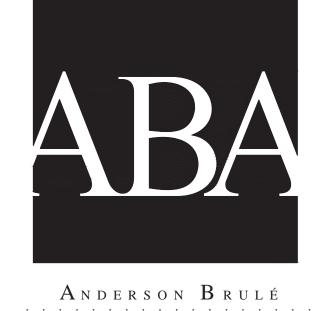


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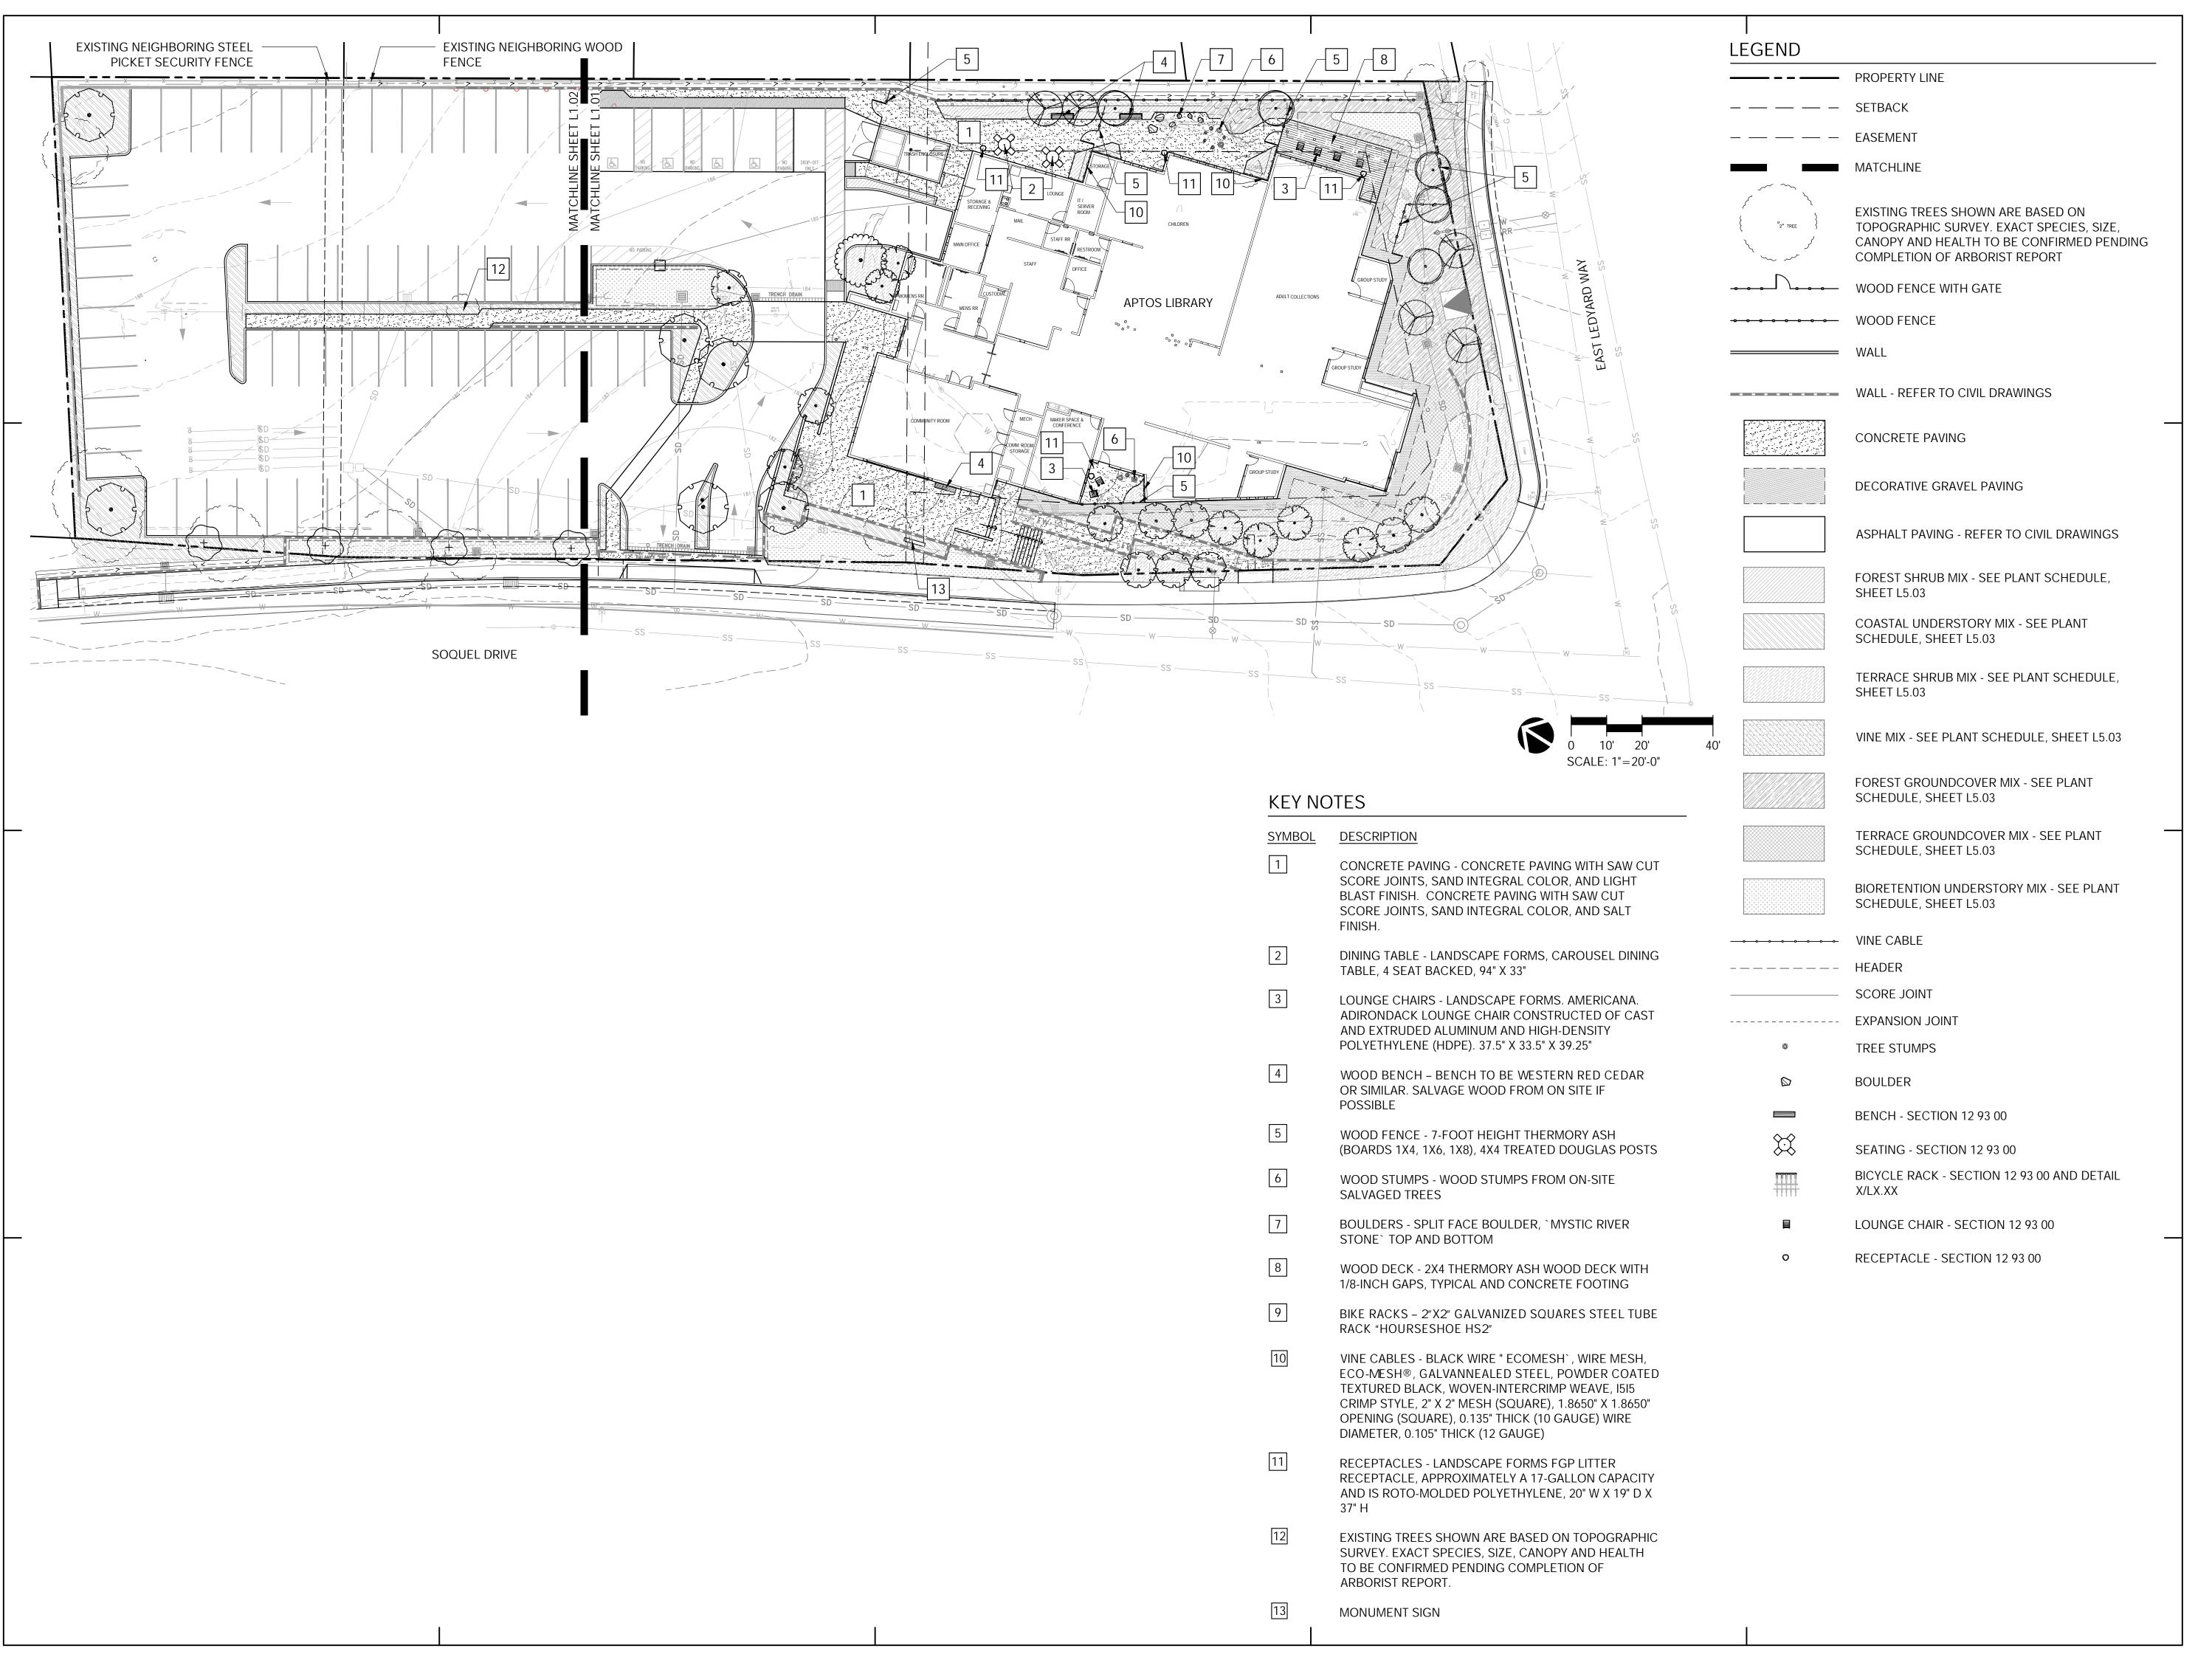
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SCHEMATIC	OFF-SIT IMPROV PLAN	_

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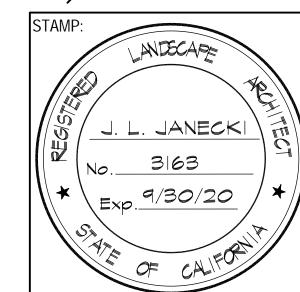
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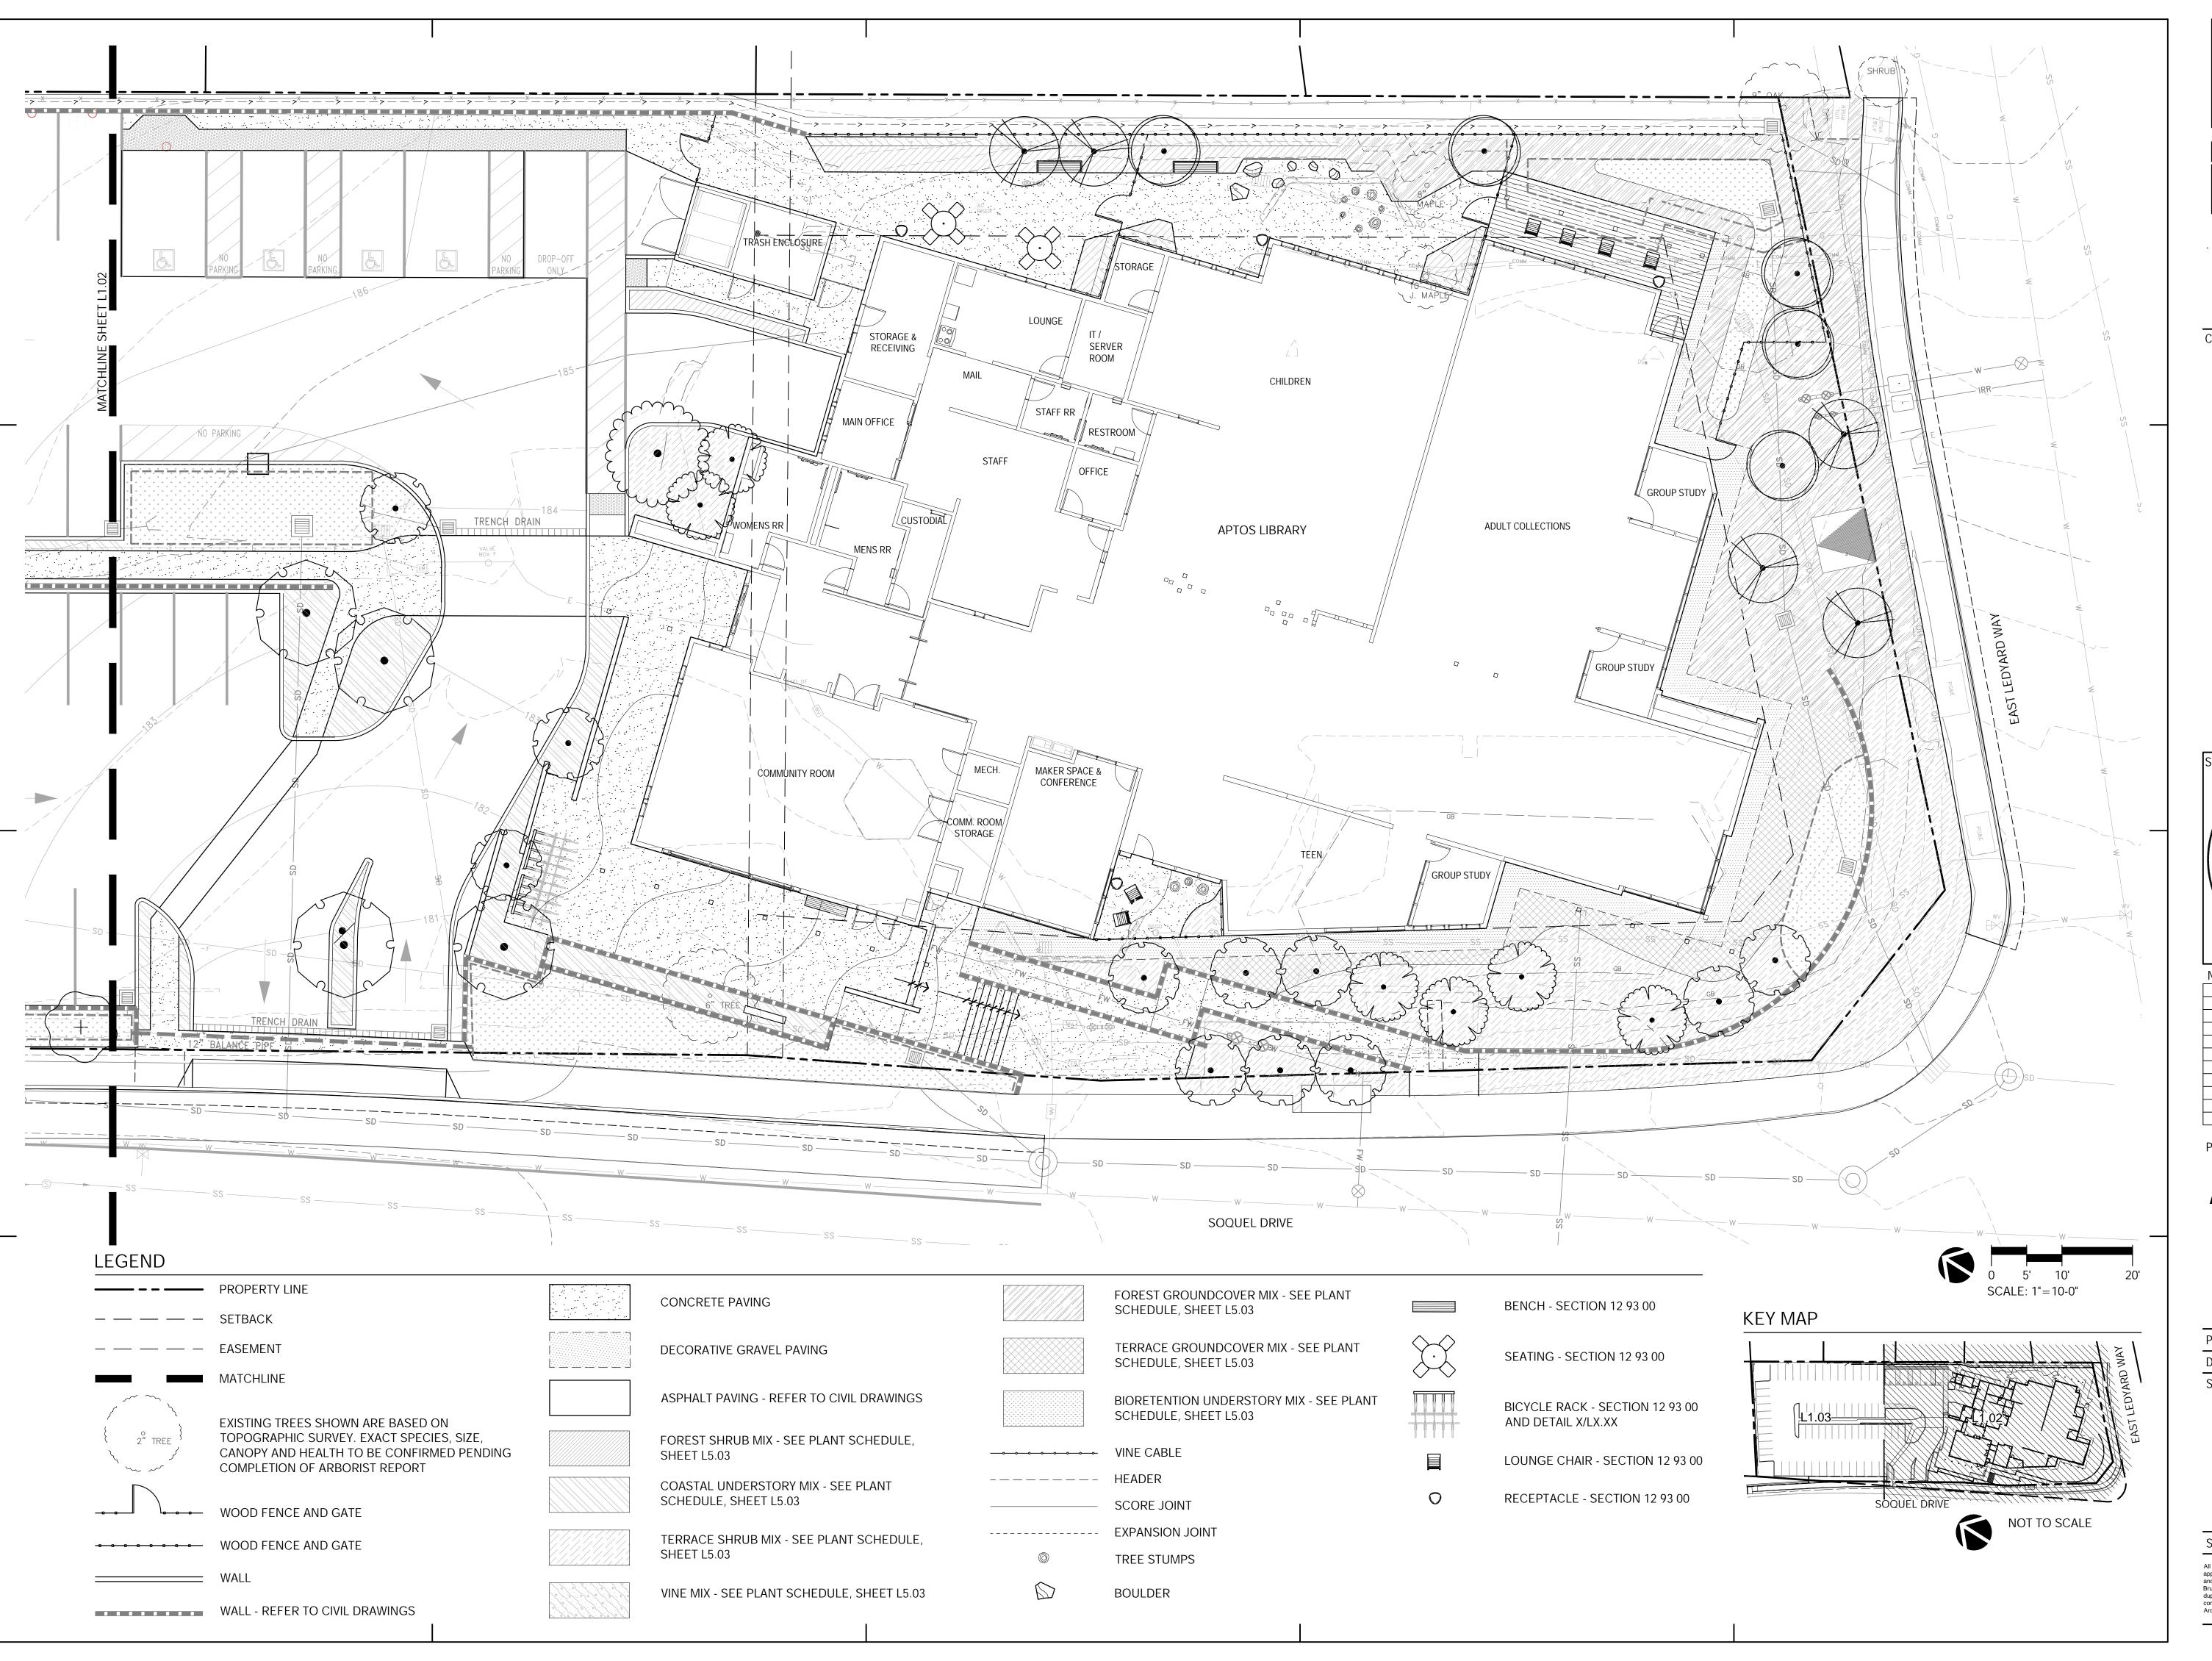
PROJECT NO.	2004050
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OVERALL LANDSCAPE SITE PLAN

SCALE: 1" = 20'-0"

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L1.01



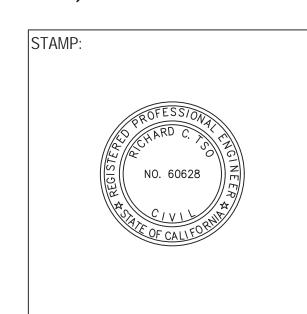

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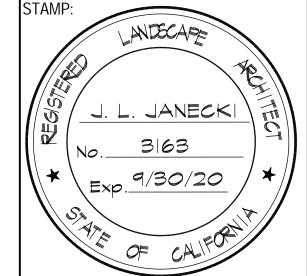
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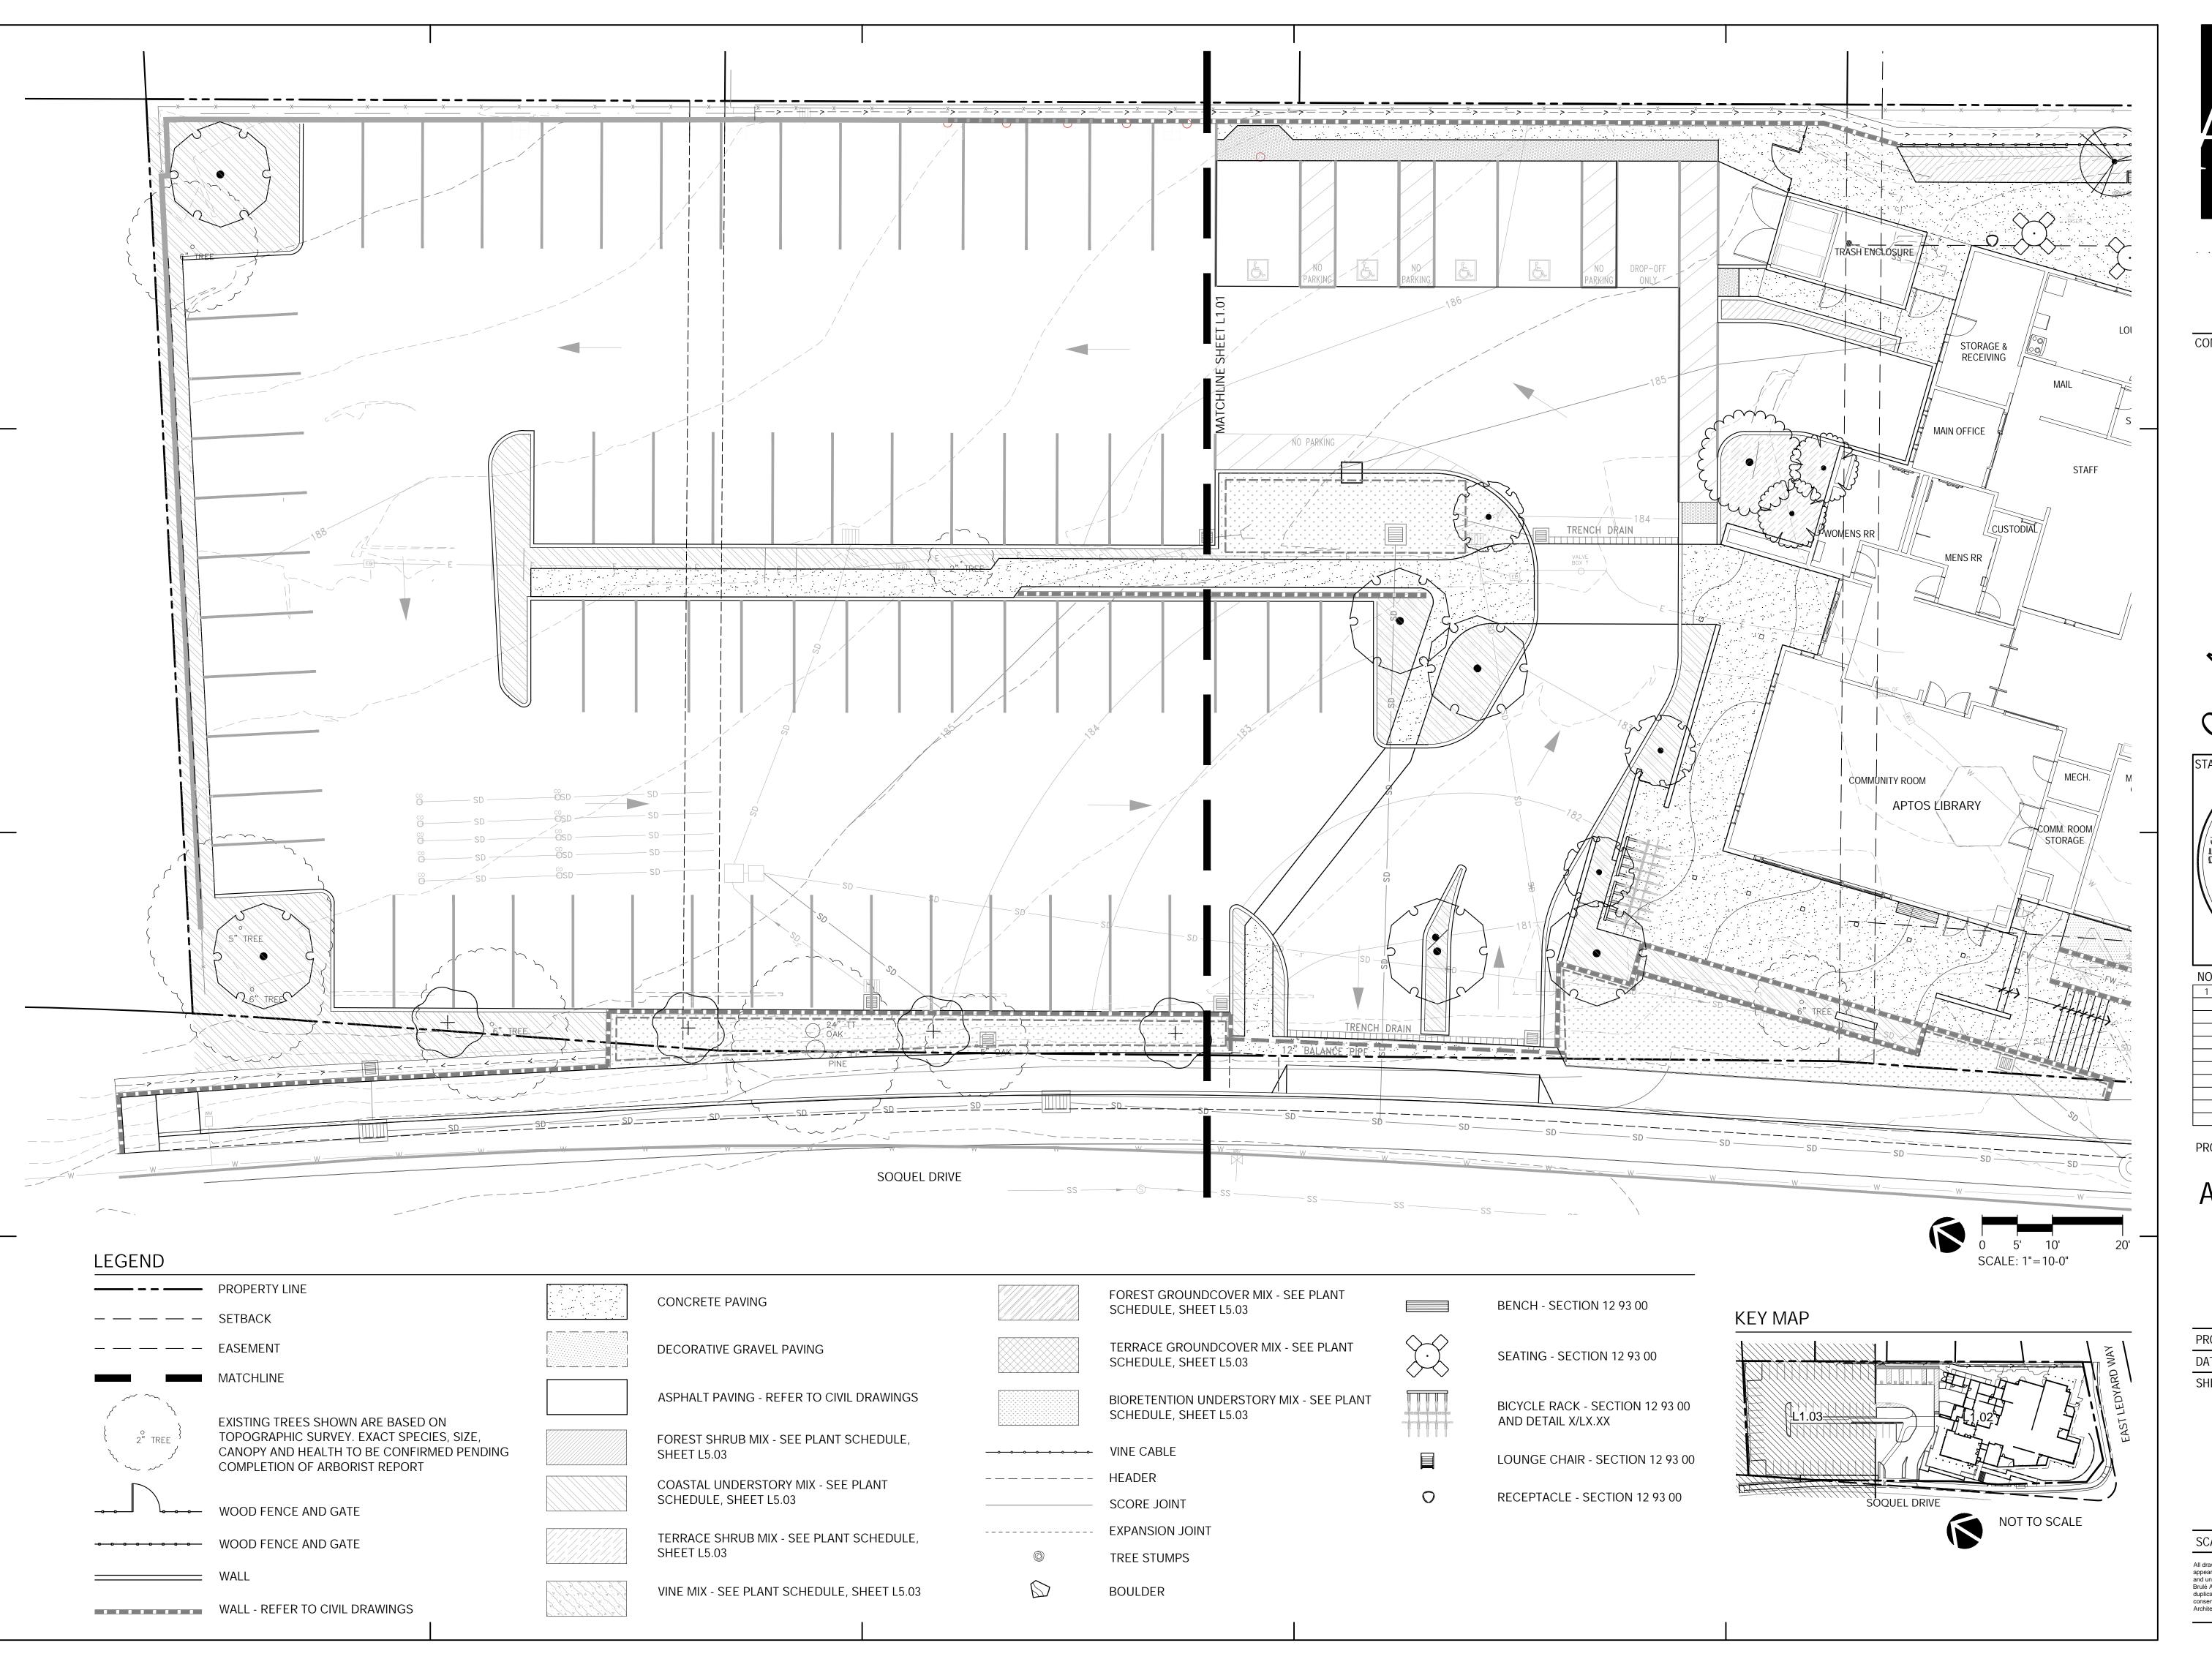
MATERIALS ENLARGEMENT PLAN

SCALE: 1" = 10'-0"

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L1.02






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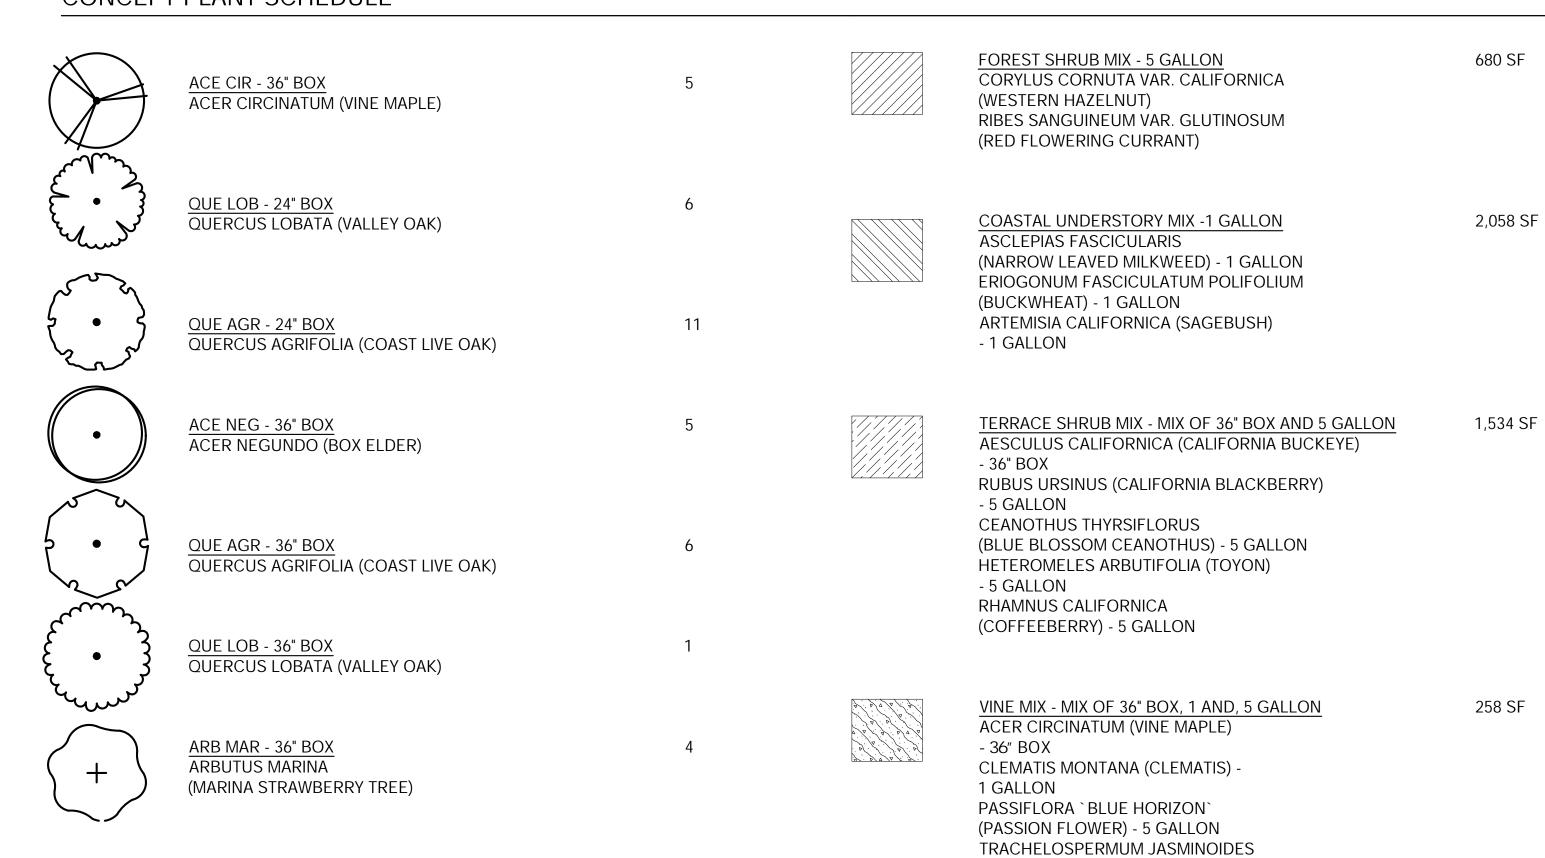
MATERIALS ENLARGEMENT PLAN

SCALE:	1" = 10'-0"
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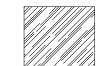
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L1.03

CONCEPT PLANT SCHEDULE



(STAR JASMINE) - 5 GALLON

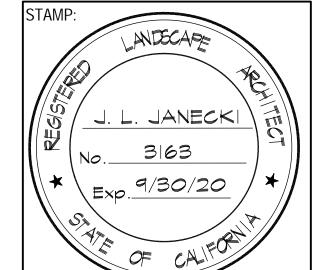

680 SF

258 SF

908 SF FOREST GROUNDCOVER MIX - MIX OF 1 AND 5 GALLON CORNUS STOLINIFERA (WESTERN HAZELNUT) - 5 GALLON OXALIS OREGANA (REDWOOD SORRELL) - 1 GALLON PETASITES FRIGIDUS VAR. PALMATUS (COLTSFOOT) - 5 GALLON POLYSTICHUM MUNITUM (SWORD FERN) - 5 GALLON TRILLIUM OVATUM (WAKE ROBIN) - 5 GALLON WHIPPLEA MODESTA (YERBA DE SELVA) - 1 GALLON VIOLA SEMPERVIRENS



TERRACE GROUNDCOVER MIX - MIX OF 1 AND 5 GALLON 546 SF LONICERA HISPIDULA (HAIRY HONEYSUCKLE) - 5 GALLON SATUREJA DOUGLASII (YERBA BUENA)

- 1 GALLON

SALVIA SPATHACEA

(HUMMINBIRD SAGE)

(EVERGREEN VIOLET) - 1 GALLON

1,104 SF BIORETENTION UNDERSTORY MIX - 5 GALLON CHONDROPETALUM TECTORUM `EL CAMPO` (CAPE RUSH) FESTUCA IDAHOENSIS `SISKIYOU BLUE` (IDAHO FESCUE) LEYMUS CONDENSATUS `CANYON PRINCE` (CANYON PRINCE GIANT RYE GRASS) LOMANDRA LONGIFOLIA `BREEZE` (BREEZE DWARF MAT RUSH) MIMULUS AURANTIACUS (STICKY MONKEY FLOWER) MIMULUS CARDINALIS (STICKY MONKEY FLOWER) JUNCUS PATENS (CALIFORNIA GREY RUSH)

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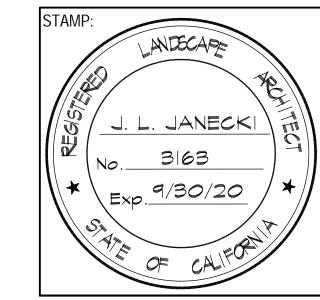
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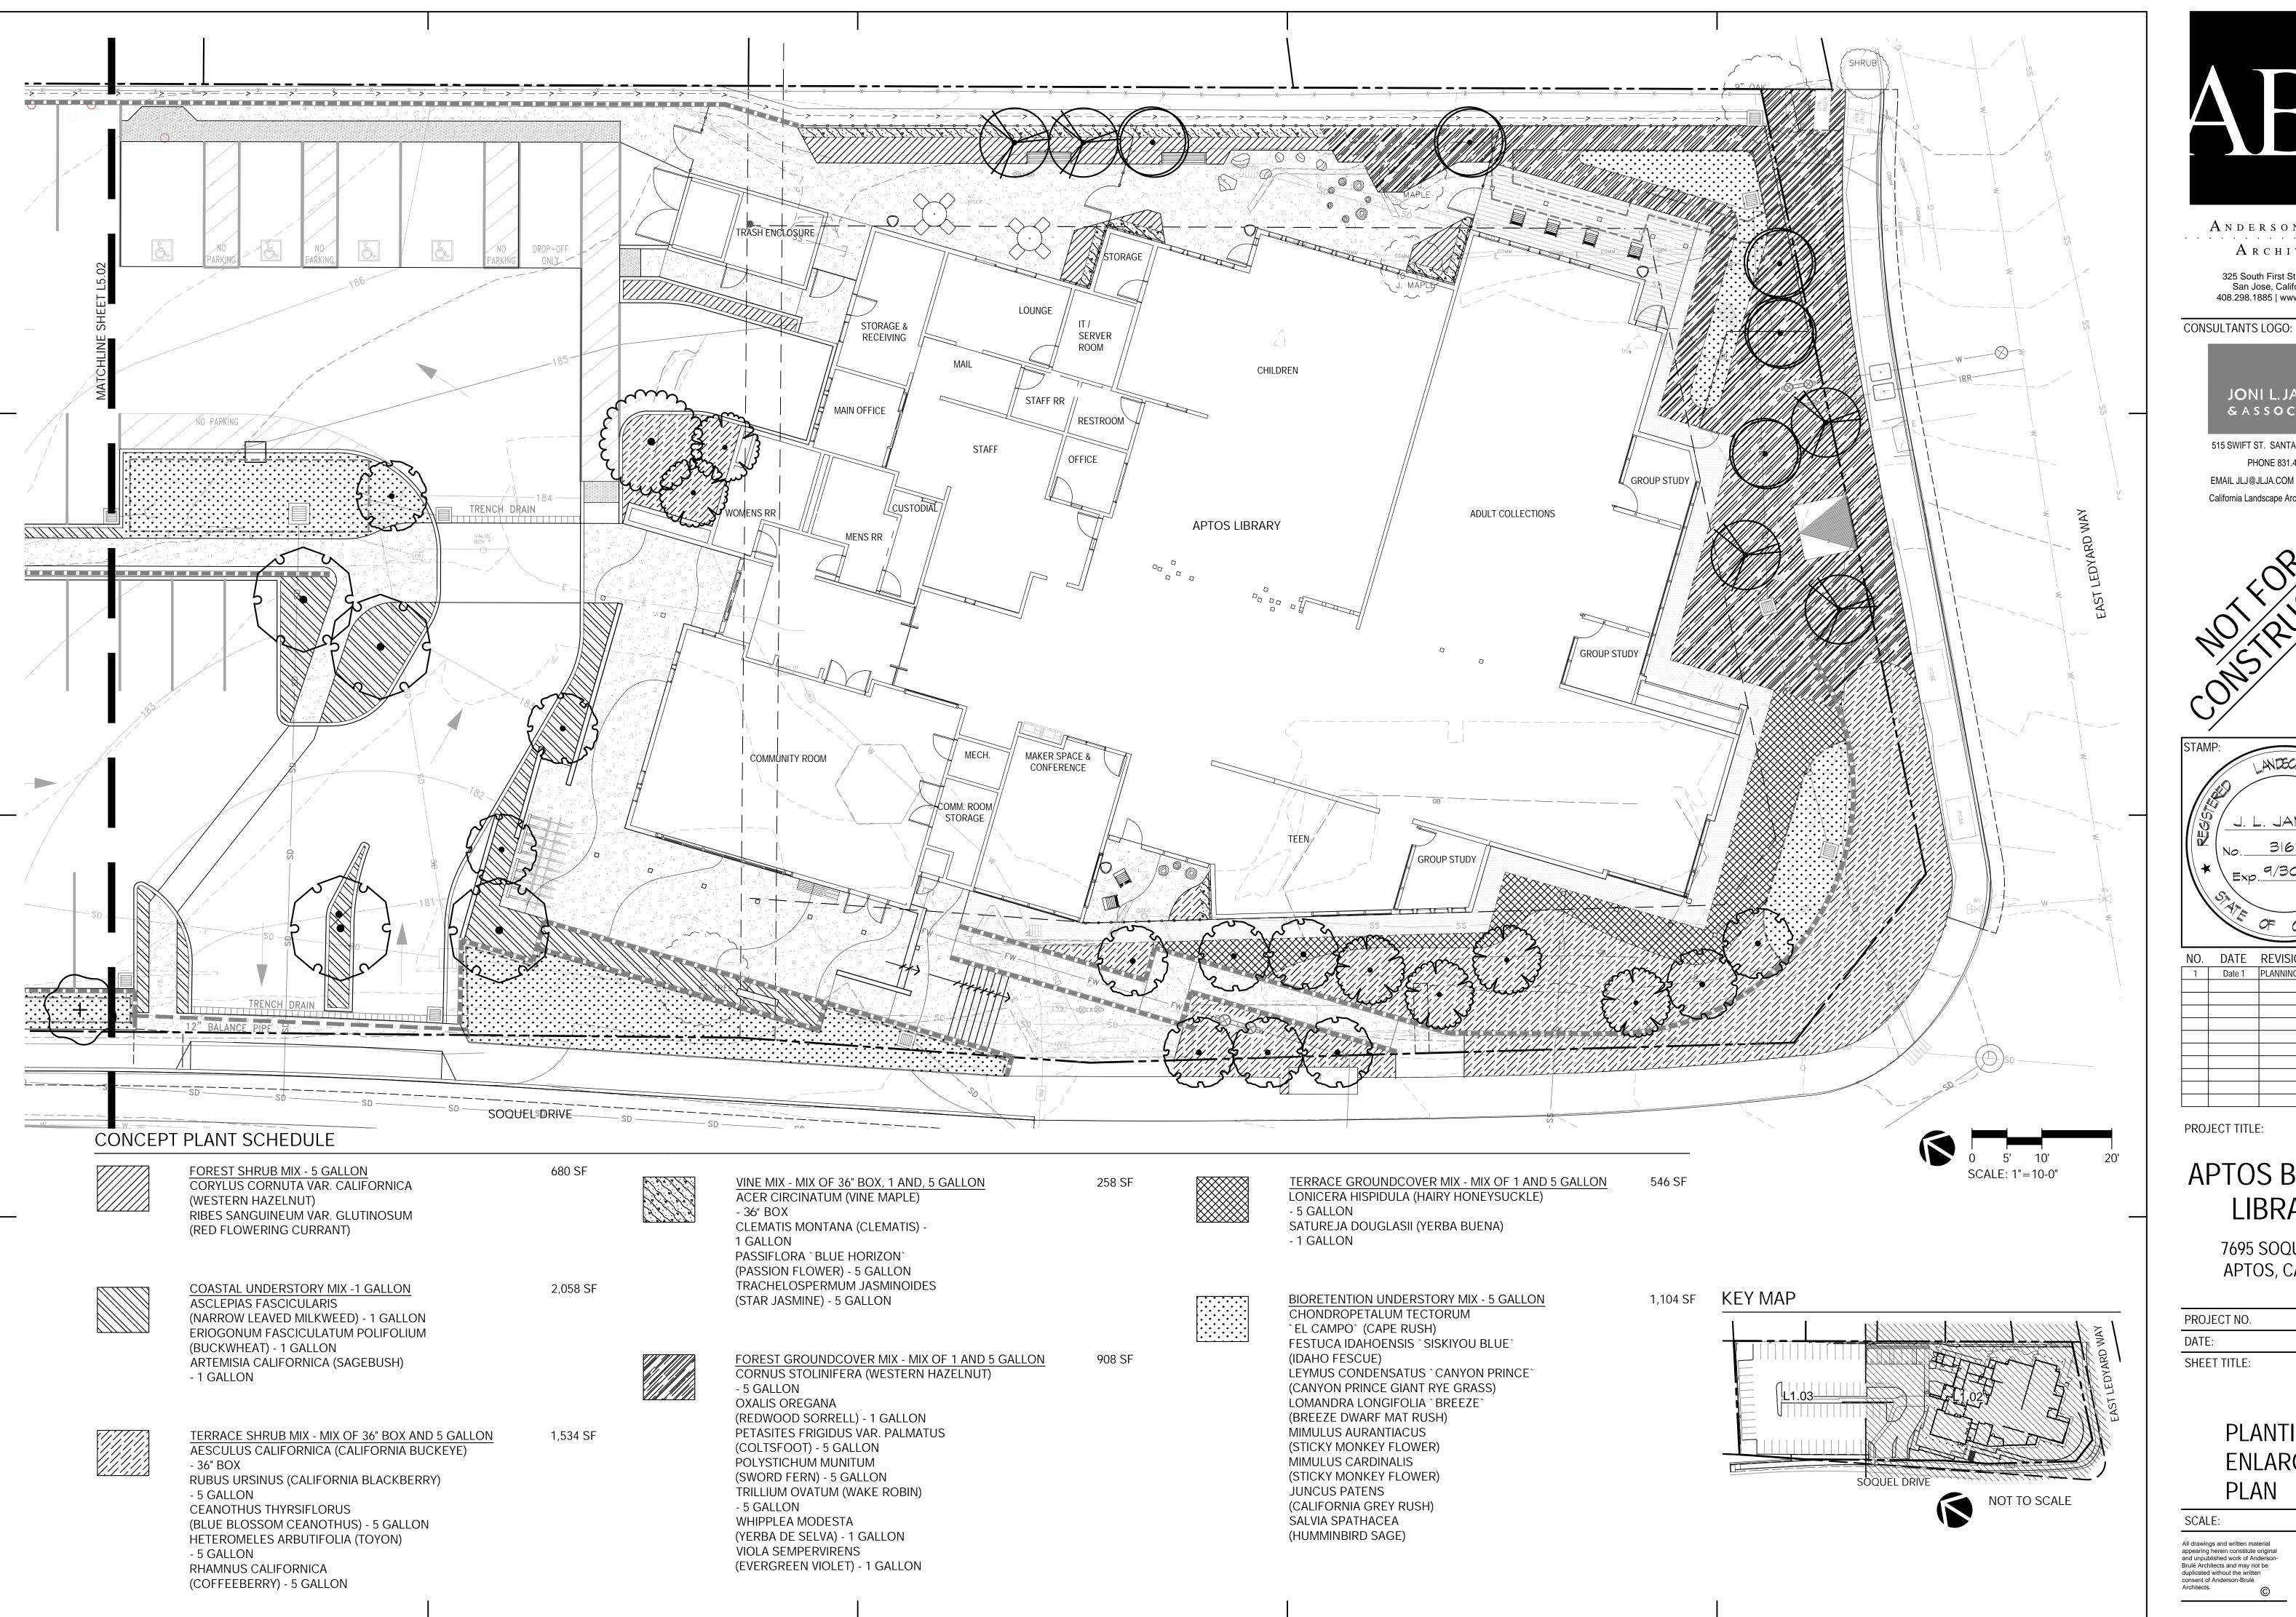
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SHEET TITLE:	

OVERALL AND TREE PLANTING PLAN

1" = 20'-0" SCALE:

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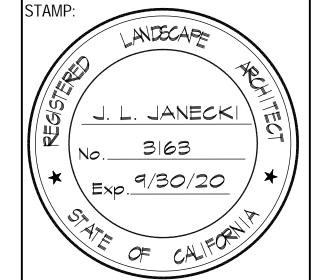


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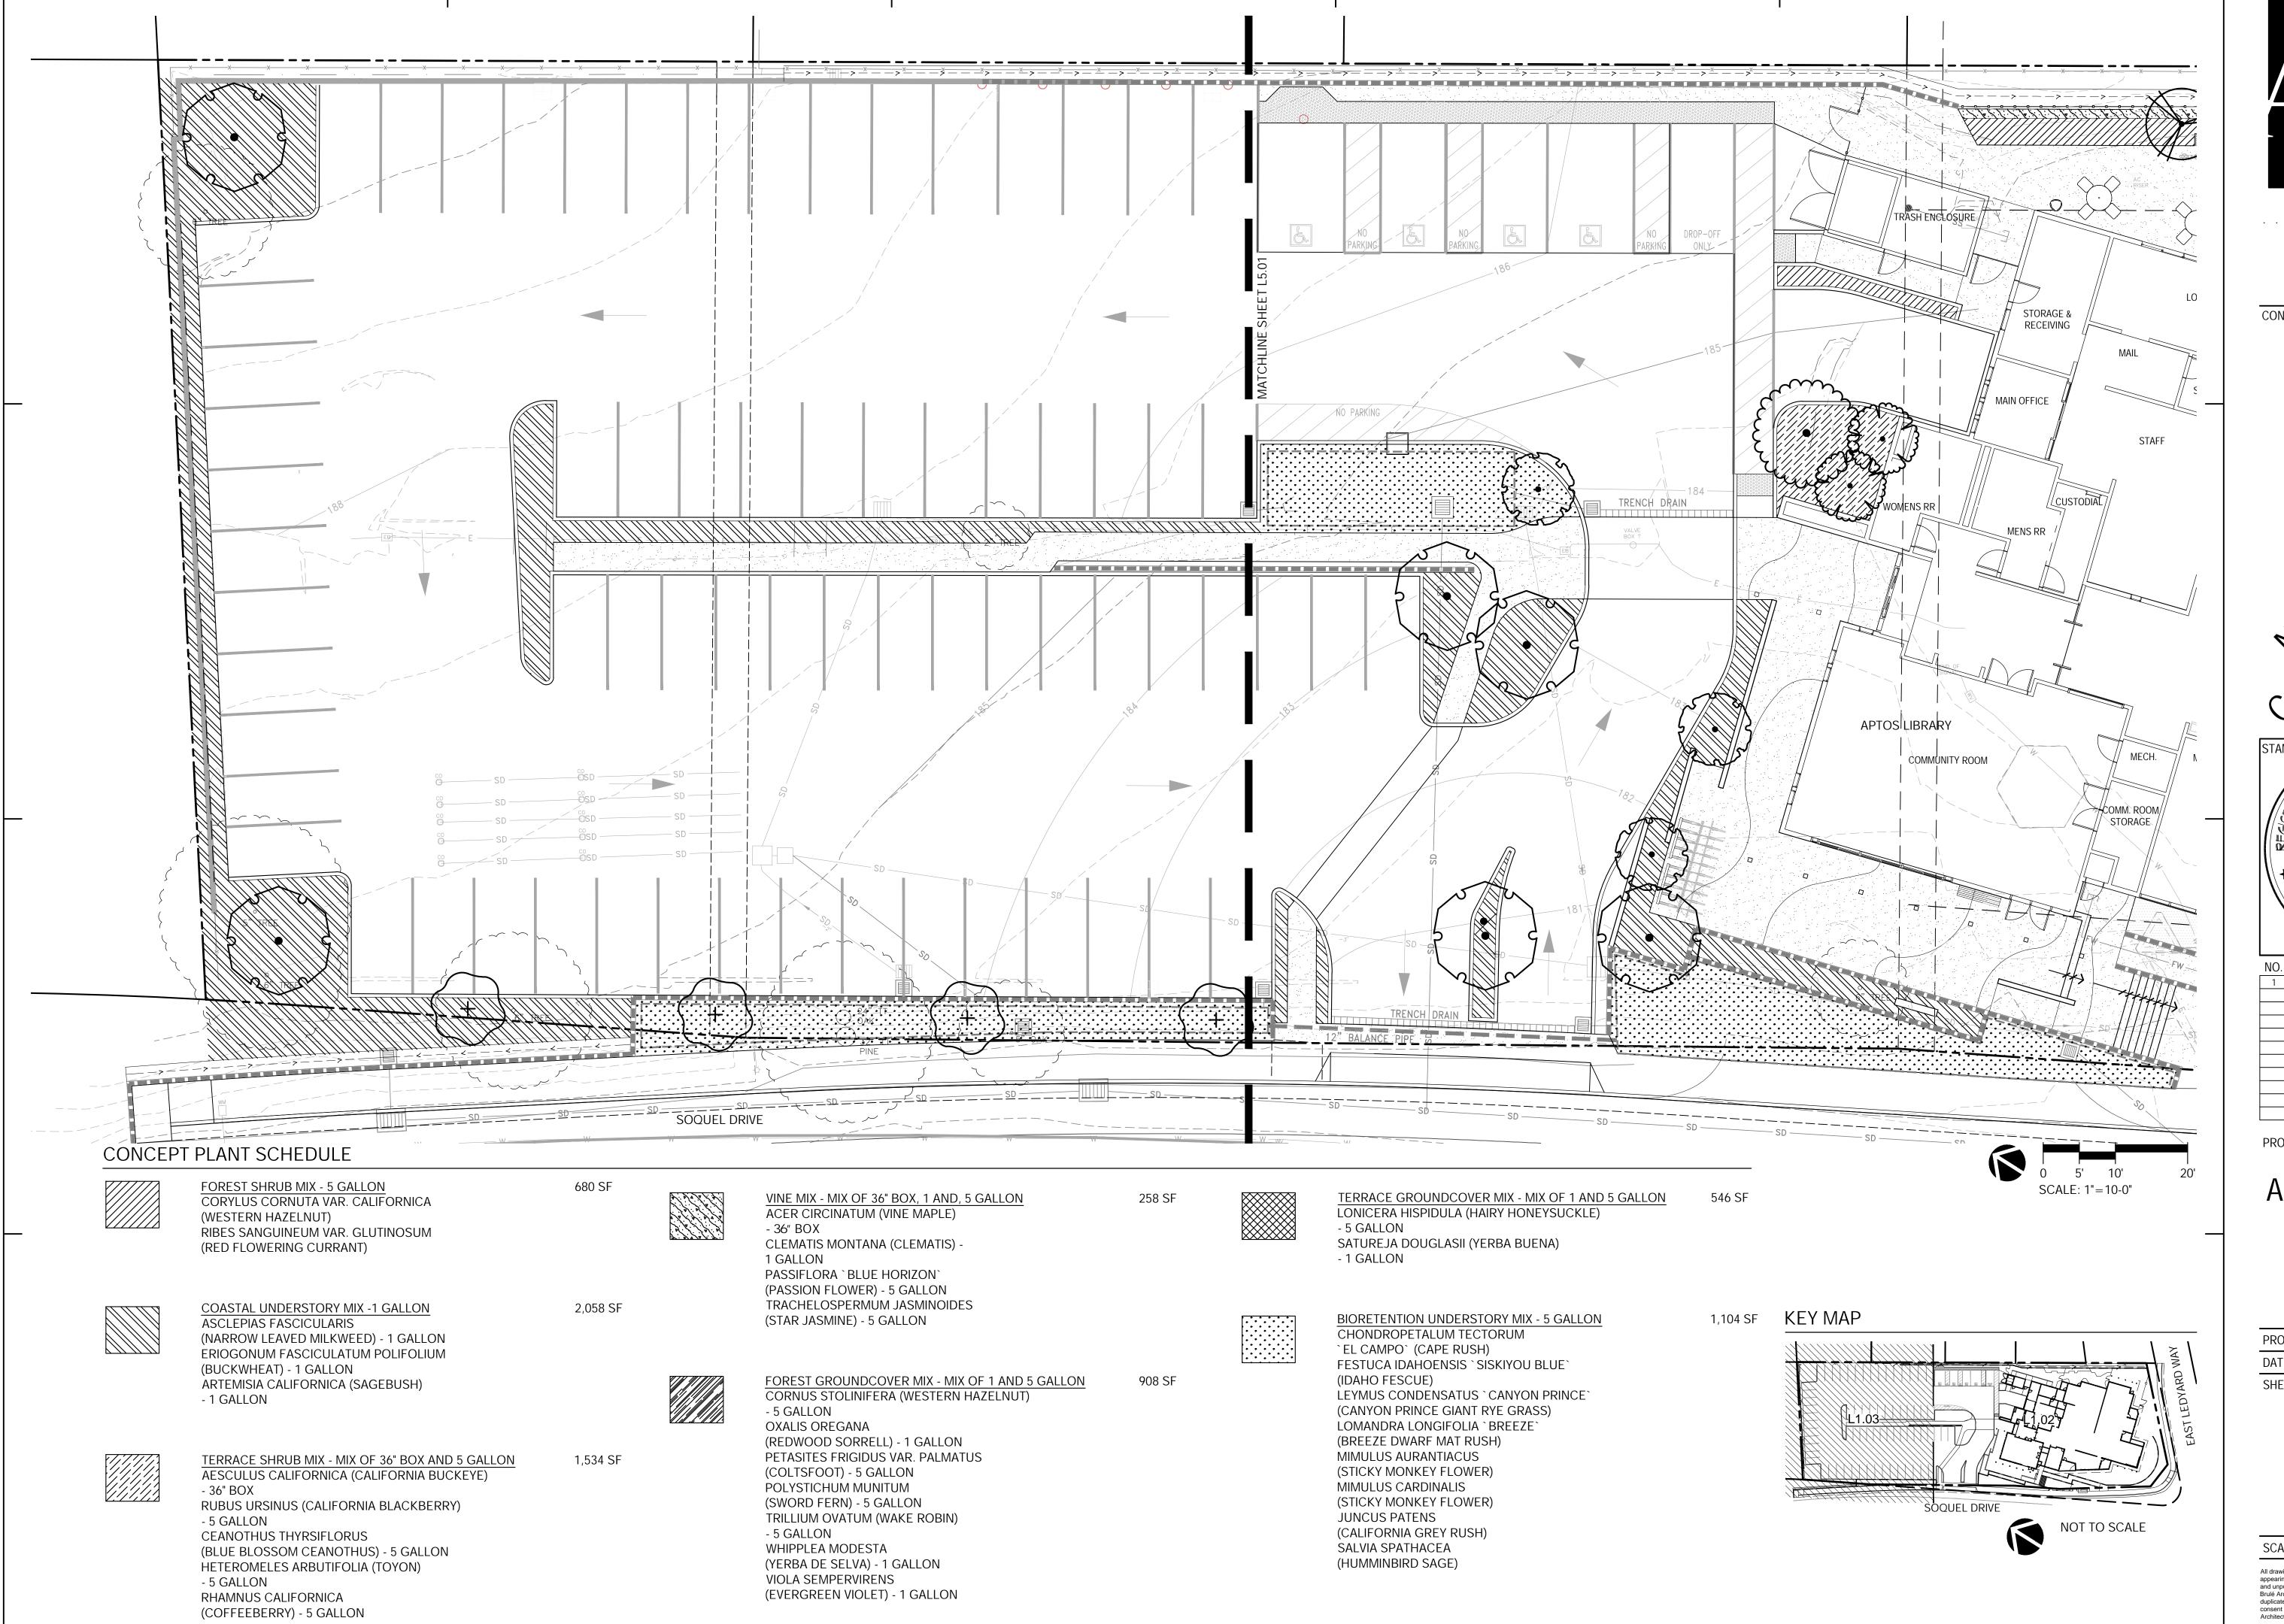
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PLANTING **ENLARGEMENT** PLAN

1" = 10'-0" SCALE:

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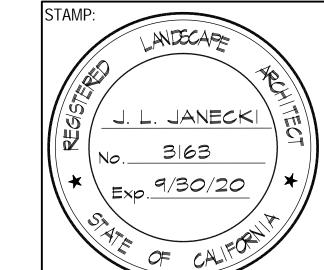
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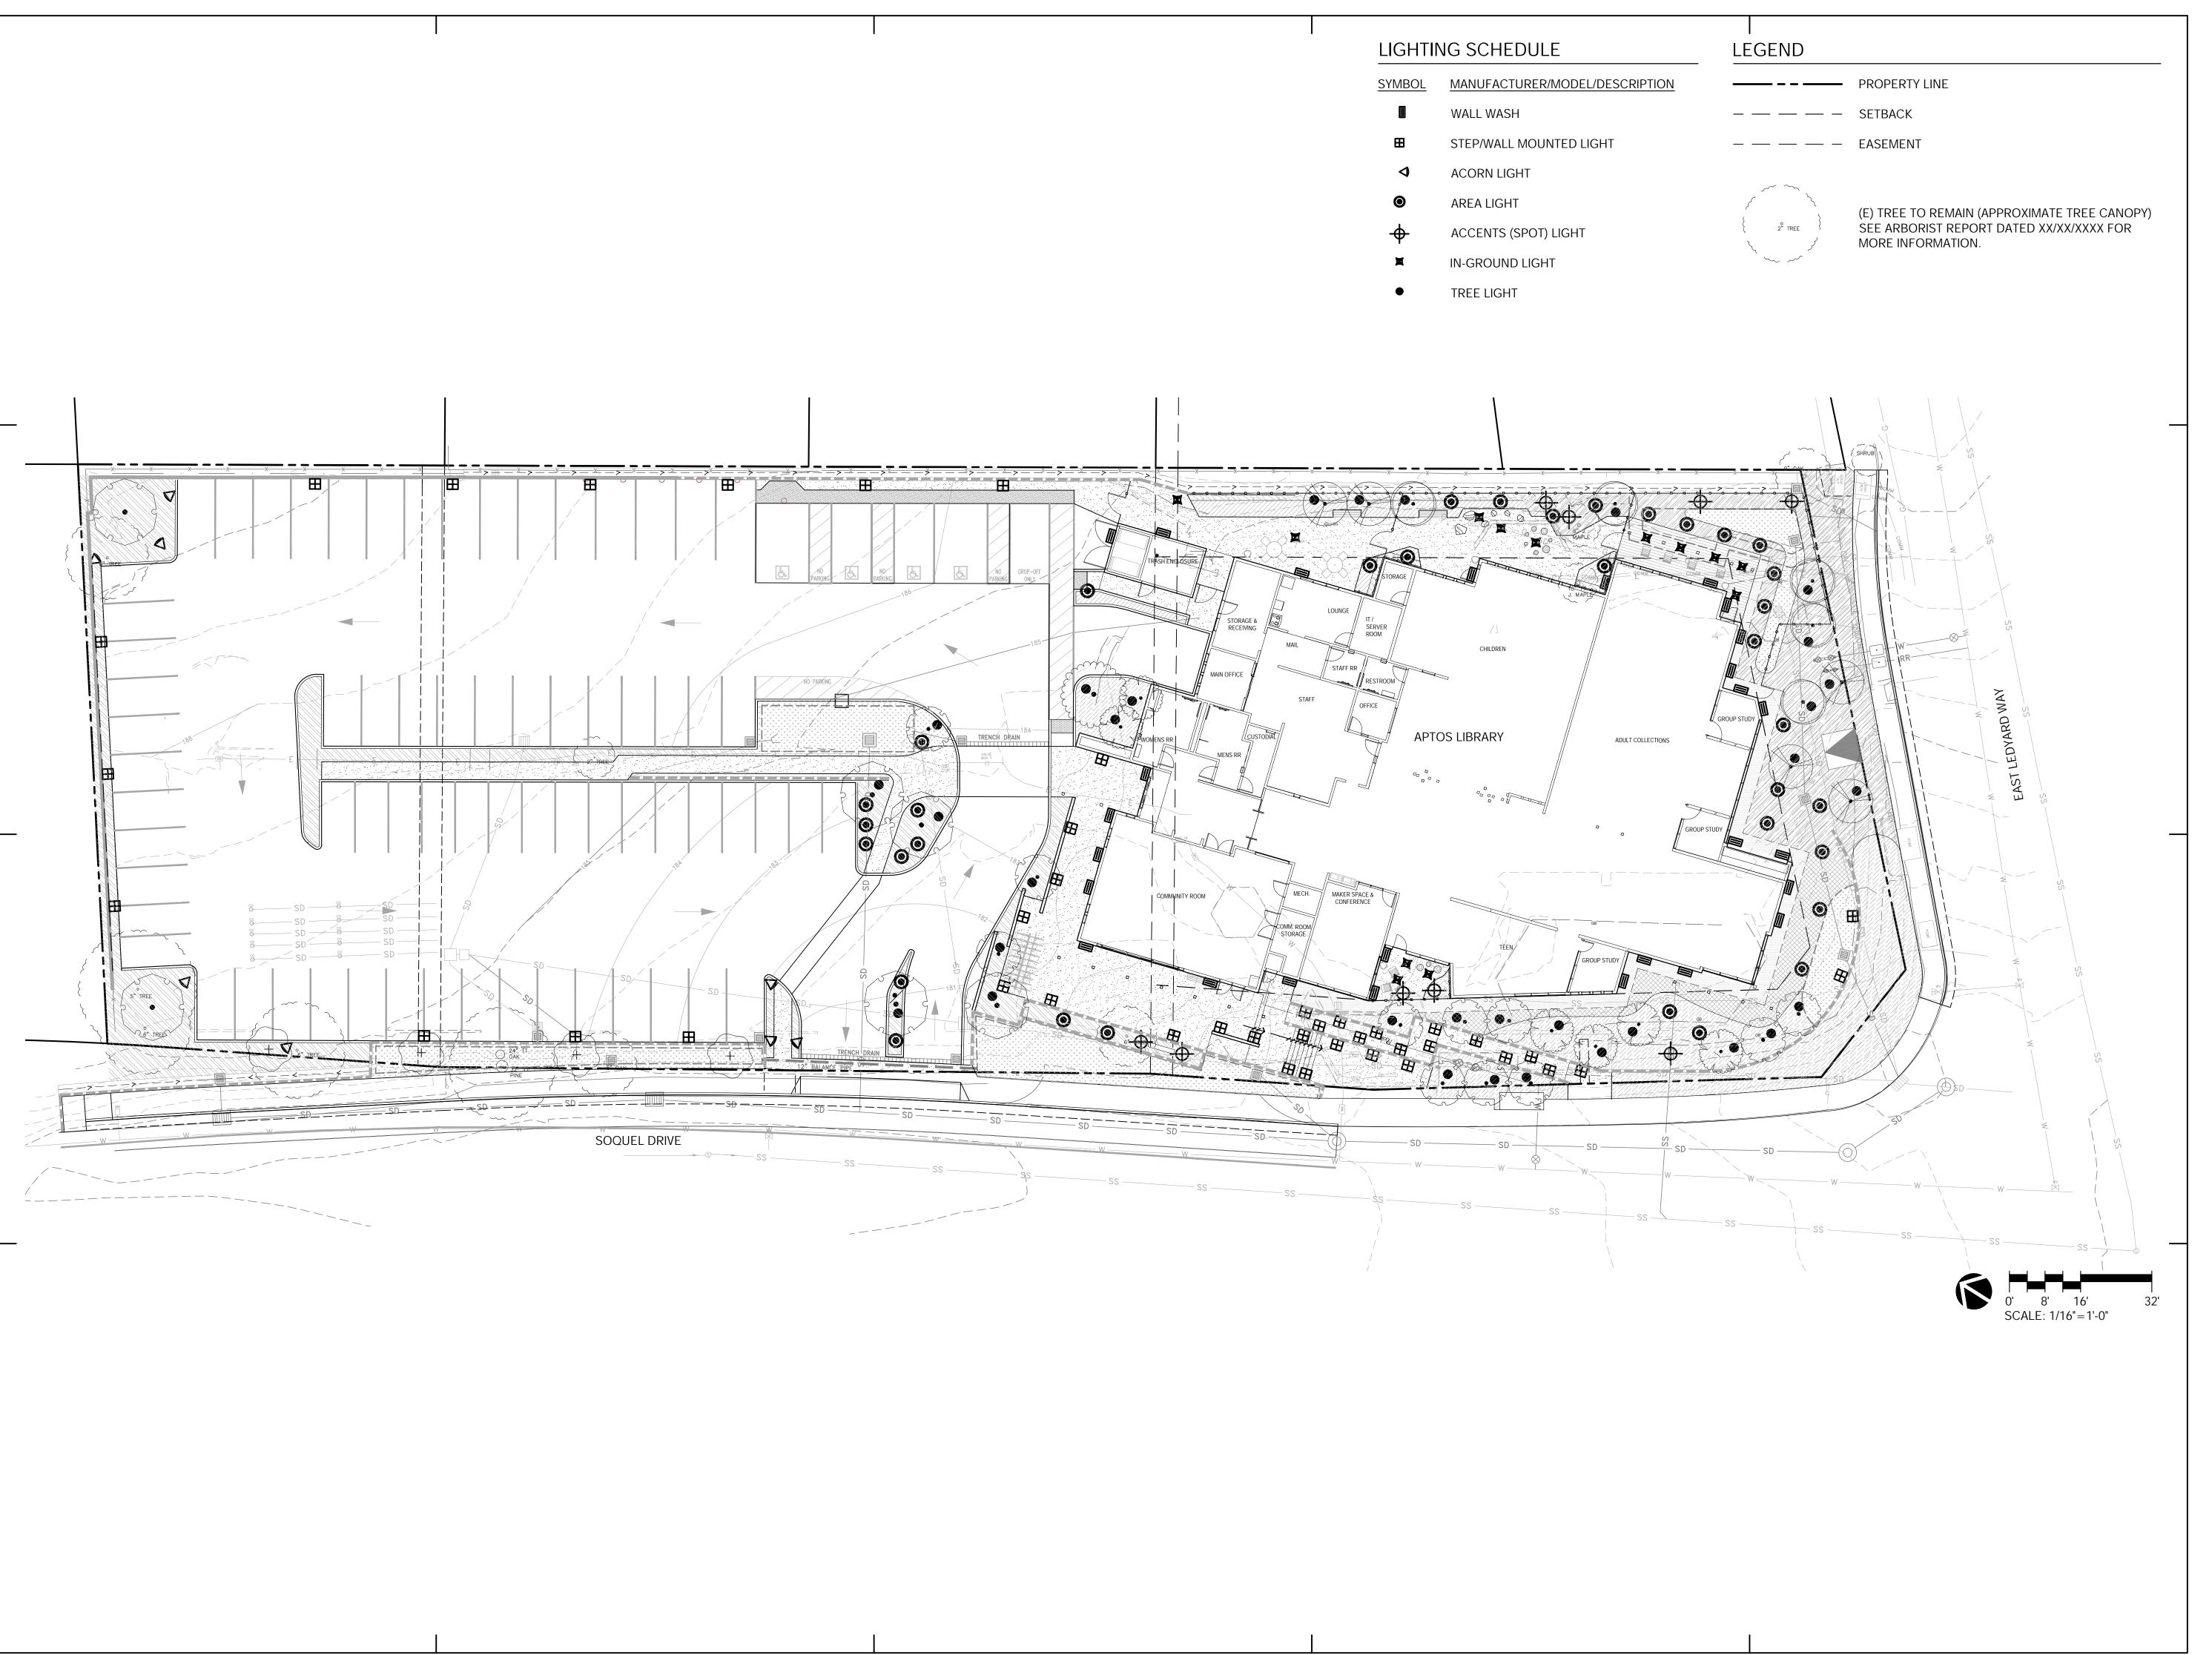
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PLANTING ENLARGEMENT PLAN

SCALE: 1" = 10'-0"

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L5.02





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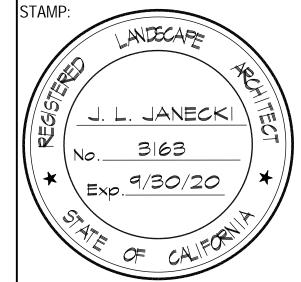
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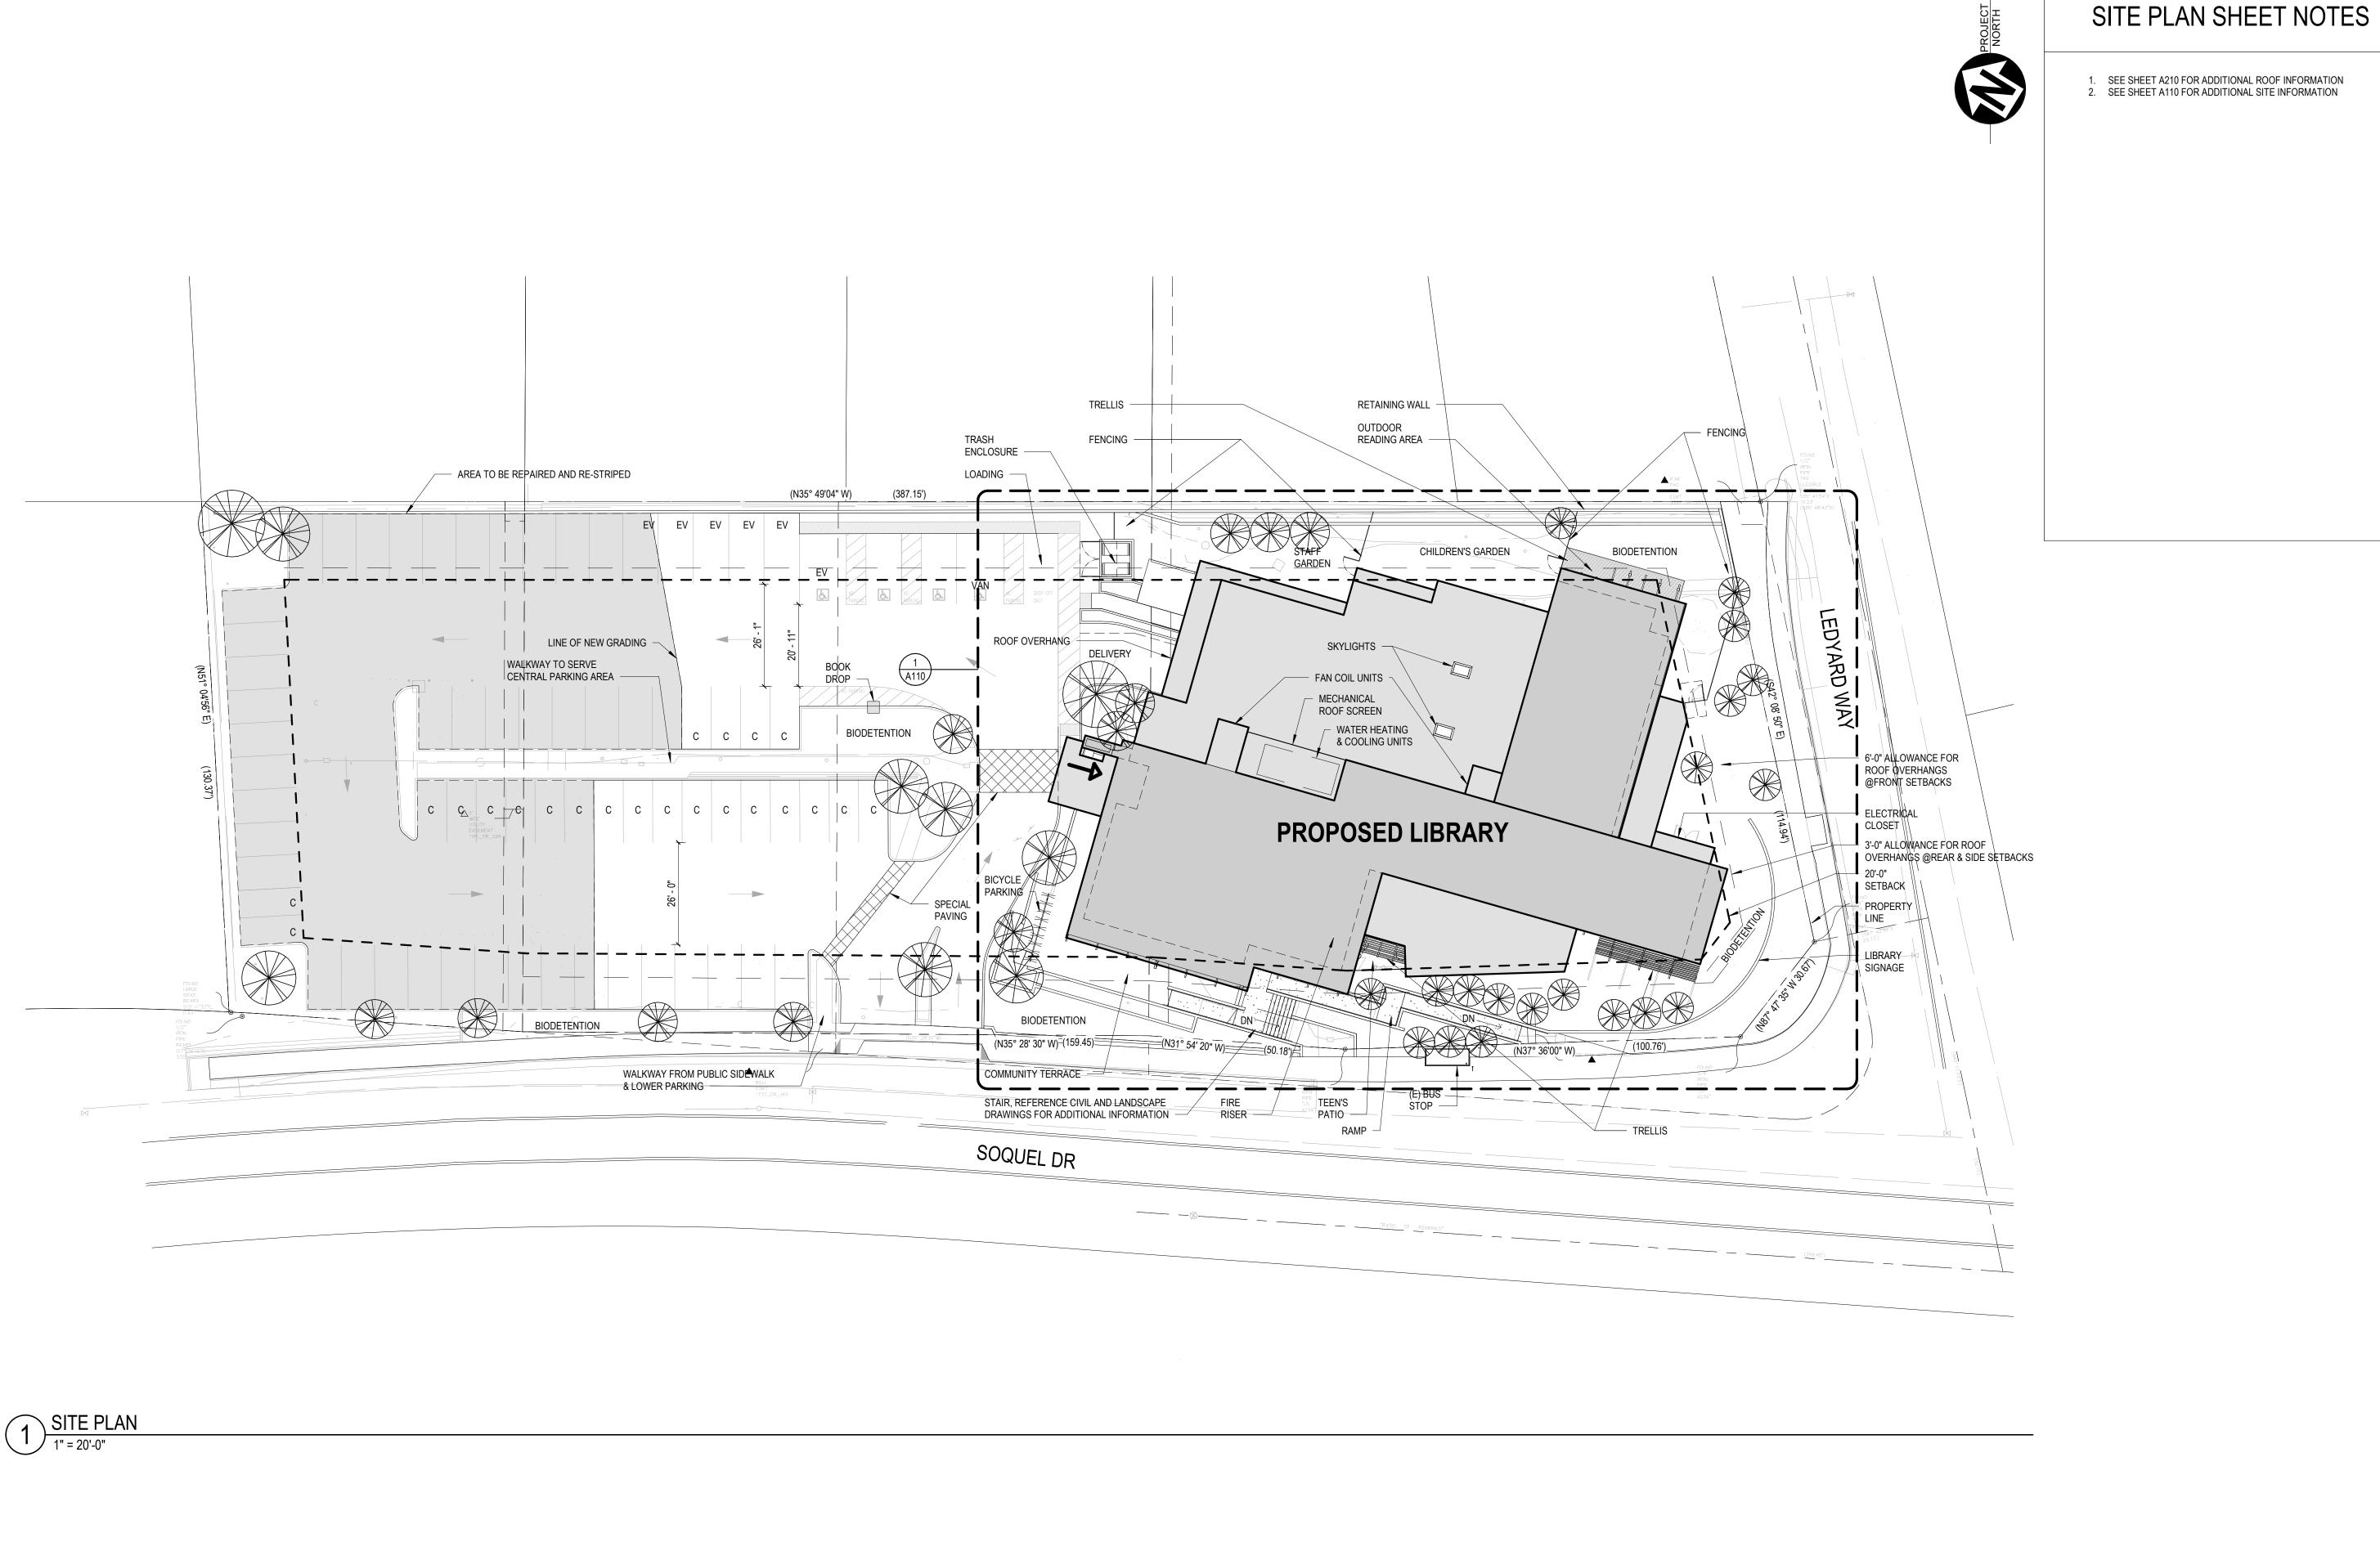
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SHEET TITLE:	

SITE LIGHTING PLAN


SCALE: 1/16"=1'-0"

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L6.00






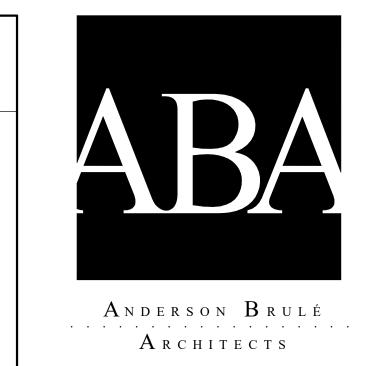

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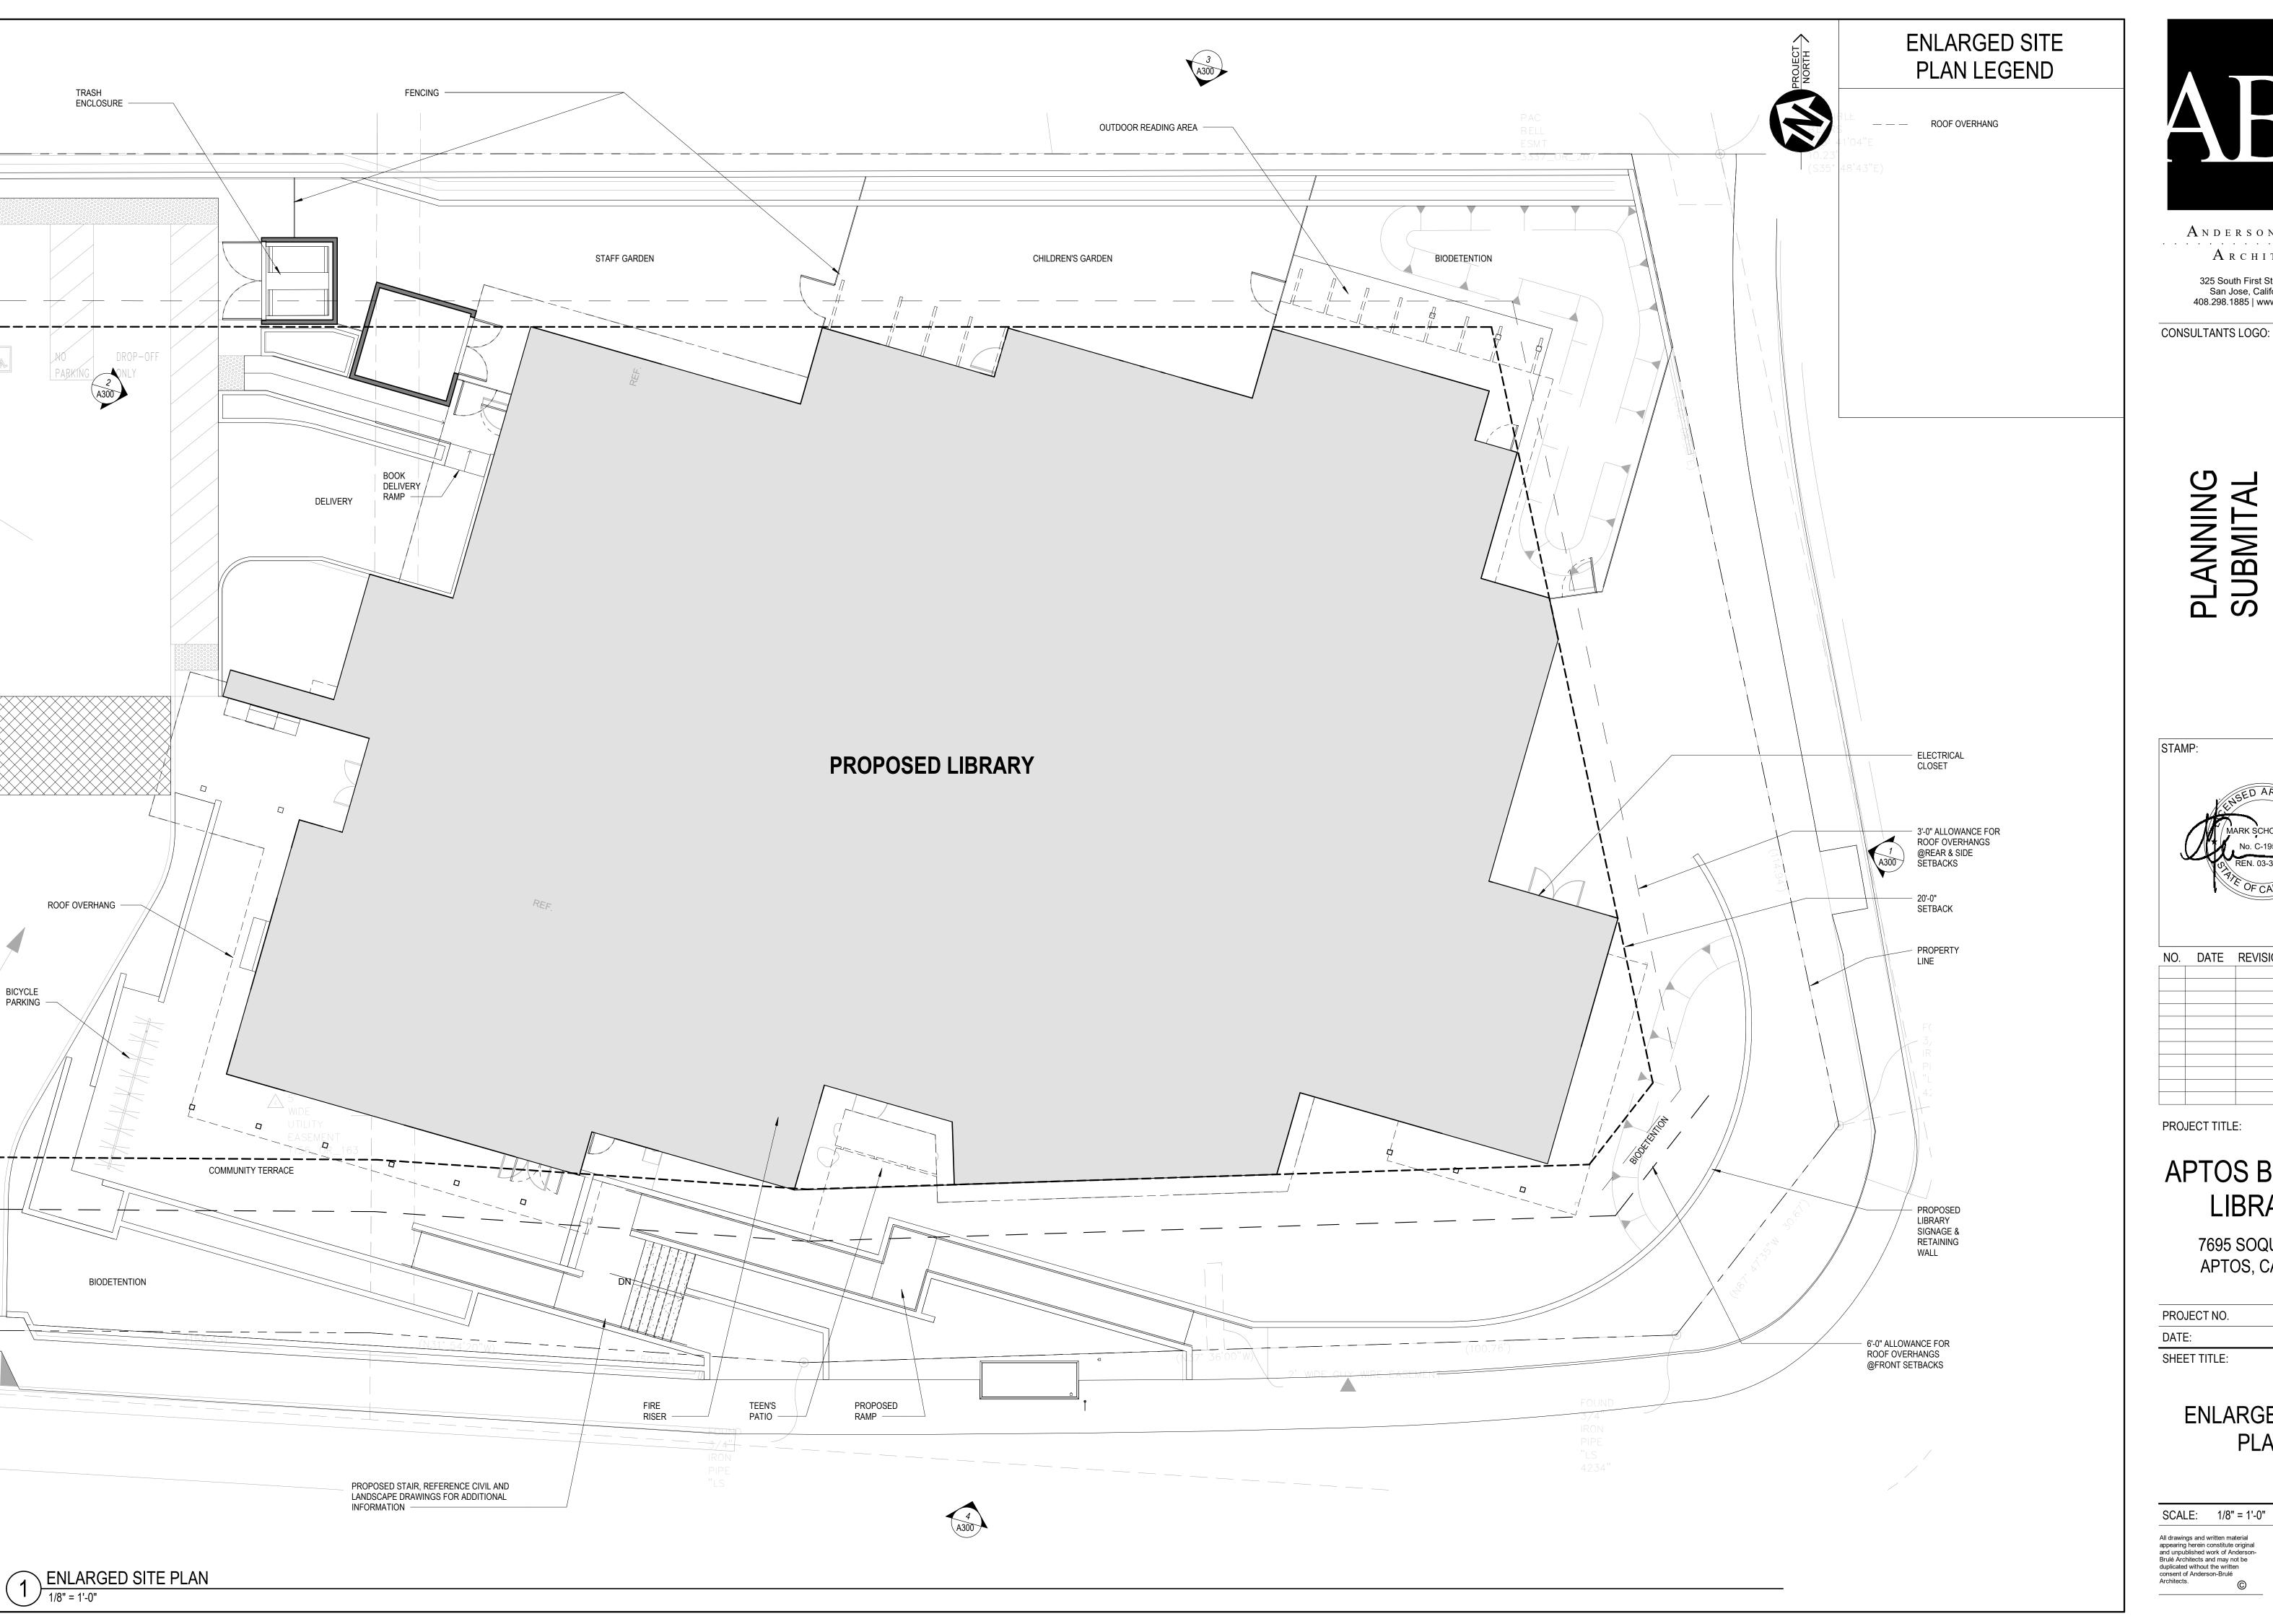
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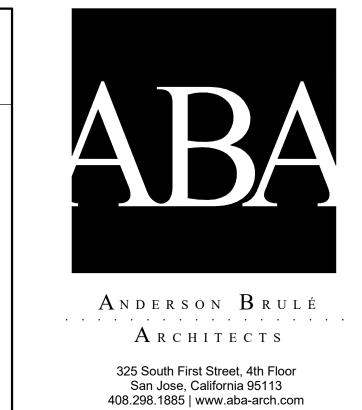
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SITE PLAN


SCALE: 1" = 20'-0"

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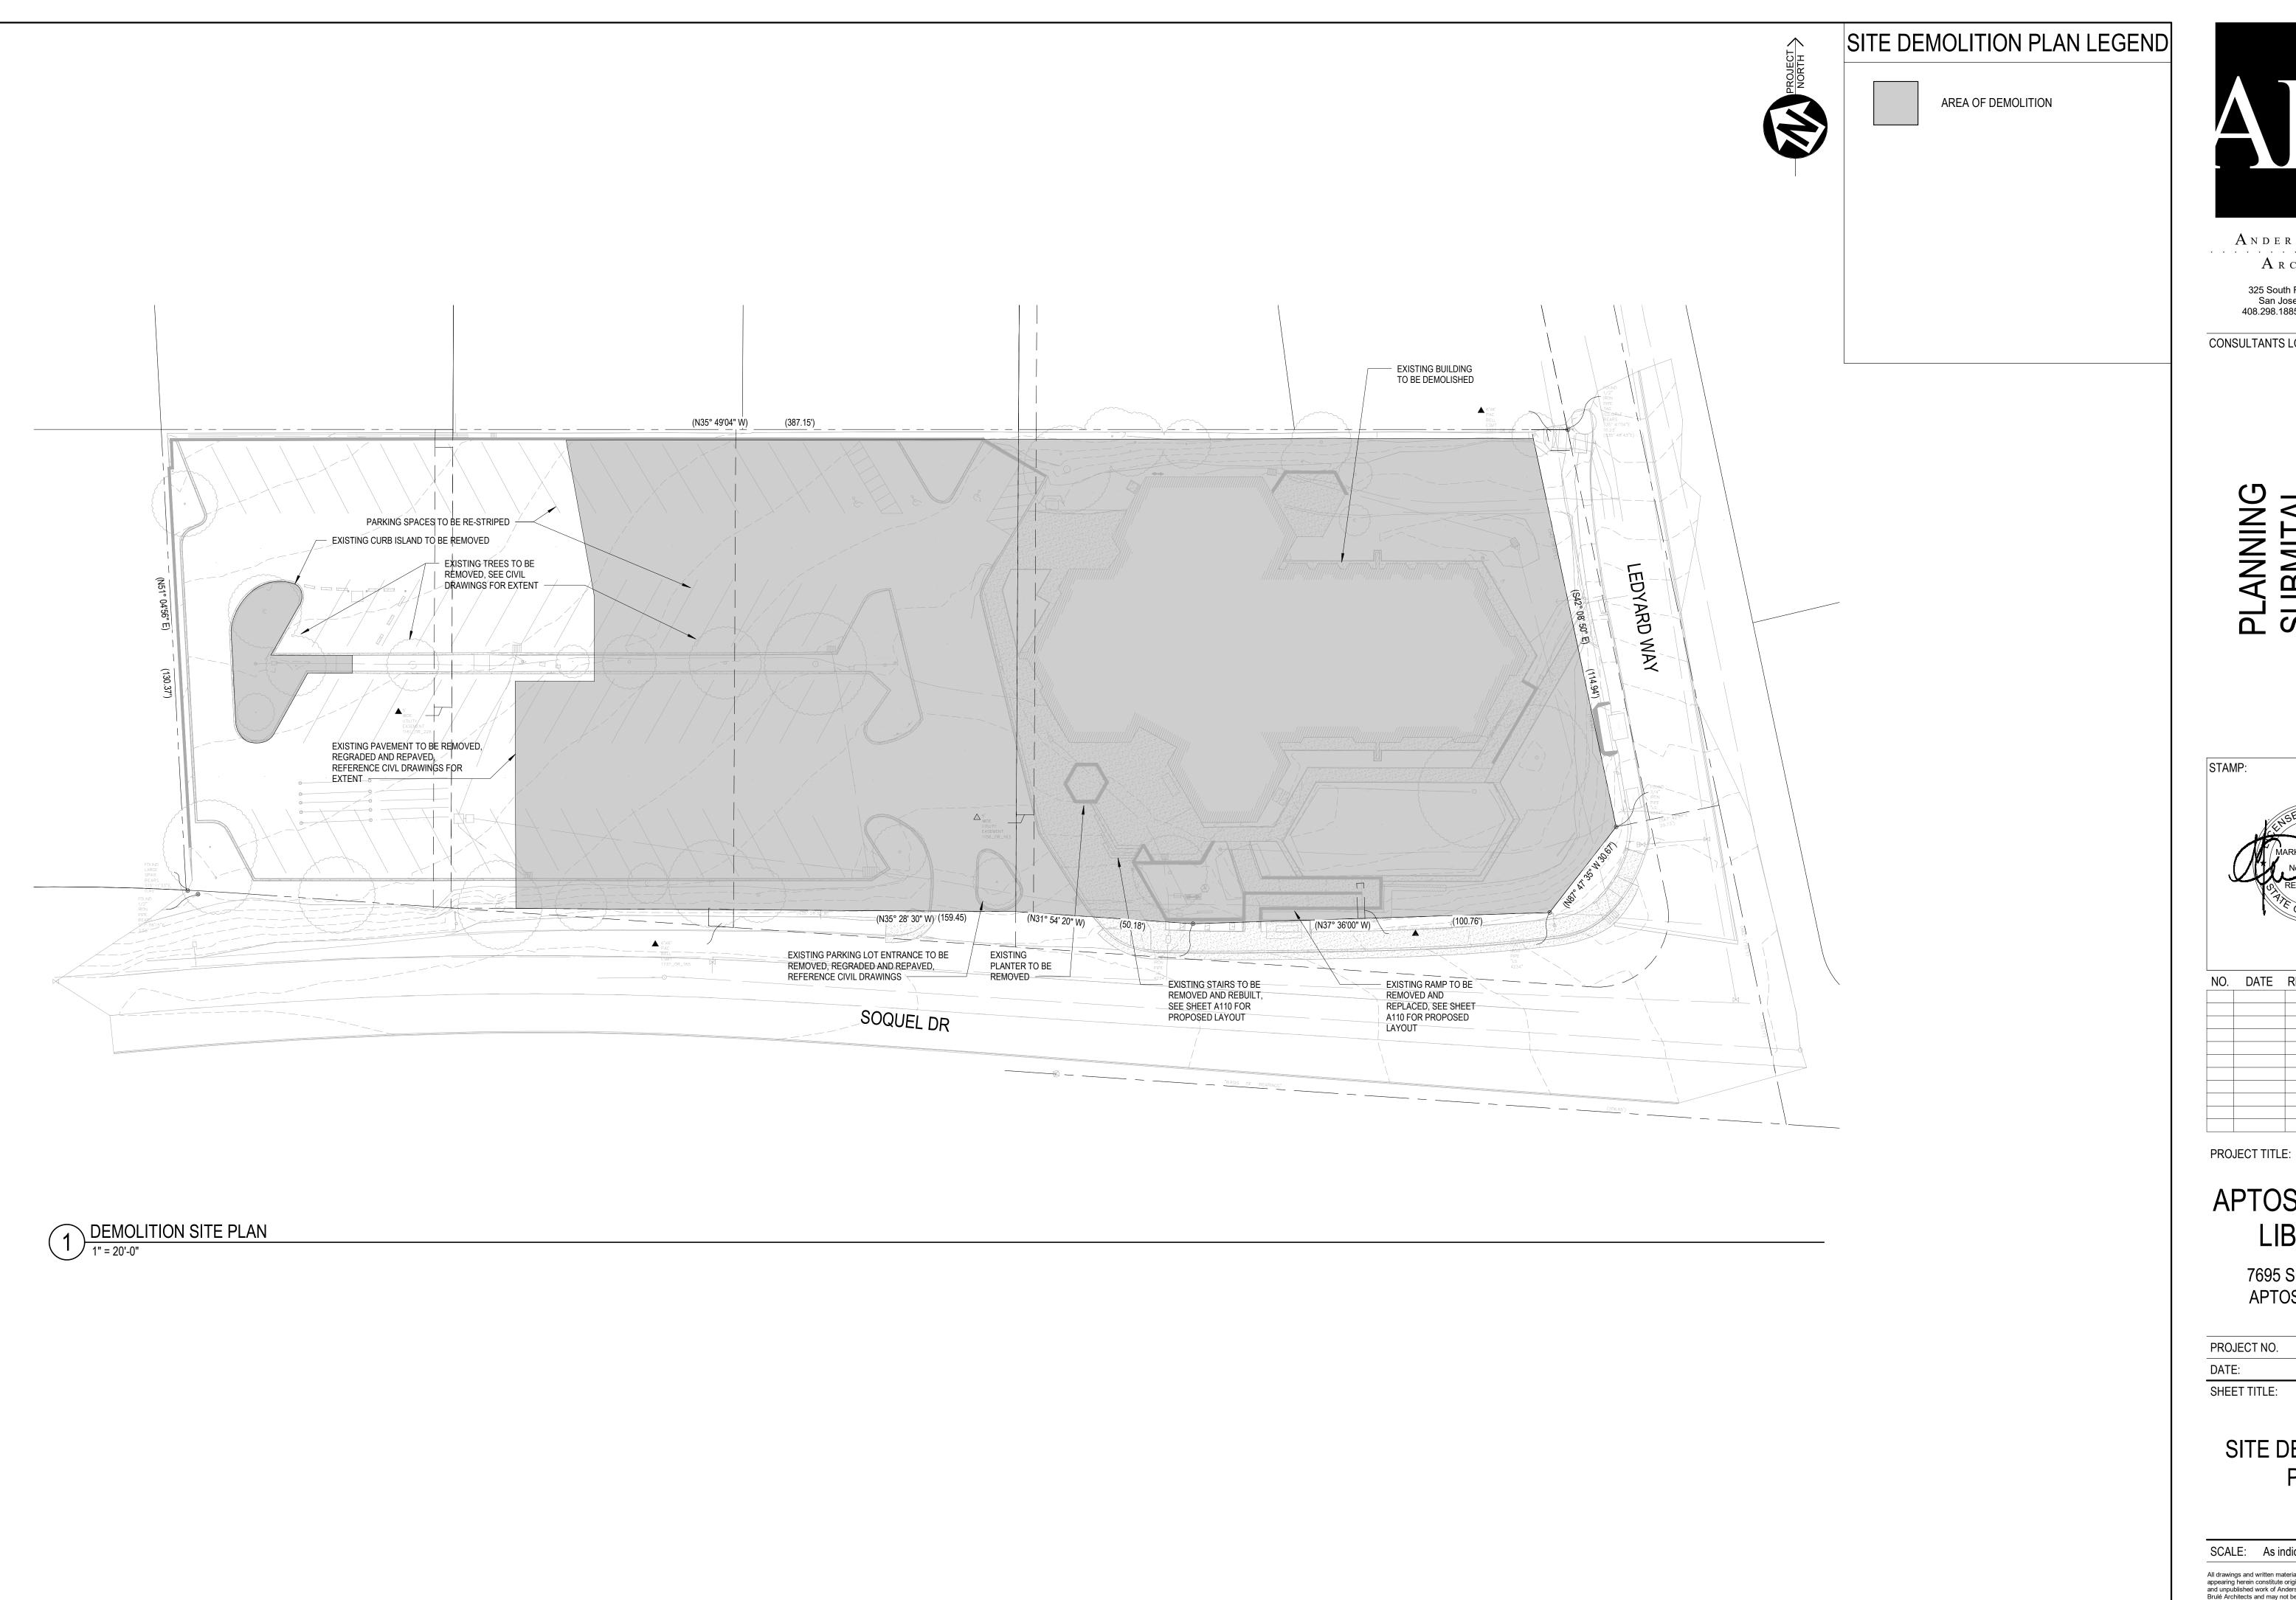
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ENLARGED SITE PLAN

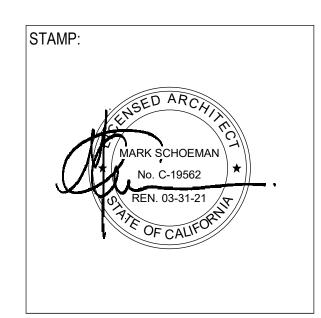SCALE: 1/8" = 1'-0"


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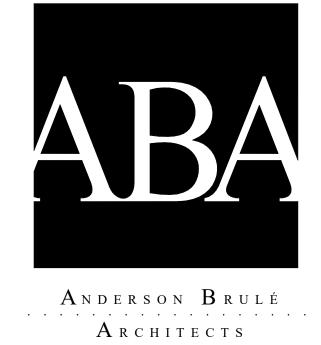
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SITE DEMOLITION PLAN

SCALE: As indicated
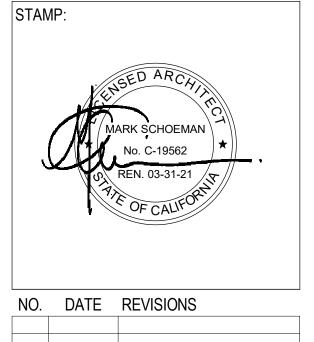
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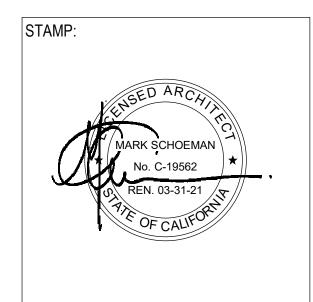


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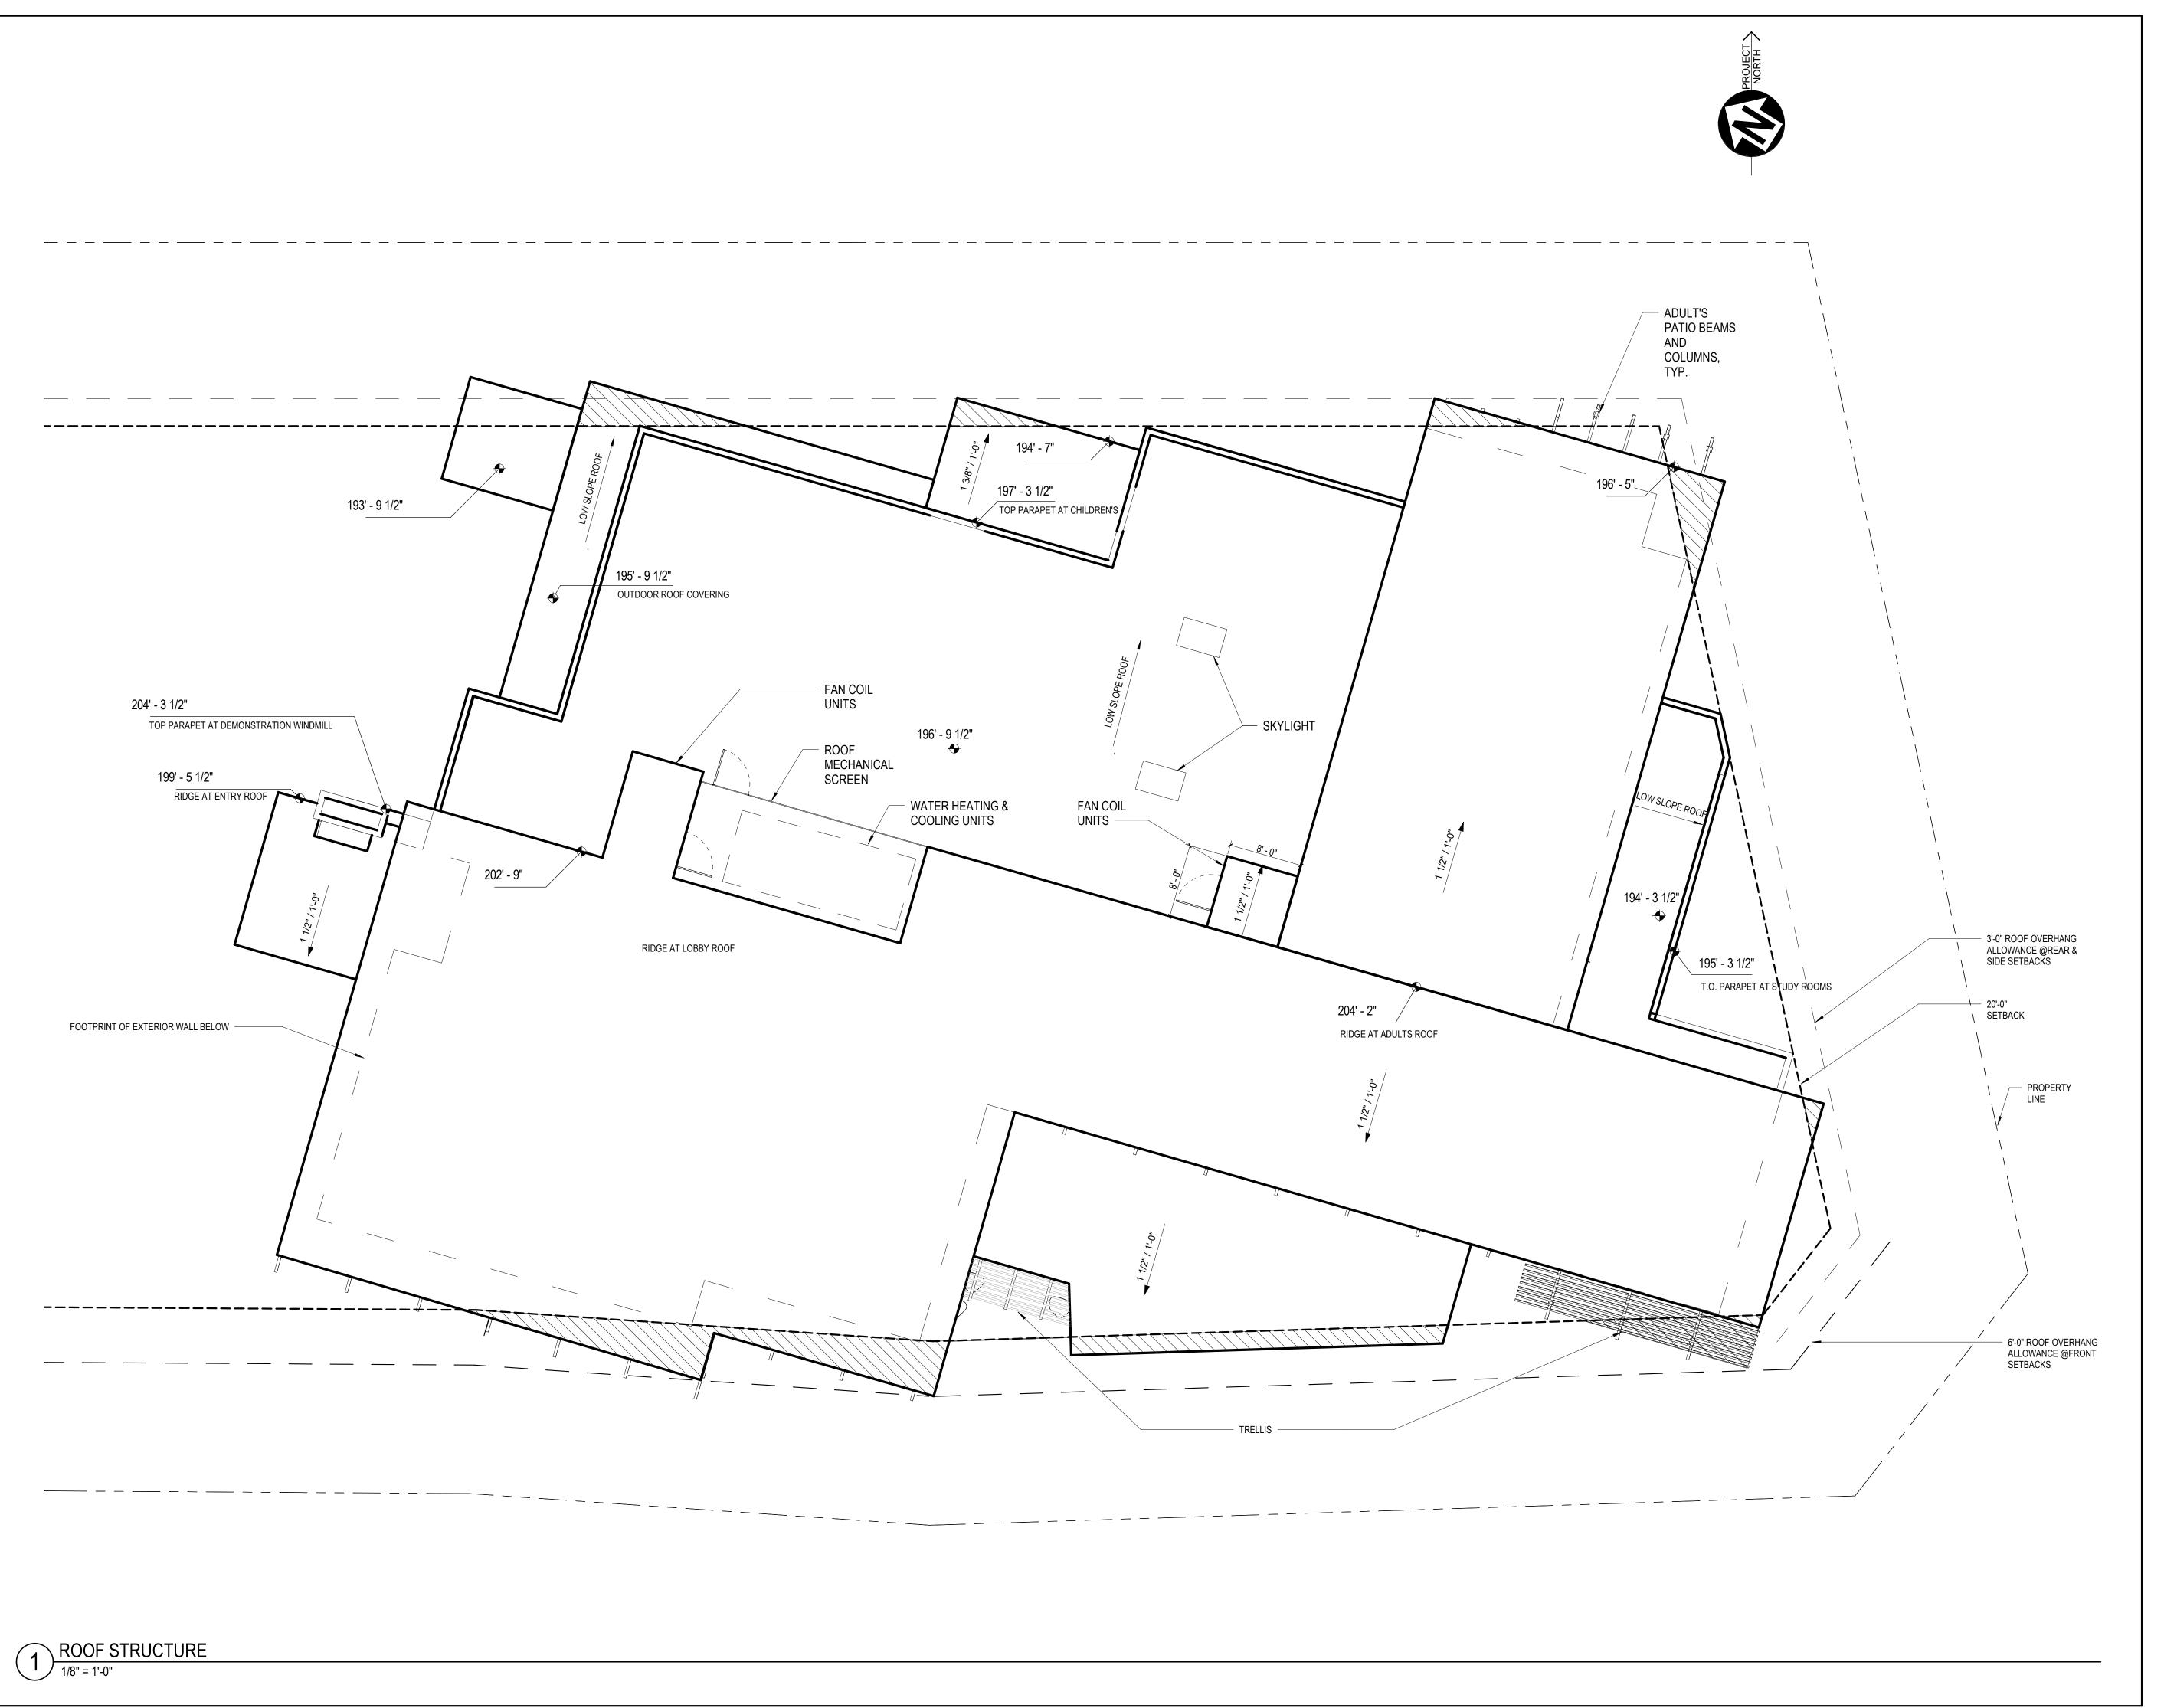
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FLOOR PLAN

SCALE: 1/8" = 1'-0"
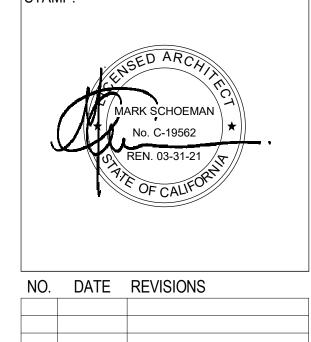
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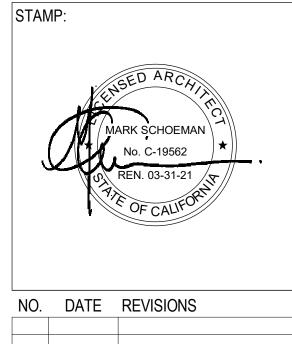


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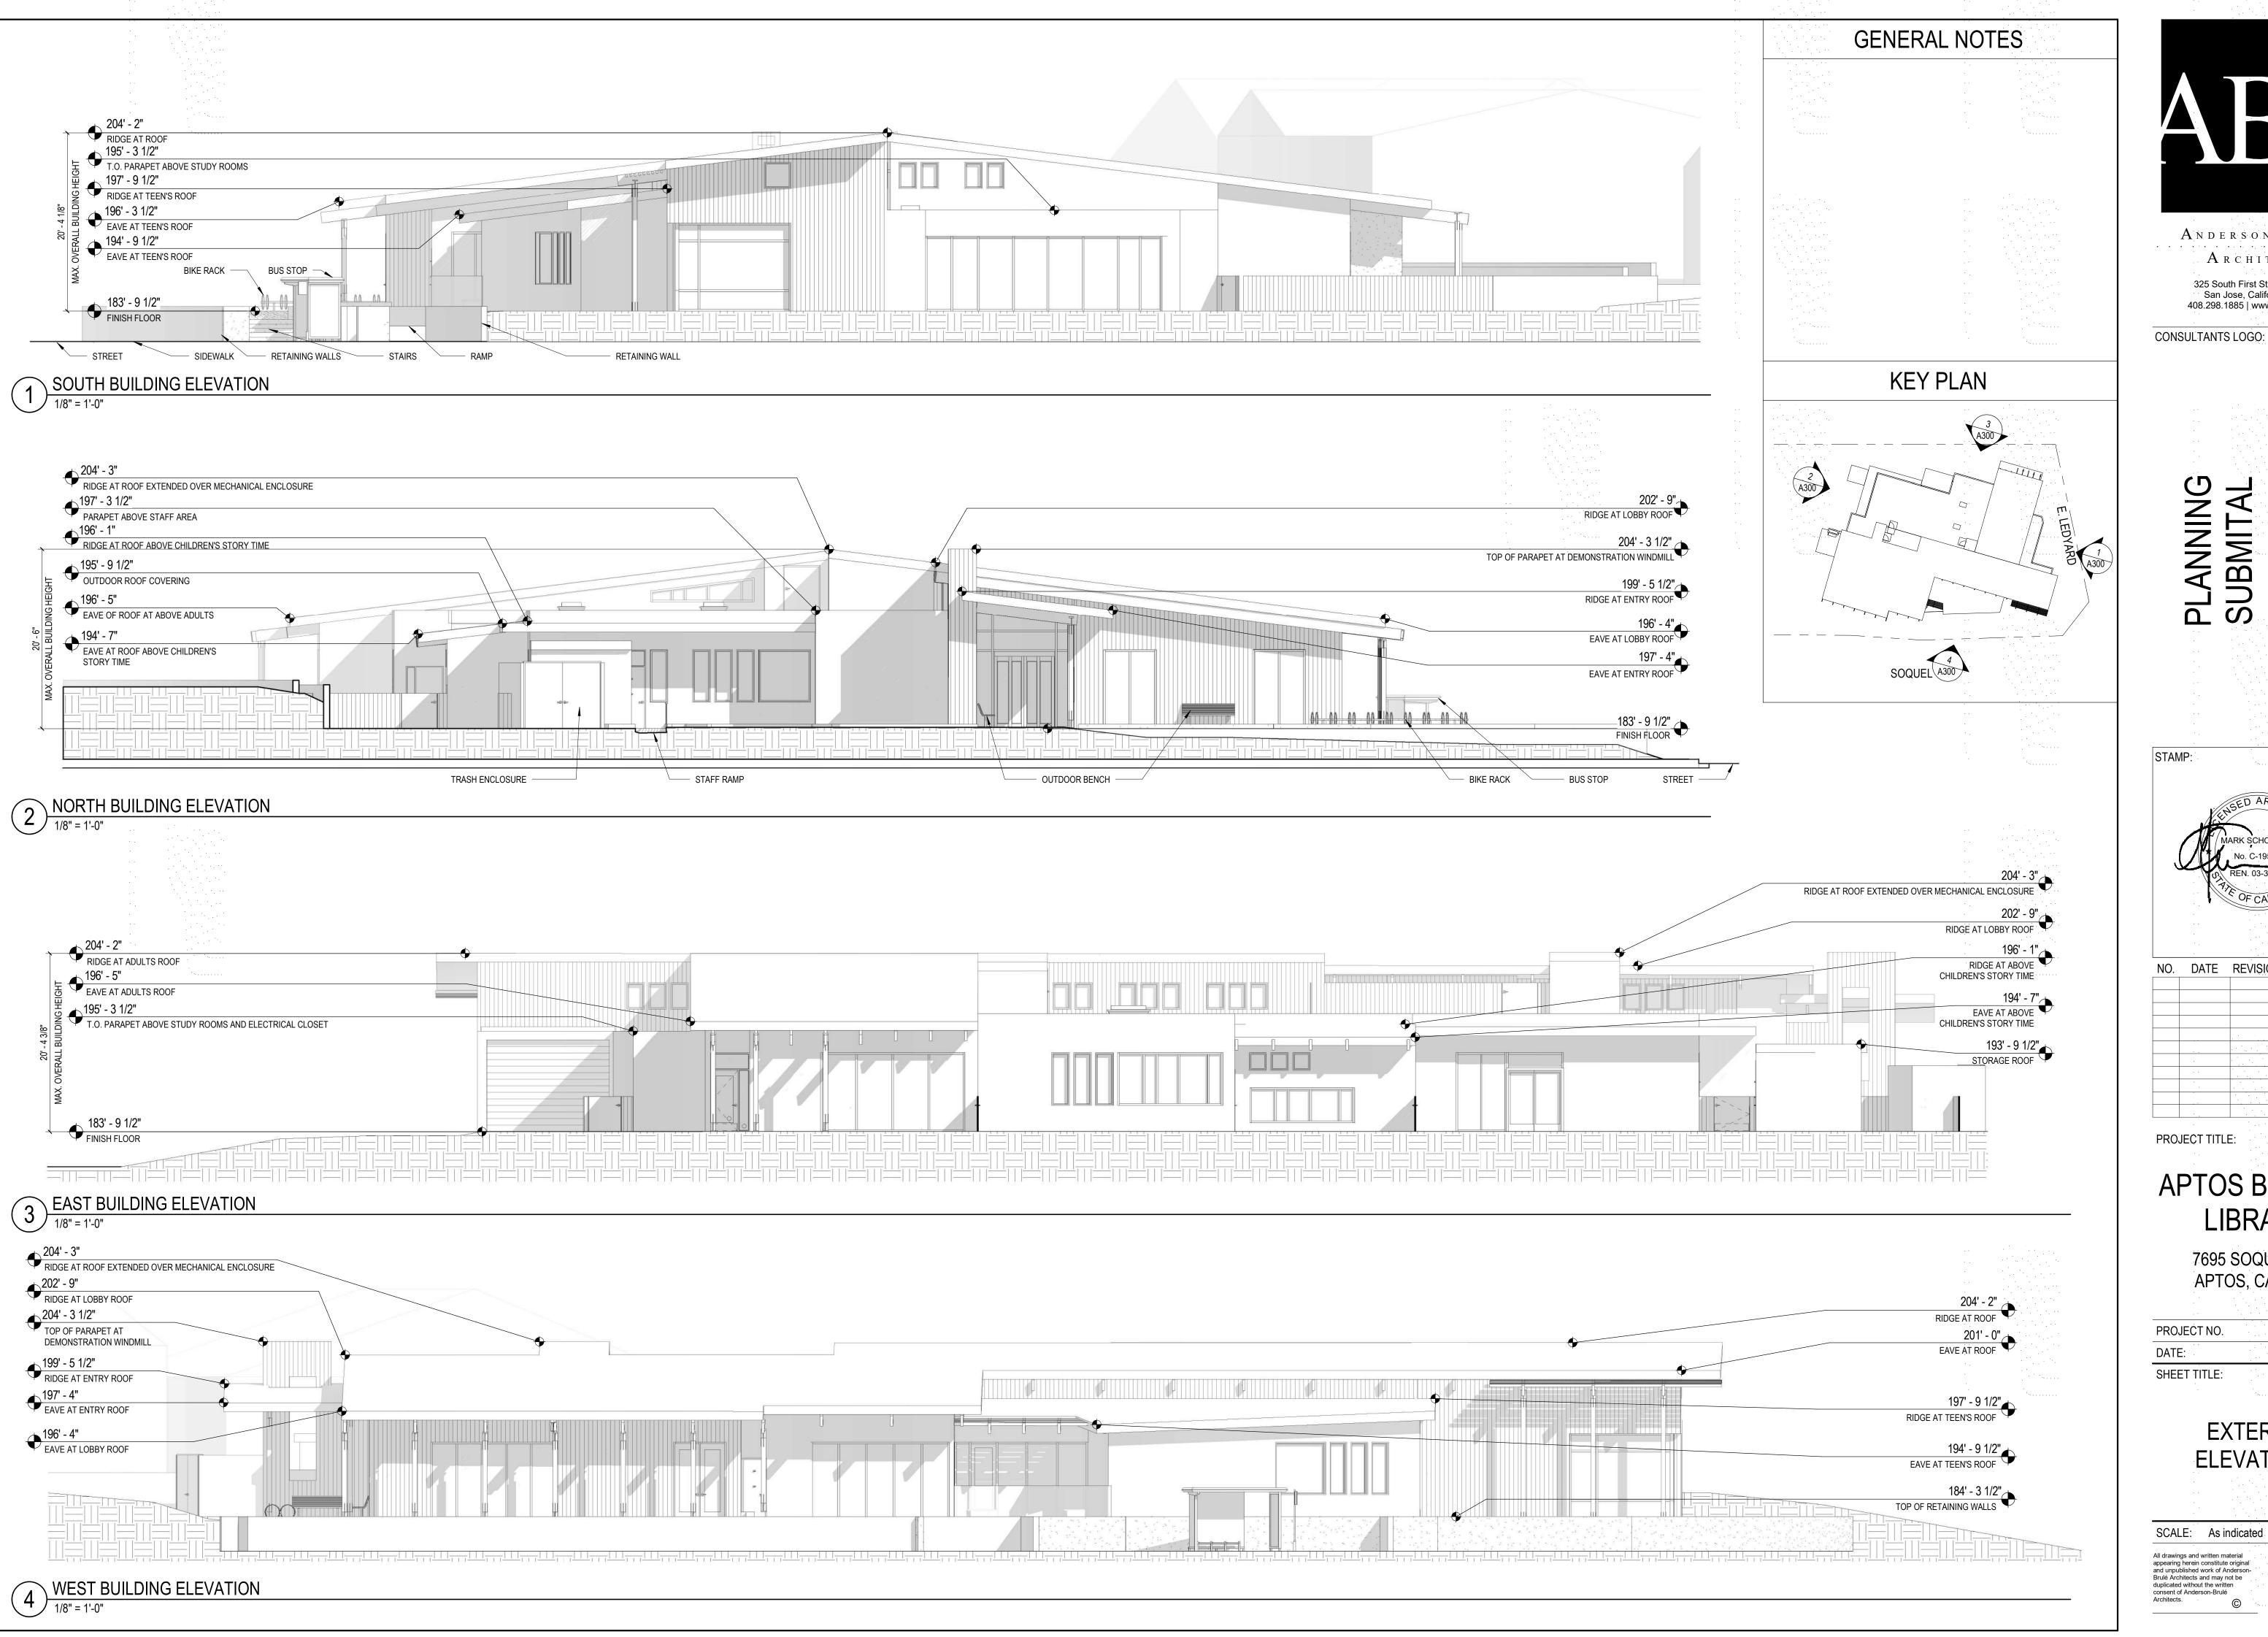
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2004050
11/9/2020

ROOF PLAN


SCALE: 1/8" = 1'-0"

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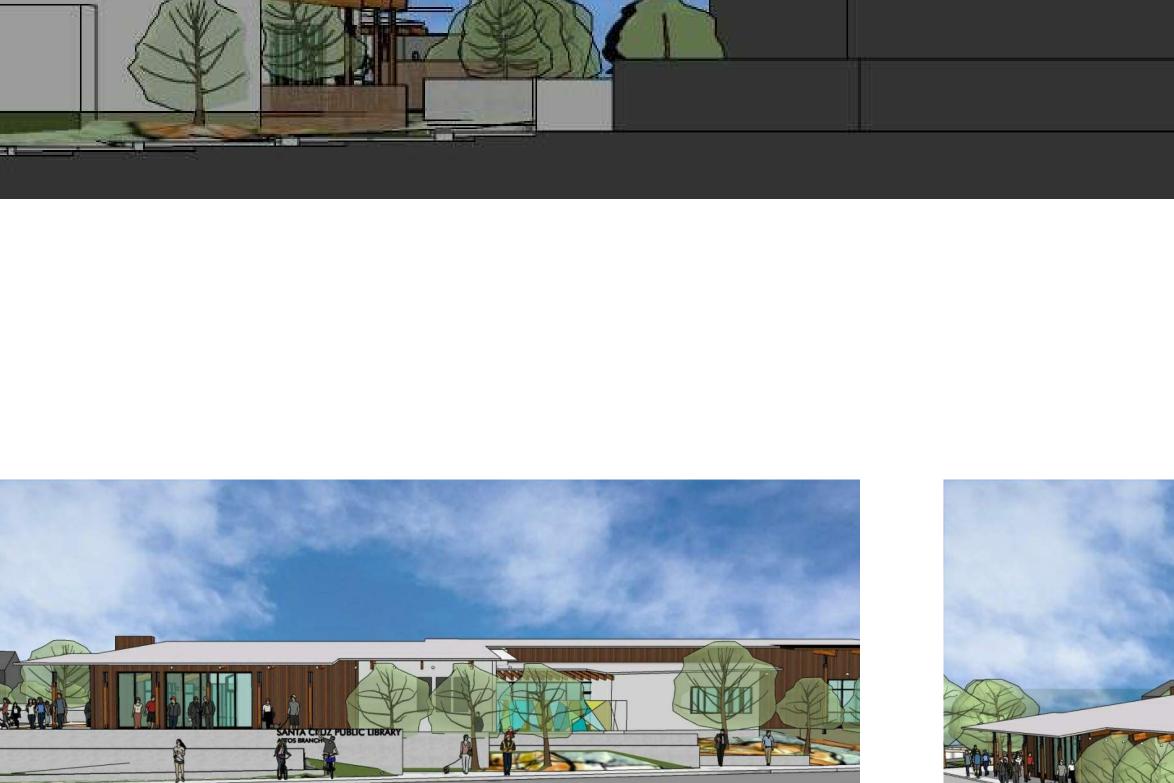
> **EXTERIOR ELEVATIONS**

SCALE: As indicated

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SITE SECTION

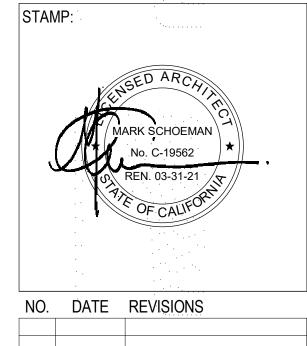

SOQUEL FACADE



SOQUEL FACADE




VIEW FROM CORNER OF LEDYARD AND SOQUEL

AERIAL VIEW



BACK PORCH

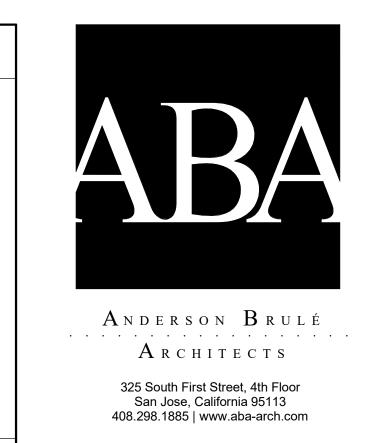

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SITE SECTION KEY PLAN

SOQUEL

PLASTER -

OFF WHITE

WOOD/ WOOD

COMPOSITE

📺 GLAZING -

BRONZE

GLAZING -STOREFRONT DARK ANODIZED

MATERIAL LEGEND

CONCRETE/ STACKED MASONRY

ROOF -

TPO - OFF WHITE

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SITE SECTION AND MASSING PERSPECTIVES

SCALE: 1" = 50'-0"

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A400

MAIN ENTRANCE