COUNTY OF SANTA CRUZ PLANNING DEPARTMENT 701 Ocean Street, 4th Floor

Santa Cruz, CA 95060 (831) 454-2580

NOTICE OF PENDING ACTION

The Planning Department has received the following application. The identified planner may be contacted for specific information on this application.

APPLICATON NUMBER: 241213 APN: 054-601-38 SITUS ADDRESS: 2277 Dolphin Drive, Aptos, CA 95003

Proposal to construct a new external steel, spiral staircase from the living room and recognize the existing configuration of the dwelling with 5 bedrooms.

Requires an Administrative Coastal Development Permit.

Property located on the northwestern corner of Dolphin Drive and Via Trinita (2277 Dolphin Drive).

OWNER: Steve Allen

APPLICANT: Fuse Architecture c/o: Courtney Christiansen

SUPERVISORIAL DISTRICT: 2

PLANNER: Alexandra Corvello, (831) 454-3209

EMAIL: Alexandra.Corvello@santacruzcountyca.gov

Public comments must be received by 5:00 p.m. June 9, 2025. A decision will be made on or shortly after June 10, 2025.

Appeals of the decision will be accepted until 5:00 p.m. two weeks after the decision date. If you would like to request a public hearing be held for this item, please contact the project planner listed on this notice. Information regarding the appeal process, including required fees, may be

For more information, contact the project planner identified above.

obtained by phoning (831) 454-2130.

GENERAL NOTES

1. ALL WORK SHALL COMPLY STRICTLY WITH THE CALIFORNIA BUILDING CODE LATEST EDITION (2022) AND ALL LOCAL CODES AND ORDINANCES.

2. ALL DIMENSIONS ARE TO FACE OF CONCRETE, MASONRY OR STUD FRAMING UNLESS NOTED OTHERWISE.

3. DRAWINGS ARE NOT TO BE SCALED. ANY DIMENSIONAL DISCREPANCIES SHALL BE CLARIFIED WITH THE ARCHITECT.

4. CONTRACTOR SHALL NOTIFY ARCHITECT IMMEDIATELY OF ANY UNUSUAL GEOLOGICAL CONDITIONS.

5. CONTRACTOR SHALL VERIFY ALL DIMENSIONS AND SITE CONDITIONS AND SHALL REPORT ANY INCONSISTENCIES TO THE ARCHITECT PRIOR TO BEGINNING CONSTRUCTION. COMMENCEMENT OF WORK IMPLIES ACCEPTANCE OF SAID CONDITIONS.

6. CONTRACTOR SHALL VERIFY THE LOCATION AND SHALL PROVIDE PROTECTION FOR UTILITIES WITHIN THE WORK AREA, WHETHER OR NOT INDICATED IN THE DRAWINGS. CONTRACTOR SHALL NOTIFY UTILITY COMPANY IMMEDIATELY OF ANY PROBLEM OR POTENTIAL PROBLEM WITH UTILITIES.

7. GRADE IS TO SLOPE AWAY FROM THE BUILDING A MINIMUM OF 5% FOR A MINIMUM OF 10 FEET ALL AROUND

8. MECHANICAL, PLUMBING AND ELECTRICAL TO BE DESIGN BUILD, INCLUDED ITEMS ARE SCHEMATIC AND THE INSTALLATION SHALL BE REVIEWED BY THE BUILDING INSPECTOR, IN THE FIELD.

9. BUILDING NUMBERS SHALL BE PROVIDED. NUMBERS SHALL BE A MINIMUM OF 4 INCHES IN HEIGHT ON A CONTRASTING BACKGROUND AND VISIBLE FROM THE STREET, ADDITIONAL NUMBERS SHALL BE INSTALLED ON A DIRECTIONAL SIGN AT THE PROPERTY DRIVEWAY AND

15. n/a.


16. THESE PLANS ARE IN COMPLIANCE WITH CALIFORNIA BUILDING AND FIRE CODES (2022) AND DISTRICT AMENDMENT.

17. DRAINAGE AND DRAINAGE FEATURES SHALL CONFORM TO NPDES REQUIREMENTS

18. A BUILDING MAINTENANCE AND OPERATIONS MANUAL THAT STAYS WITH THE STRUCTURE WILL BE PLACED IN THE BUILDING AT THE TIME OF FINAL INSPECTION IN THE FORM OF A BOOKLET, COMPACT DISC, WEB-BASED REFERENCE OR OTHER MEDIA ACCEPTABLE TO THE ENFORCING AGENCY PER 2022 CALGreen 4.410.



FINISH / COLOR OF PROPOSED SPIRAL STAIR POWDER COATED ALUMINUM STAIR MATTE BLACK FINISH / MANUFACTURED PRE-FINISHED

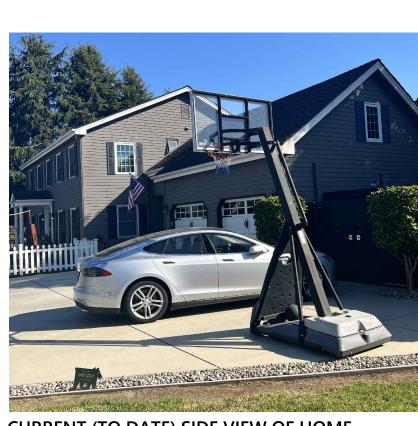

CURRENT (TO DATE) SIDE VIEW OF HOME (ONLY AFFECTED SIDE OF THE HOME / ALL ALTERATIONS TO MATCH CURRENT COLOR / MATERIALS SHOWN)

BUILDING CODE

OCCUPANCY TYPE OF CONSTRUCTION FIRE SPRINKLERS

2022 CBC, CMC, CPC, CEC, & CFC APPLICABLE CODES

2022 CALIFORNIA ENERGY CODE, CGBSC & ANY OTHER APPLICABLE LOCAL CODES

DEFERRED SUBMITTALS


DESCRIPTION OF WORK

PROPOSAL TO ADD (N) EXTERIOR STEEL STAIR & (N) SECOND STORY EXTERIOR DOOR TO REPLACE SECOND STORY (E) WINDOW. (N) SPIRAL STAIR & (N) EXTERIOR DOOR TO PROVIDE ADDITIONAL EGRESS TO THE (E) UPSTAIRS AREAS. ADDITIONALLY WITHIN THIS PERMIT: TO RECOGNIZE ALL EXISTING AREAS NOT RECOGNIZED WITHIN REPORTED RECORDS & ARCHIVAL DOCUMENTS. NOTE: CURRENT HOA APPROVAL PENDING COUNTY BUILDING PERMIT APPROVAL. PHOTO TIMELINE:



SIDE VIEW OF HOME [ref: 2007 google maps] (SEE SHEET A3 FOR ARCHIVAL INFORMATION TO REFERENCE PHOTO TIMELINES AS WELL AS ARCHIVED RECORD DOCUMENTS)

BIRDS-EYE VIEW OF HOME [ref: 2007 google maps]

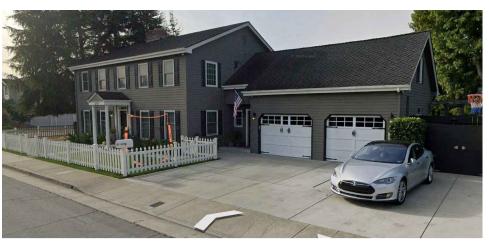

SIDE VIEW OF HOME [ref: 2024 google maps] (SEE SHEET A3 FOR ARCHIVAL INFORMATION TO REFERENCE PHOTO TIMELINES AS WELL AS ARCHIVED RECORD DOCUMENTS)

BIRDS-EYE VIEW OF HOME [ref: 2024 google maps]



ENGINEER REDWOOD ENGINEERING LEONARD WILLIS 1535 SEABRIGHT AVENUE #200 PH. 831.426.8444 SANTA CRUZ CA 95062 leonard@redwoodengineering.net

DANIEL GOMEZ

PH. 831.479.9295

DRAWING INDEX

ARCHITERCTURAL & STRUCTURAL SHEETS COVER SHEET, SITE PLAN & PROJECT INFORMATION: A1.0 (EXISTING / PROPOSED) LEVEL 01 FLOOR PLAN : A2.0 (EXISTING / PROPOSED) LEVEL 02 FLOOR PLAN: A2.1 FIRST & SECOND FLOOR PLAN - F.A.R. & COVERAGE CALC. : A2.2 ARCHIVE RECORDS & PHOTO TIMELINE: A2.3 EXISTING / PROPOSED EXTERIOR ELEVATIONS : A3.0 EXISTING / PROPOSED EXTERIOR ELEVATIONS: A3.1 EXISTING / PROPOSED BUILDING SECTIONS : A4.0 STRUCTURAL DETAILS: A5.0

MANUFACTURER'S SPECIFICATION SHEETS: MANUFACTURER' S SPECIFICATIONS & DETAILS : A-01 MANUFACTURER'S / SPECIFICATIONS & DETAILS : A-02 MANUFACTURER'S / SPECIFICATIONS & DETAILS : A-03 MANUFACTURER'S / SPECIFICATIONS & DETAILS: A-04

- DASHED LINE TO INDICATE PUE THAT IS SHOWN ON THE SUBDIVISION MAP: VOL. 56 PG. 49 FOR LOT 362 20'-0" Front Set Back (E) RESIDENCE - NO CHANGE -AREA OF, PROPOSED WORK

ARCHITECTURAL SITE PLAN

DOLPHIN DRIVE



DOLPHIN RESIDENCE **STATISTICS**

APN: 054-601-38 2277 DOLPHIN DRIVE

ZONING: R-1-6

SIDE = 5'FRONT = 20'

REAR = 15'

HEIGHT LIMIT: n/a

ARCHITECT

FUSE ARCHITECTS INC.

512 CAPITOLA AVENUE

fuse@fusearchitecture.com

CAPITOLA CA 95010

APTOS, CALIFORNIA 95003


TOTAL SITE AREA: 8,300 s.f.

MAIN BUILDING SETBACKS:

DANIEL J. GOMEZ C-29000 04.30.25 Renewal Date

architects in

ENCE S CA 95003 RESID DOLPHIN DR 2277 DOLPHIN DR APN: 054-601-38

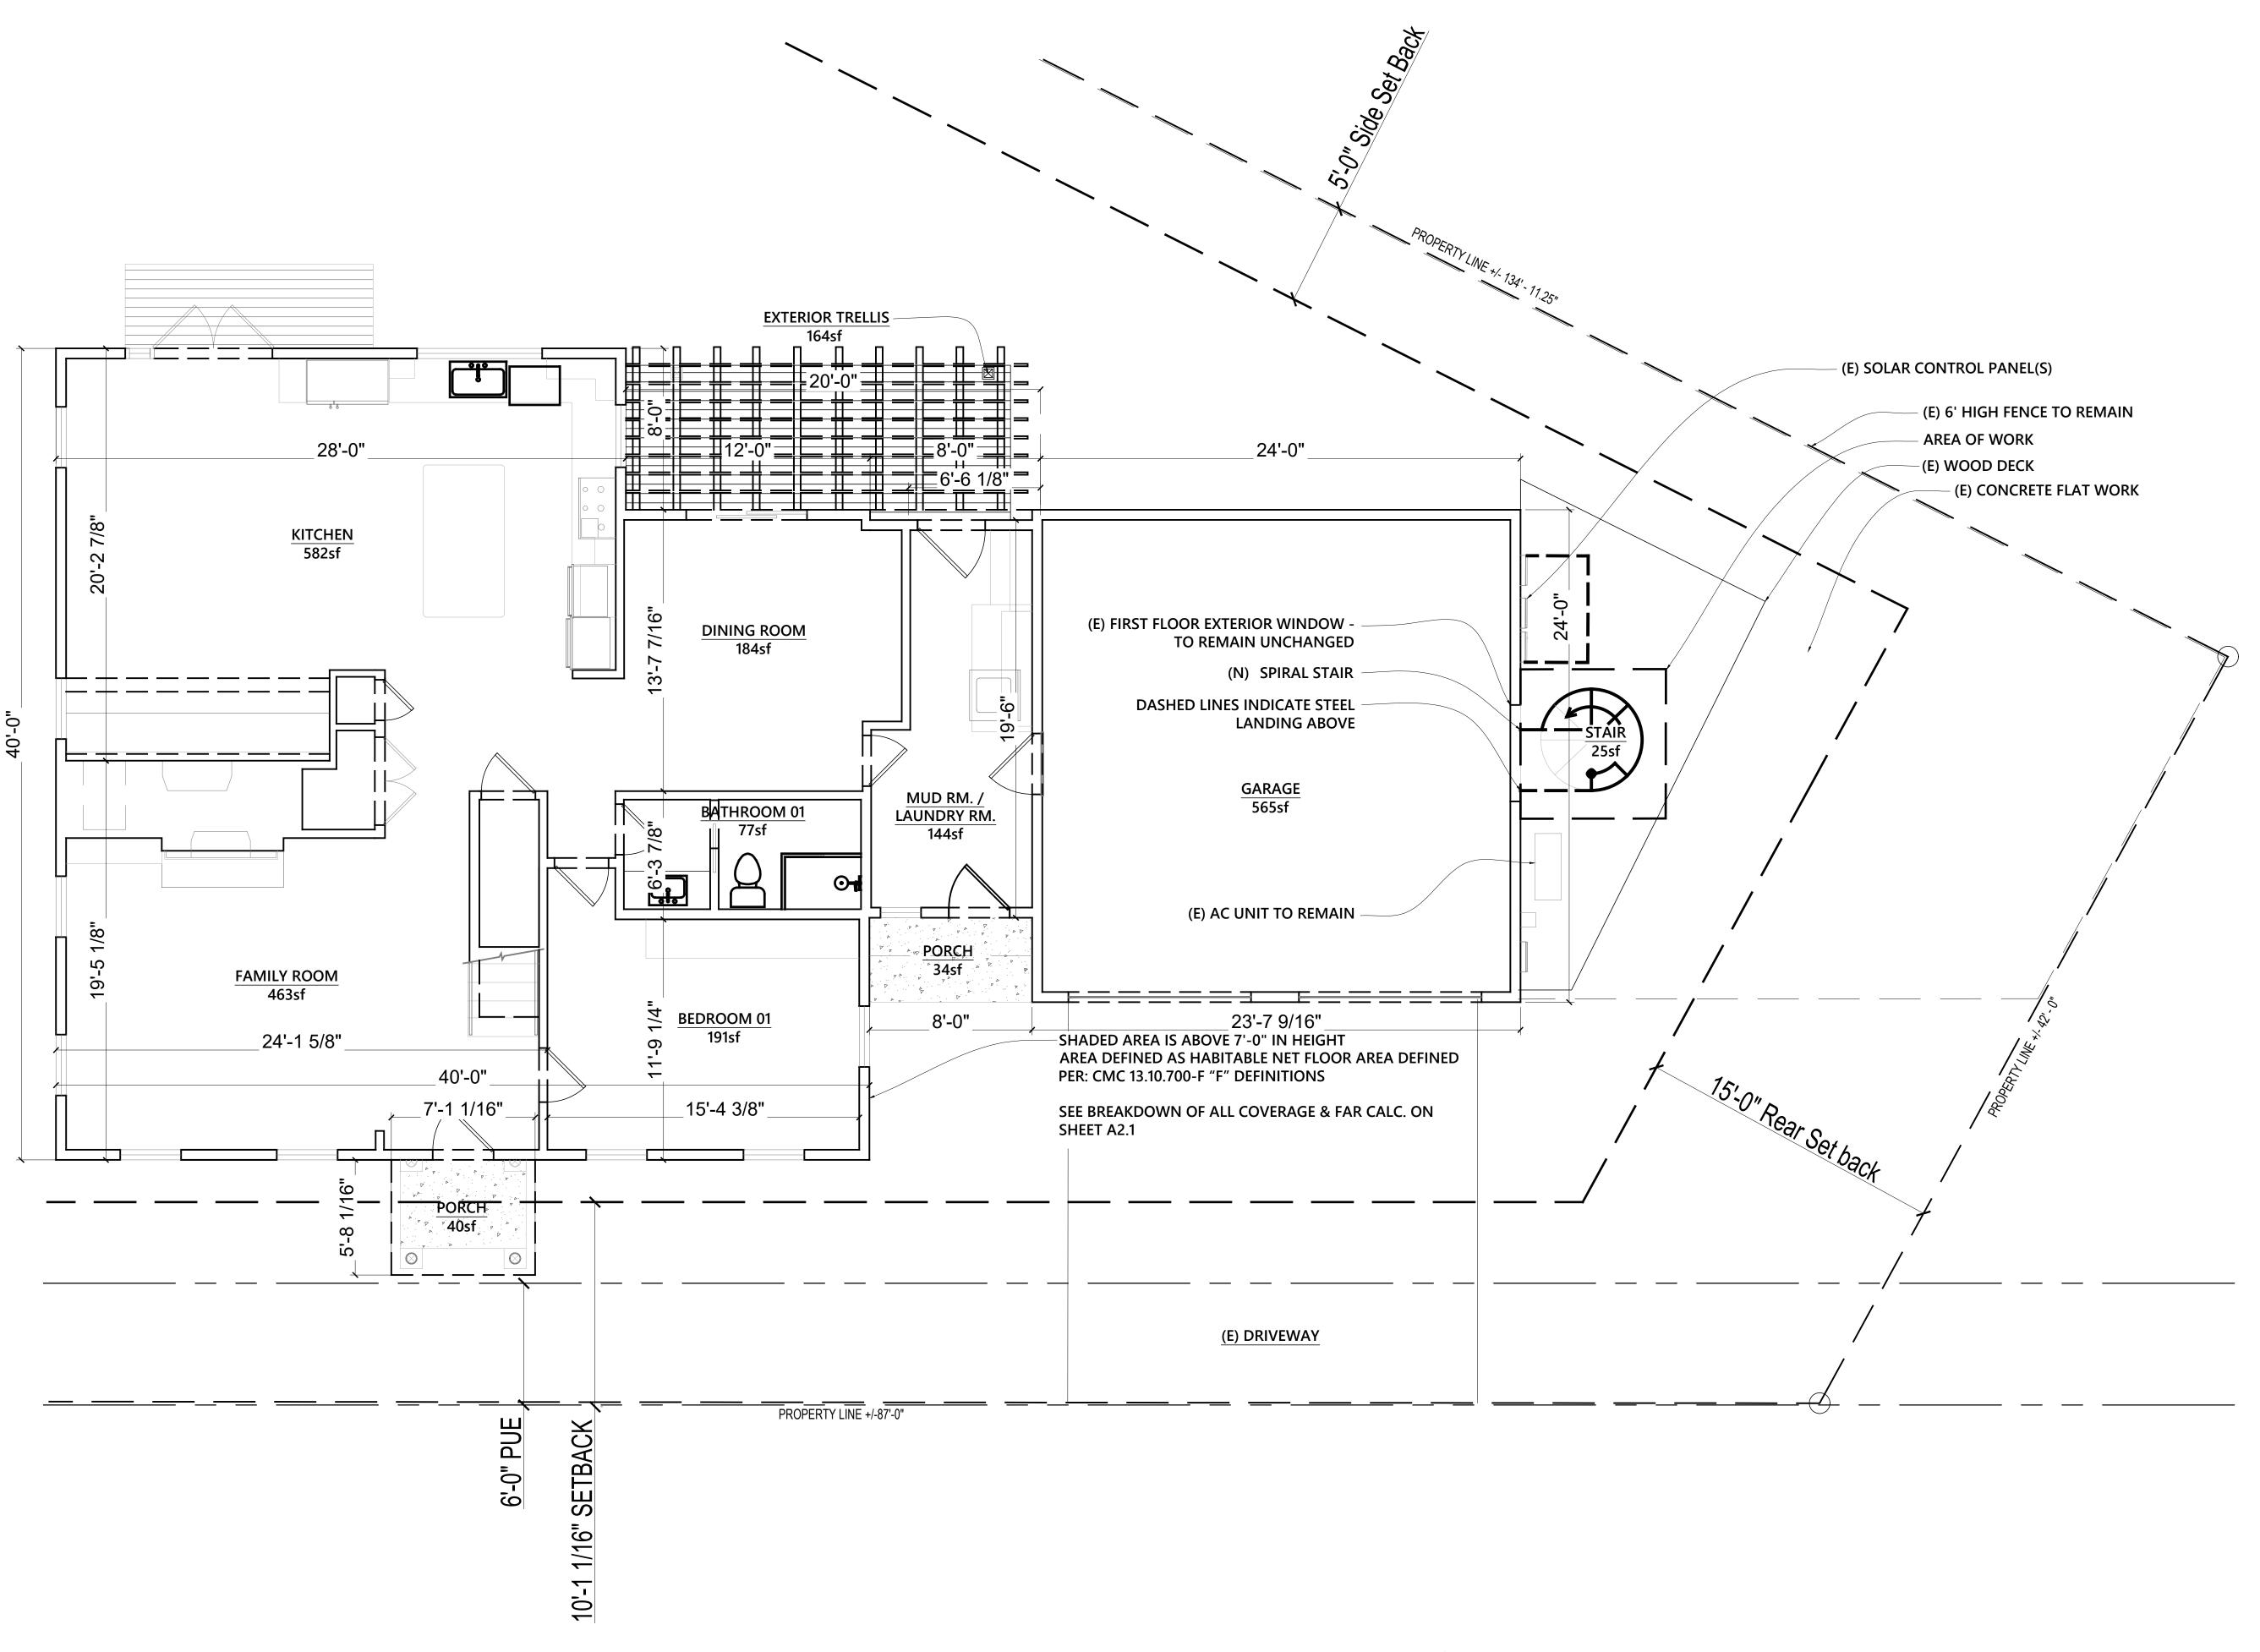

EXISTING / PROPOSED FLOOR PLANS

DOLPHIN RESIDENCE 2277 DOLPHIN DRIVE, APTOS CA 95003 APN: 054-601-38


OCTOBER 26, 2023 BLDG. 5.20.24 BLDG. 7.22.24 RESUB 12.17.24 PLN RESUB 2.17.25

01

DOLPHIN RESIDENCE

DANIEL J. GOMEZ
C-29000
04.30.25
Renewal Date



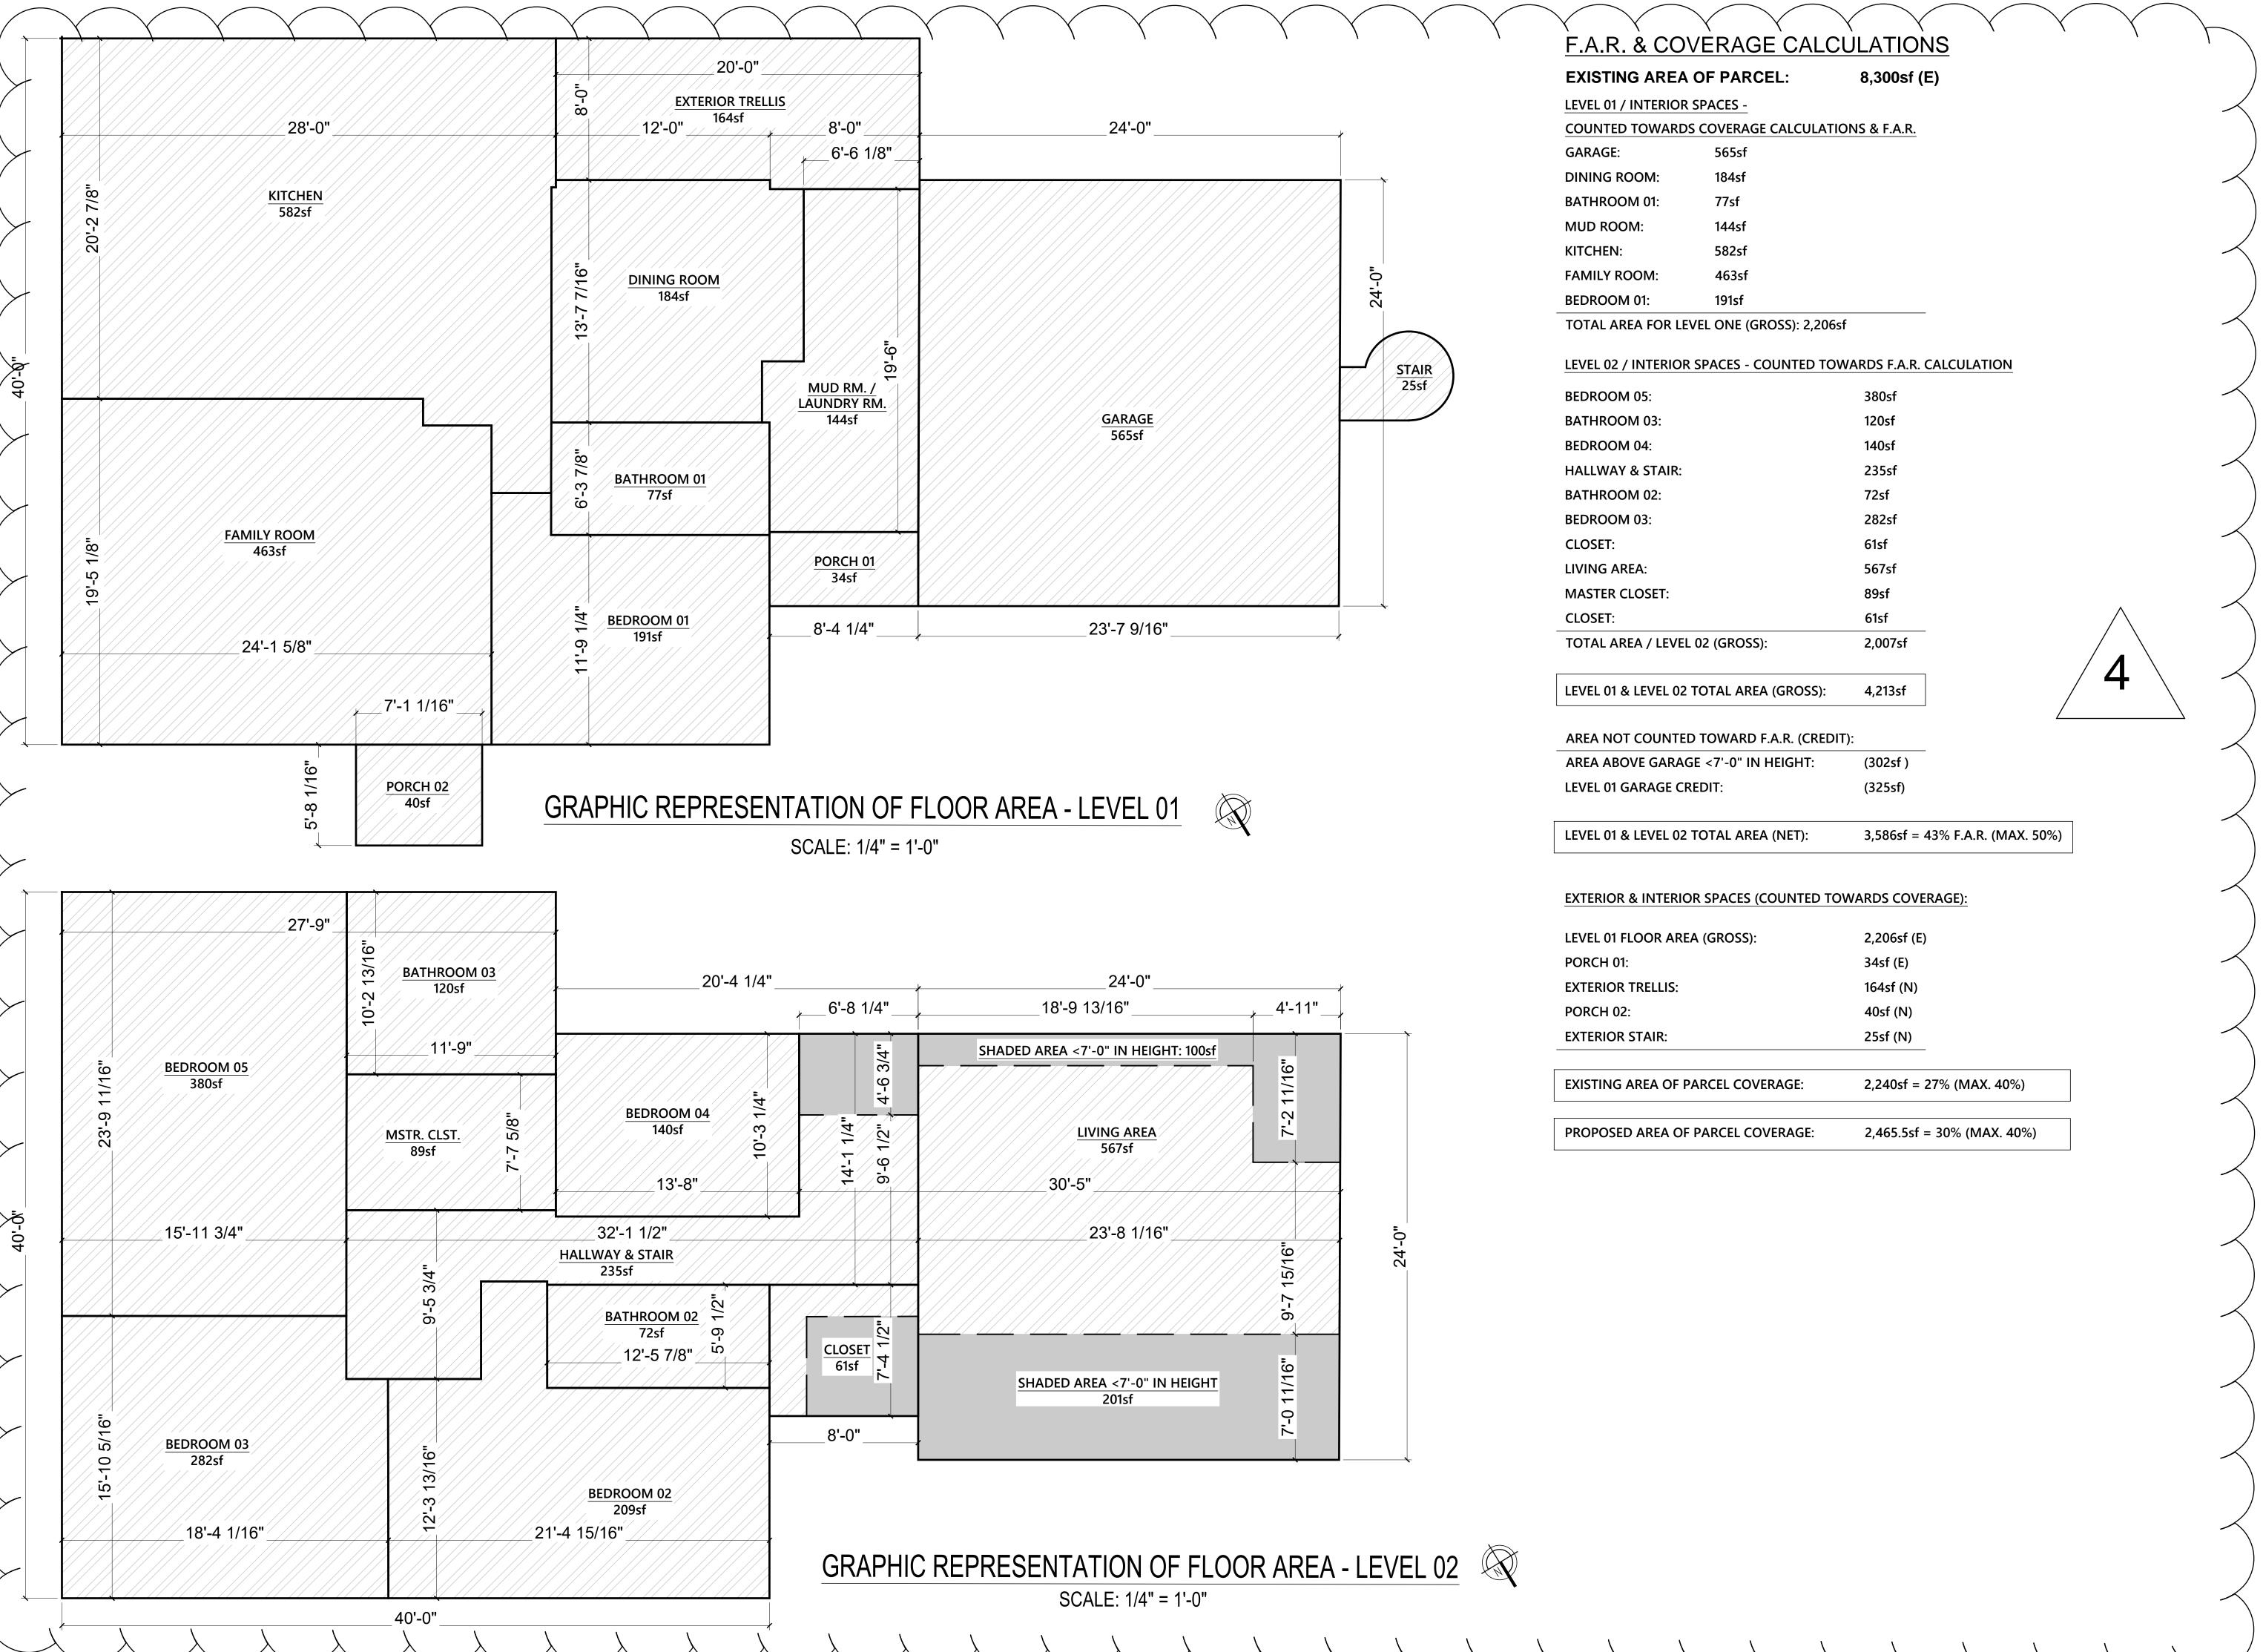

DOLPHIN RESIDENCE


DANIEL J. GOMEZ C-29000 04.30.25 Renewal Date


architects inc.

DOLPHIN RESIDENCE 2277 DOLPHIN DRIVE, APTOS CA 95003 APN: 054-601-38


OCTOBER 26, 2023 BLDG. 5.20.24 BLDG. 7.22.24 RESUB 12.17.24 PLN RESUB 2.17.25

FIRST & SECOND FLOOR PLANS & F.A.R. COVERAGE CALCULATIONS

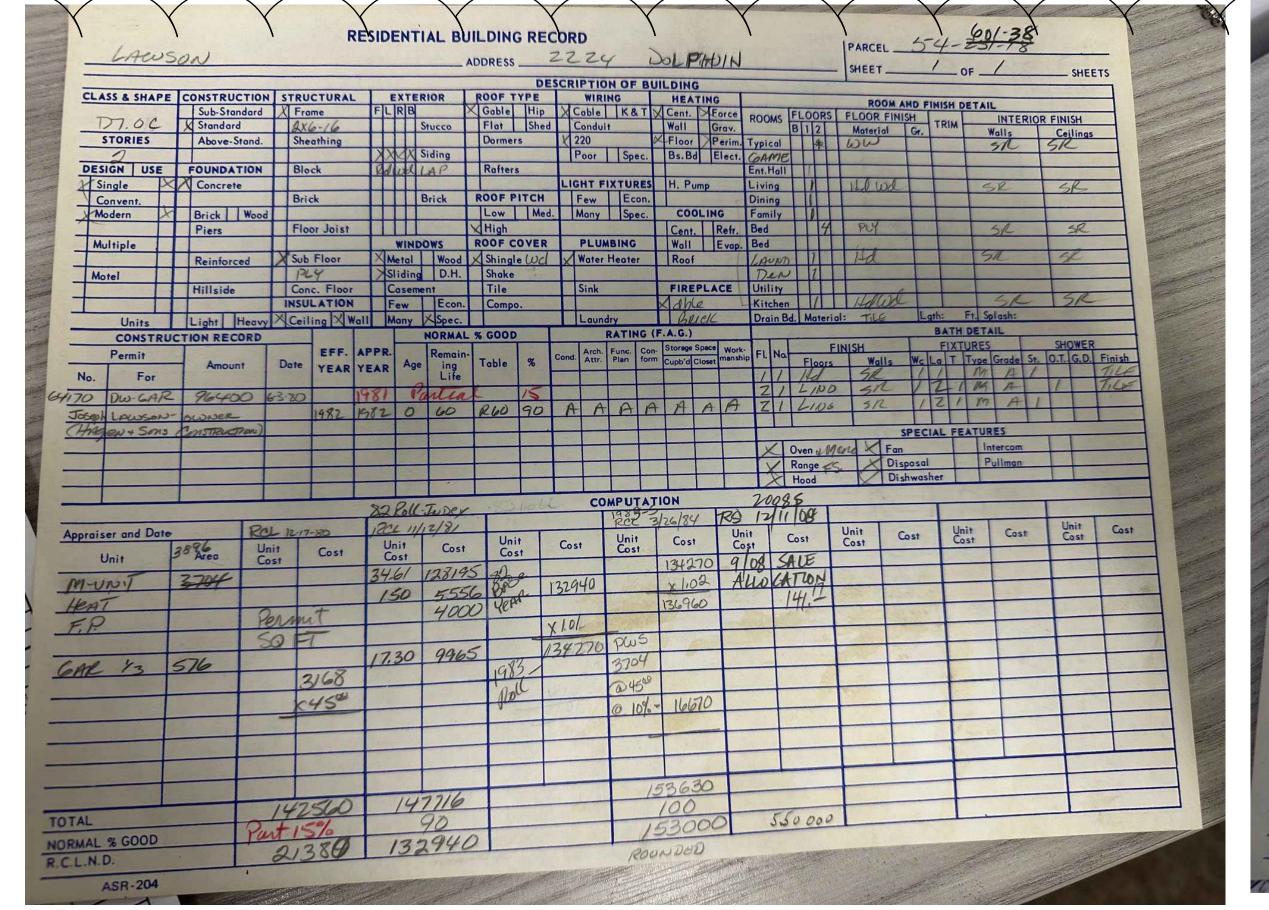

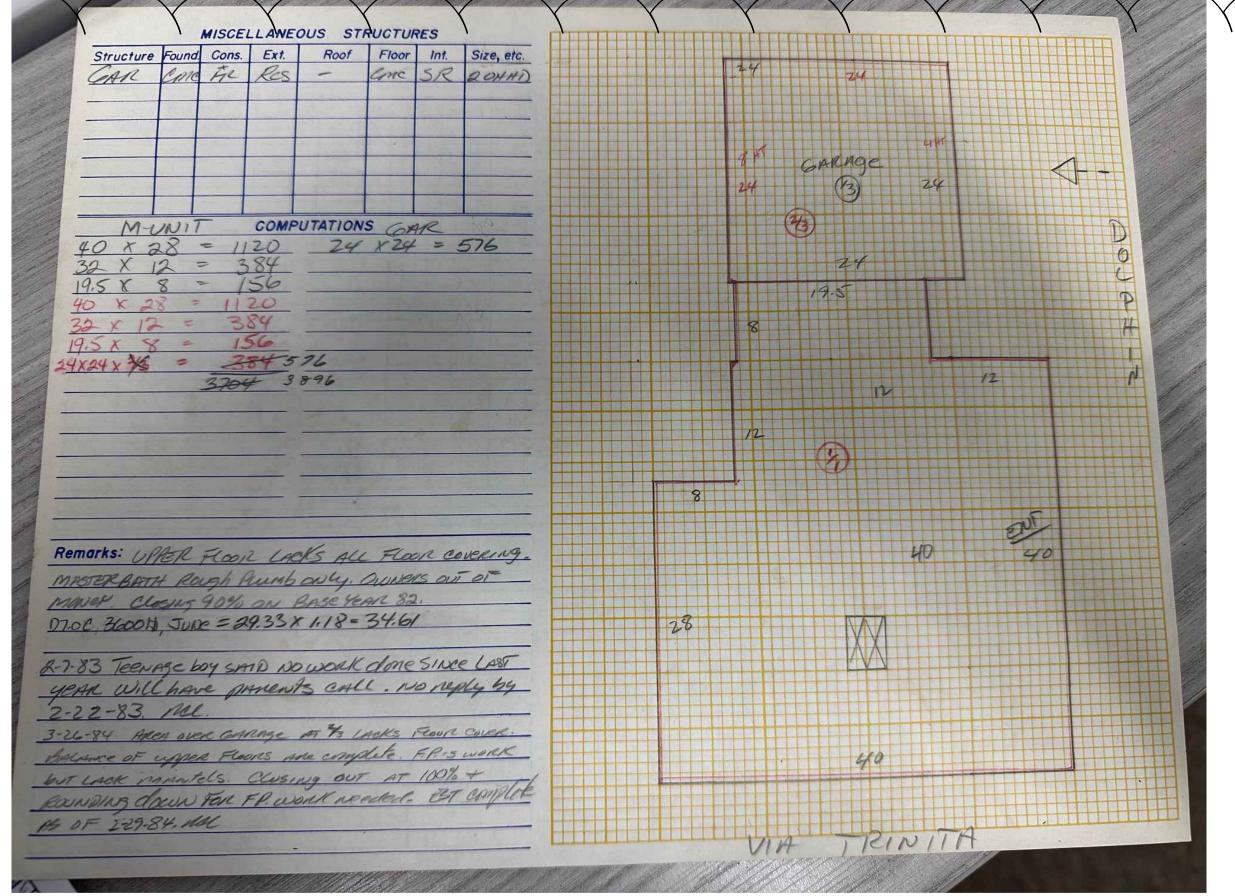

BUILDING DEPARTMENT RECORD ARCHIVE

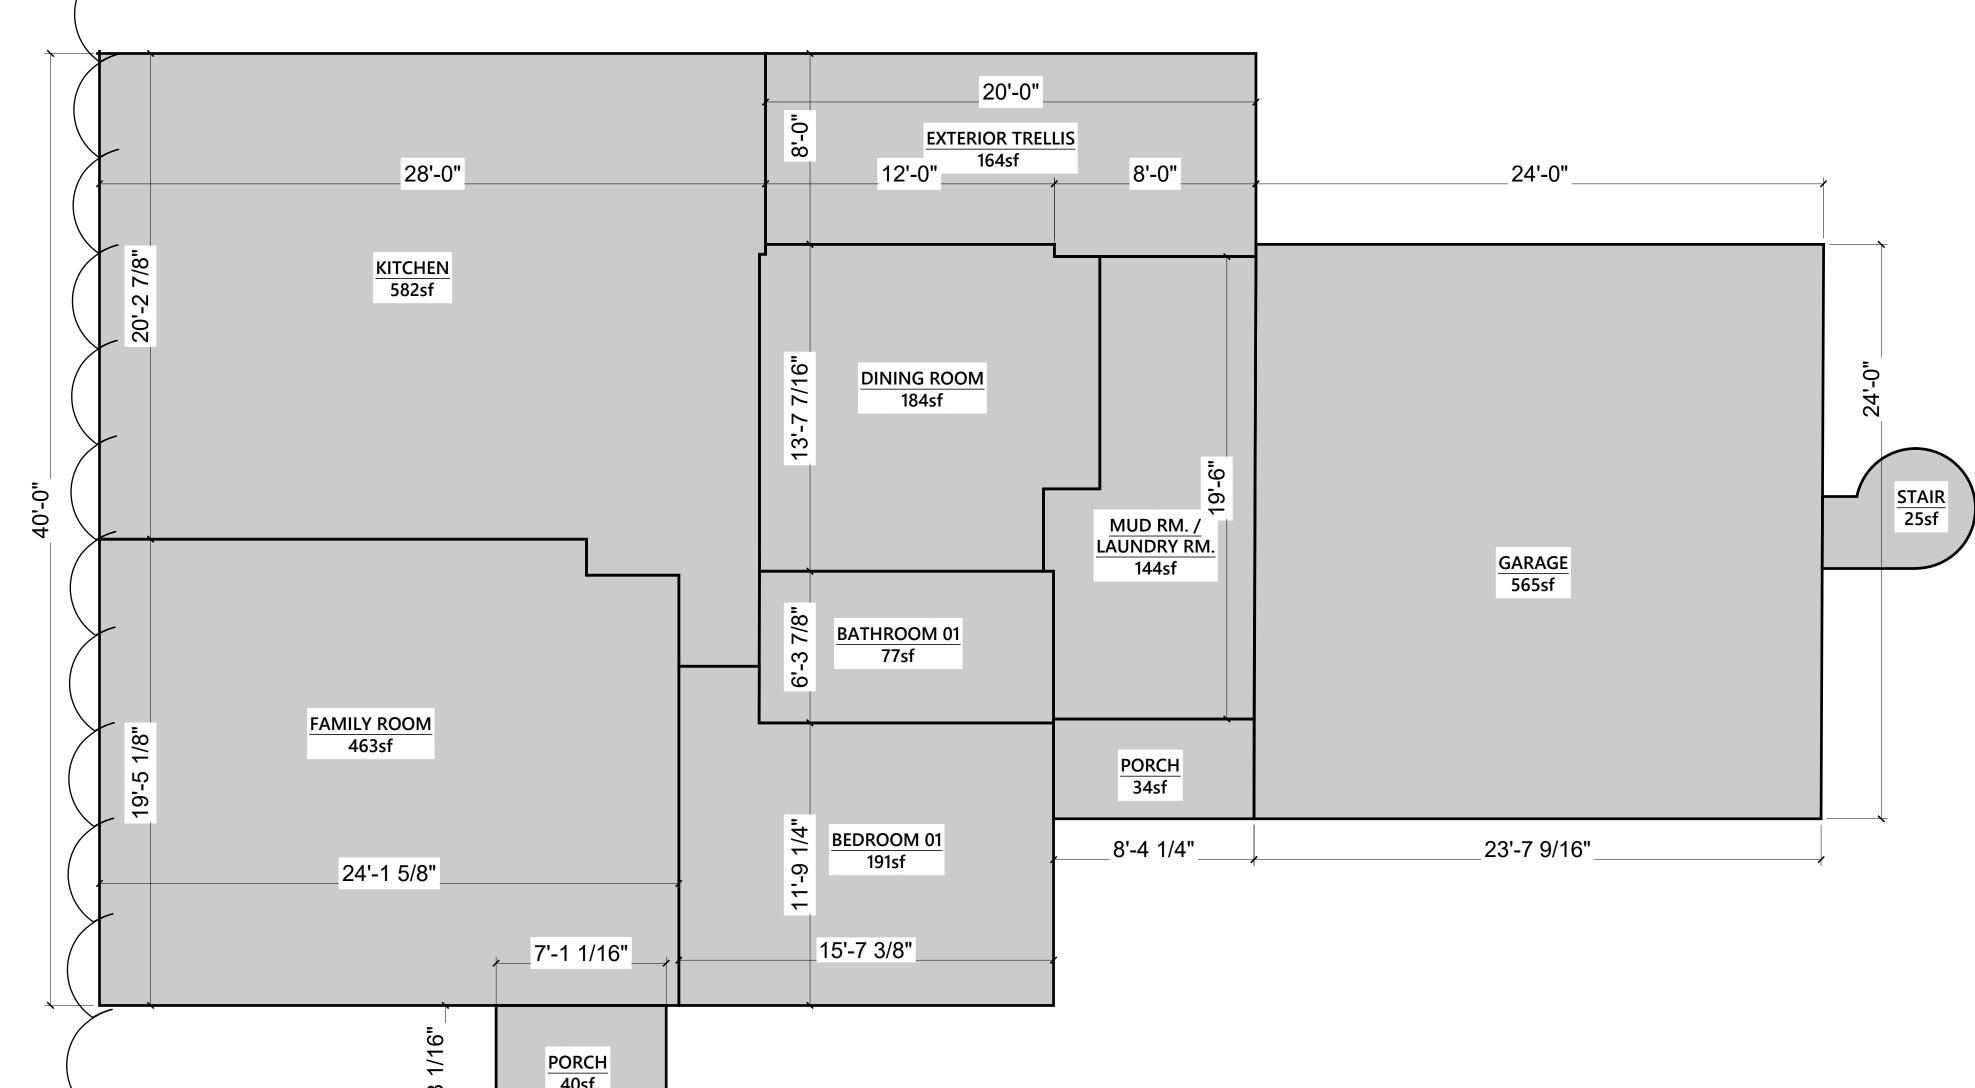

OVERALL FOOTPRINT FOR COMPARISON TO RECORDS

PER BUILDING DEPT. ARCHIVE: 11/12/1981



PER GOOGLE MAPS / CIRCA: 2007



PER GOOGLE MAPS / CIRCA: 2024



PER GOOGLE MAPS / CIRCA: 2024

PER GOOGLE MAPS / CIRCA: 2007



TIMELINE OF AVAILABLE PHOTOS - YEARS REFERENCED 1981 THROUGH 2024

DOLPHIN RESIDENCE DANIEL J. GOMEZ C-29000 04.30.25 Renewal Date

architects inc.

DOLPHIN RESIDENCE 2277 DOLPHIN DRIVE, APTOS CA 95003 APN: 054-601-38

A2.3



PROPOSED FRONT ELEVATION @ GARAGE & SIDE YARD FENCE

SCALE = 1/4" = 1'-0"

PROPOSED SIDE ELEVATION @ (N) SPIRAL STAIR & (N) SECOND FLOOR EXTERIOR DOOR

SCALE = 1/4" = 1'-0"



PROPOSED REAR ELEVATION @ GARAGE & SIDE YARD

SCALE = 1/4" = 1'-0"

PROPOSED SIDE ELEVATION @ UNCHANGED SIDE ELEVATION

SCALE = 1/4" = 1'-0"

DOLPHIN RESIDENCE

DANIEL J. GOMEZ
C-29000
04.30.25
Renewal Date

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512 capitola avenue capitola + california 831.479.9295 (V) 831.479.9325 (F) www.fusearchitecture.com use@fusearchitecture.com

> **use architects inc.** aniel gomez / architect

DOLPHIN RESIDENCE
2277 DOLPHIN DRIVE, APTOS CA 95003
APN: 054-601-38

OCTOBER 26, 2023
BLDG. 5.20.24
BLDG. 7.22.24
RESUB 12.17.24
PLN RESUB 12.17.24
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KISTING / PROPOSED KTERIOR ELEVATIONS


A3.0

fuse architects inc.
daniel gomez / architect
daniel townsend / architect




BUILDING SECTION 01


SCALE: 1/8" = 1'-0"

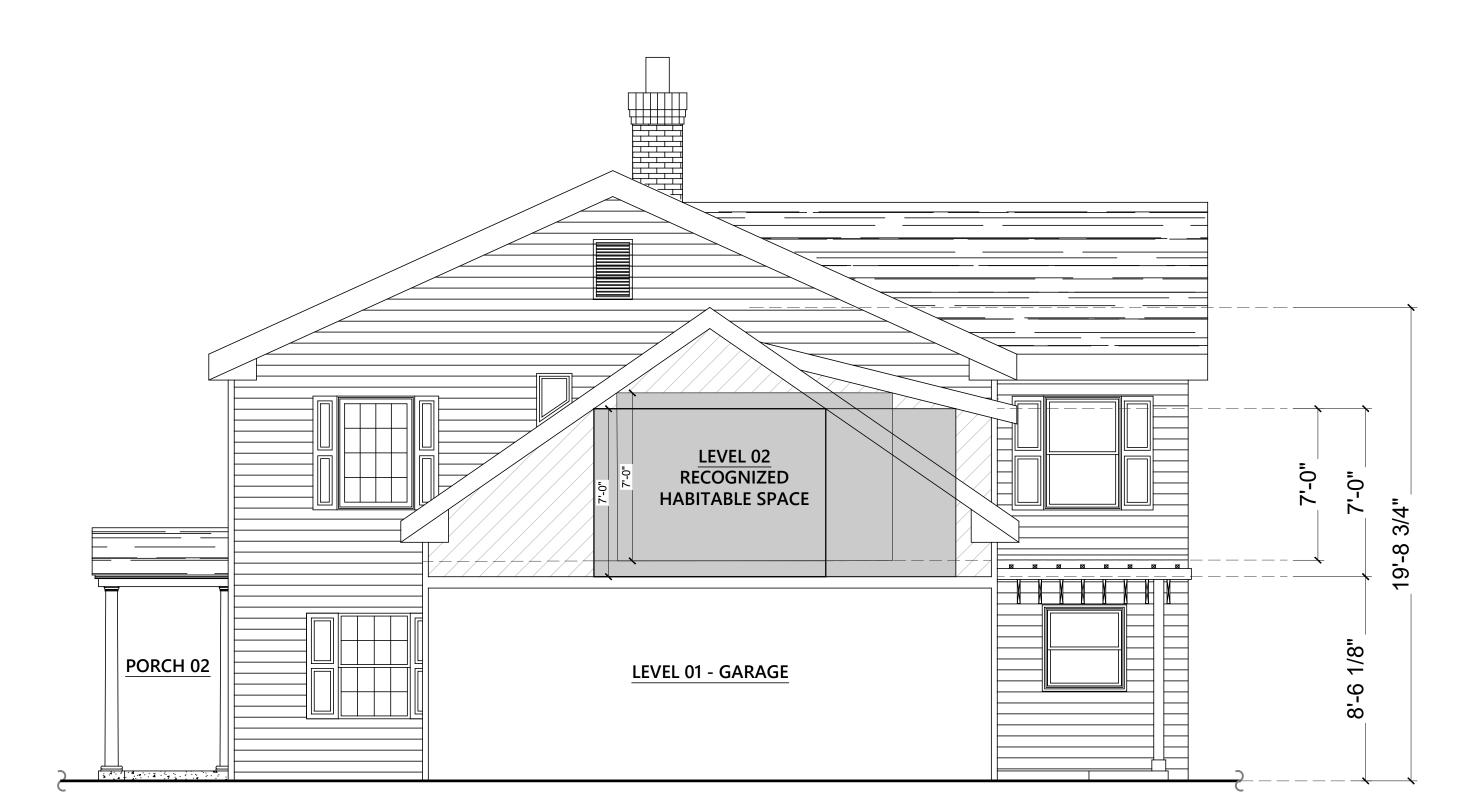


BUILDING SECTION 02

SCALE: 1/8" = 1'-0"

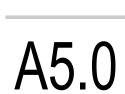

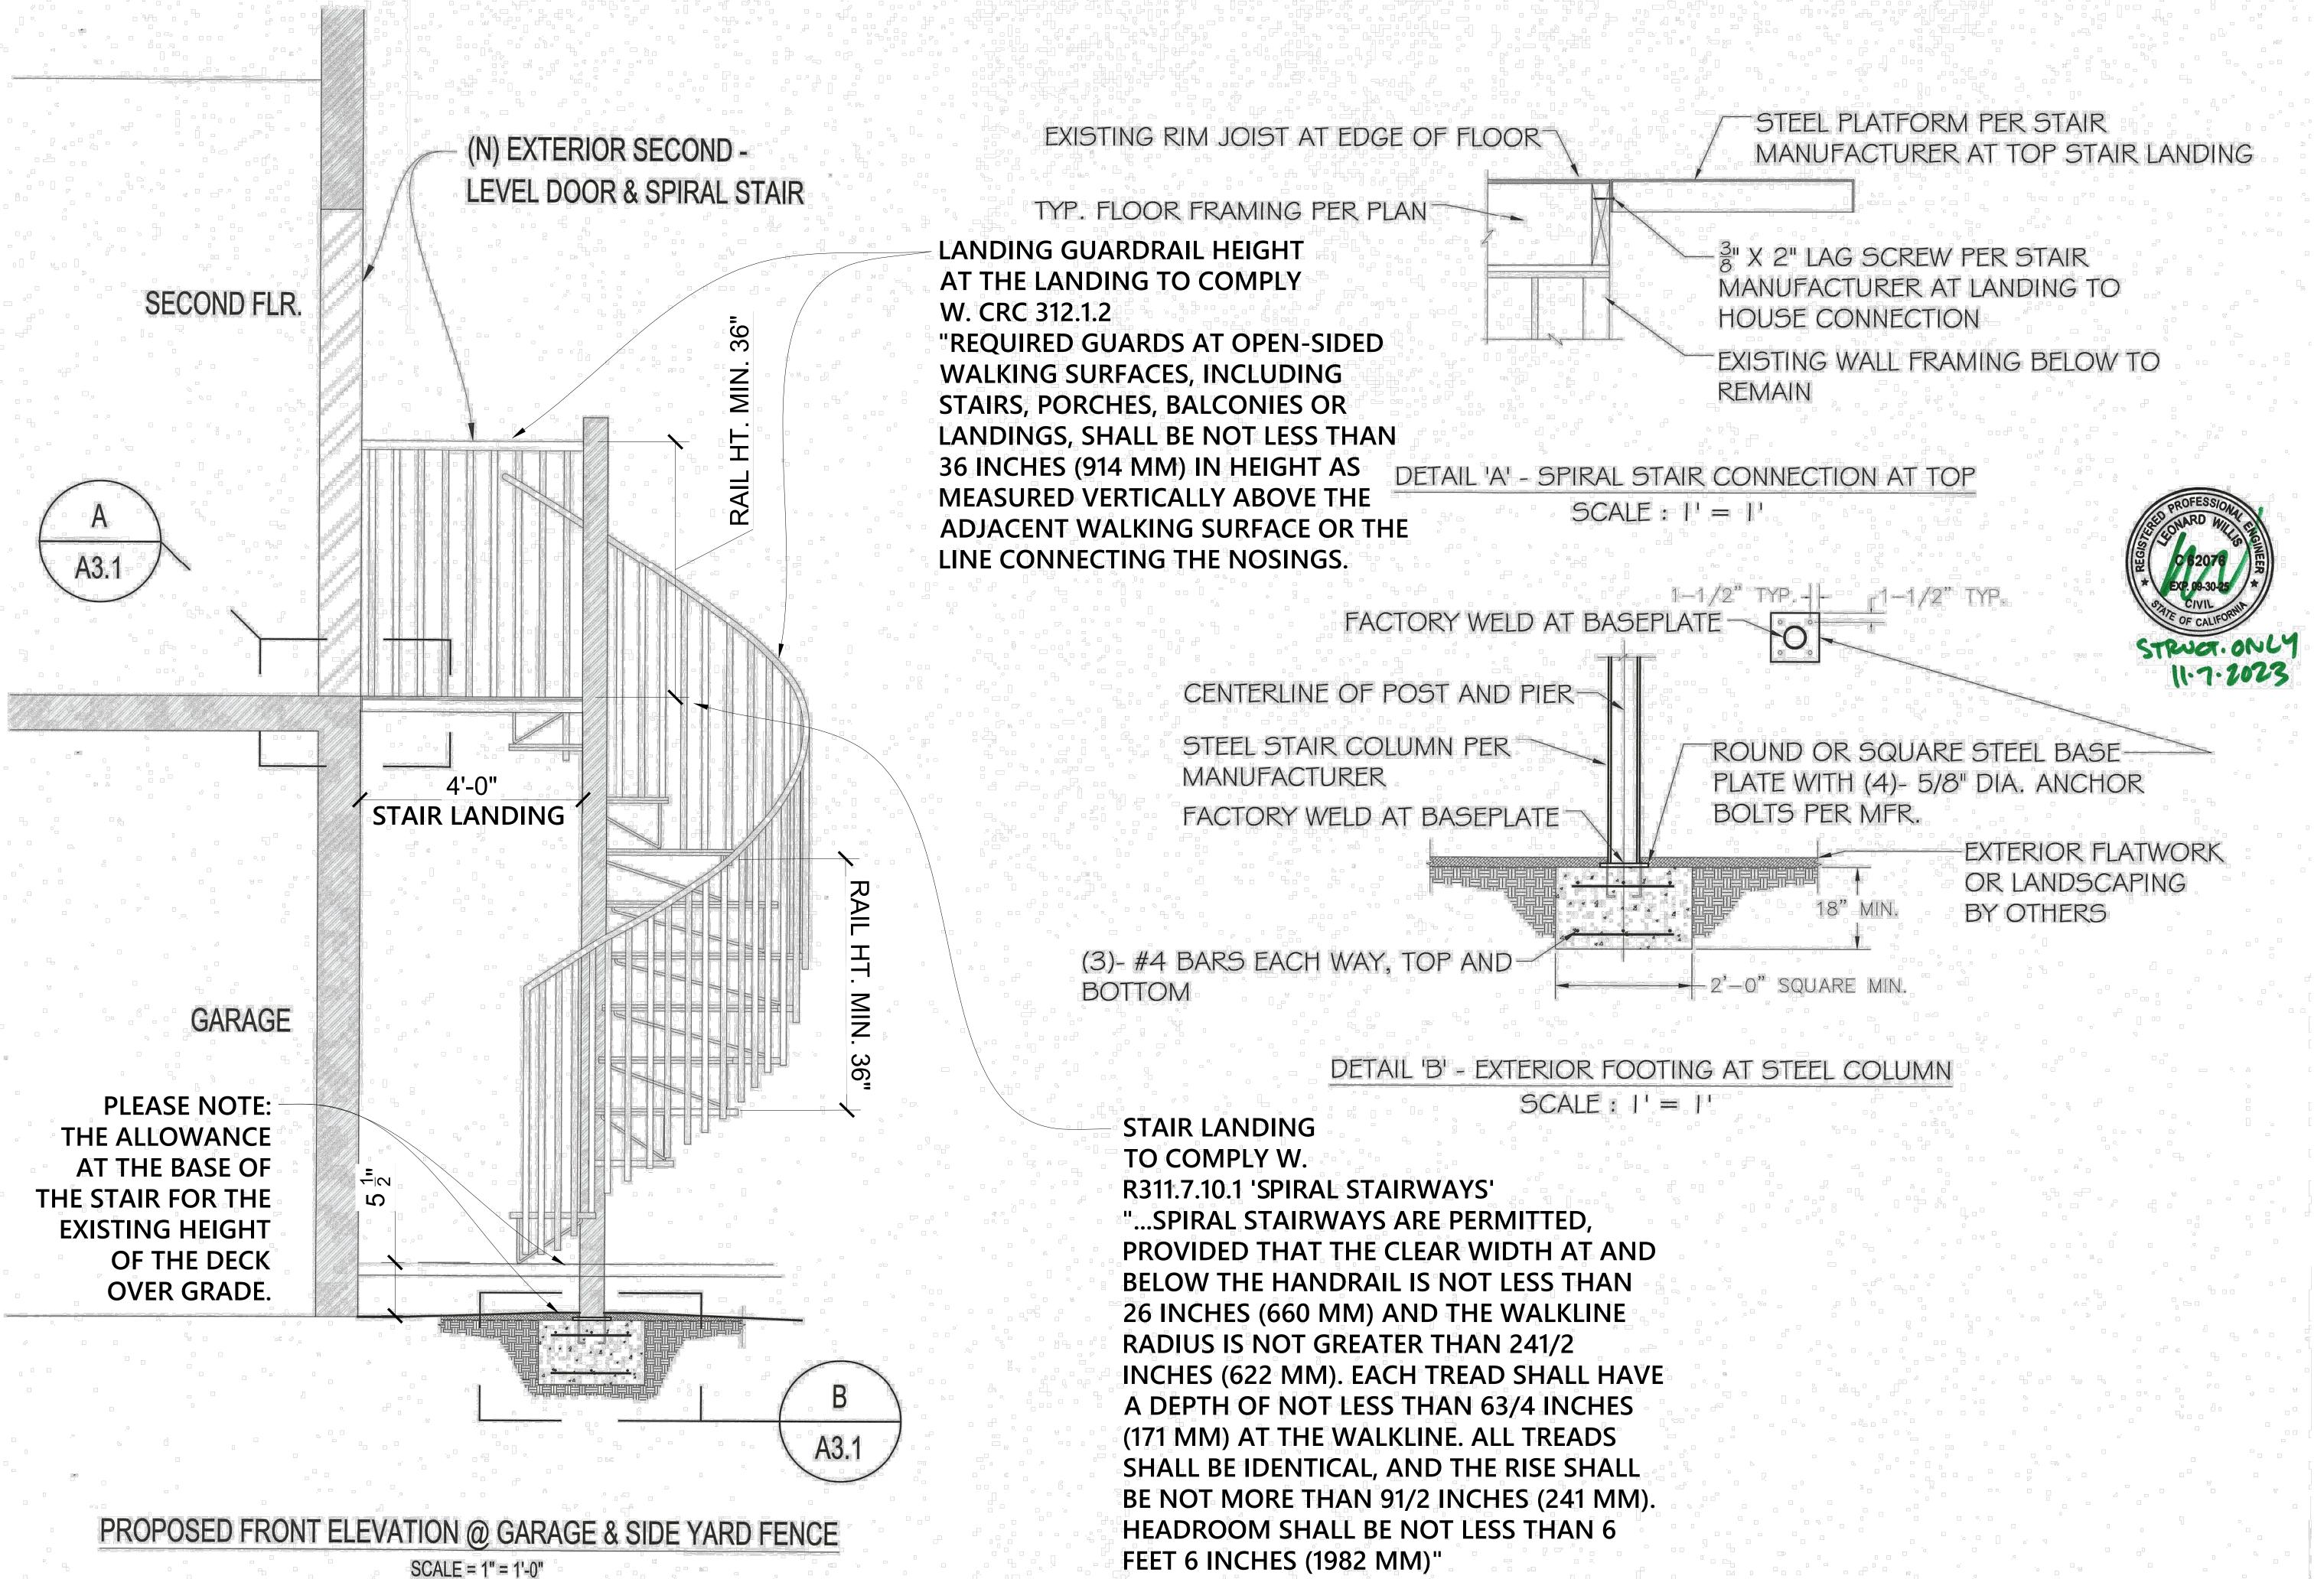

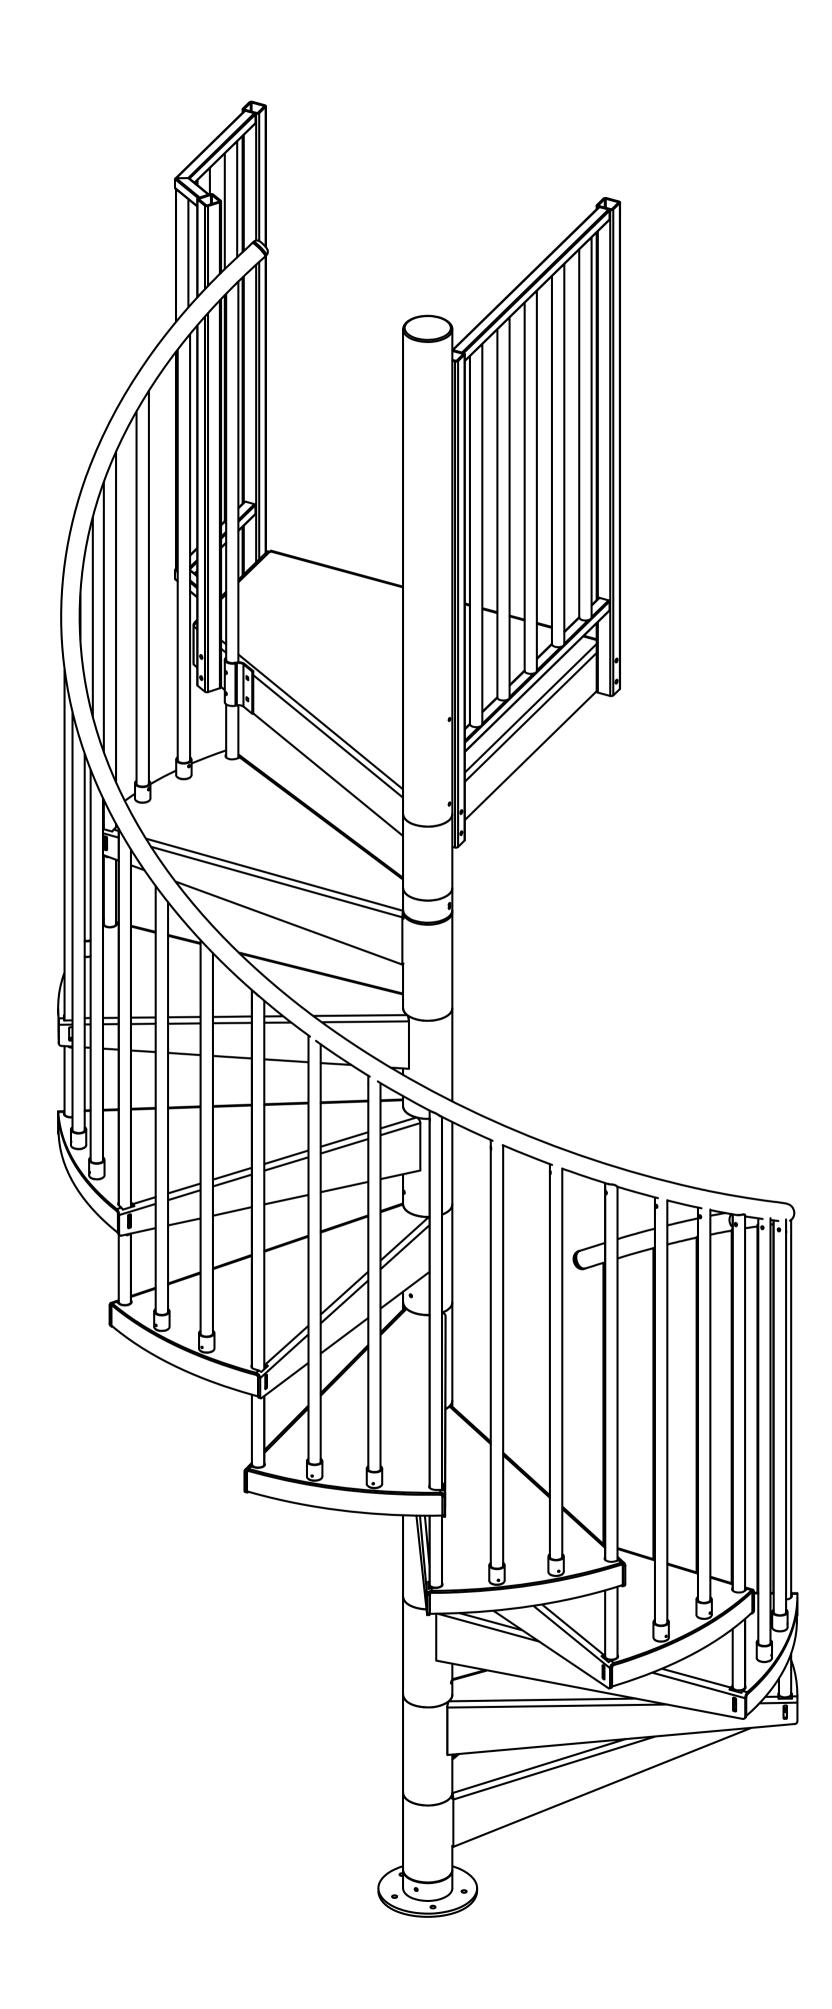

DRAWING INDEX

A-01: INDEX

A-02: PLAN VIEW AND ELEVATION VIEW

A-03: COLUMN, PLATFORM AND BASEPLATE

A-04: TREAD PROFILES, HANDRAIL, MISC.

GENERAL REQUIREMENTS

- 1. STRUCTURAL DRAWINGS SHALL BE USED IN CONJUNCTION WITH THE SPECIFICATIONS AND OTHER PROJECT DRAWINGS BY OTHER DISCIPLINES. ALL WORK SHALL CONFORM TO THE REQUIREMENTS OF THE CODES LISTED BELOW.
- 2. CONTRACTOR SHALL VERIFY ALL DIMENSIONS AND ELEVATIONS RELATING TO EXISTING CONDITIONS BY MAKING FIELD SURVEYS AND MEASUREMENTS PRIOR TO COMMENCING FABRICATION OR CONSTRUCTION.
- 3. THE GENERAL CONTRACTOR SHALL COMPARE AND COORDINATE THE DRAWINGS OF ALL DISCIPLINES AND REPORT ANY DISCREPANCIES BETWEEN THE DRAWINGS TO THE ARCHITECT AND ENGINEER.
- 4. DETAILS LABELED "TYPICAL" SHALL APPLY TO ALL SITUATIONS THAT ARE THE SAME OR SIMILAR TO THOSE SPECIFICALLY DETAILED. SEE DETAIL TITLES FOR APPLICABILITY OF A PARTICULAR DETAIL. TYPICAL DETAILS SHALL APPLY WHETHER OR NOT THEY ARE SPECIFICALLY KEYED AT EACH LOCATION.
- 5. THE ENGINEER SHALL HAVE FINAL AUTHORITY TO DETERMINE APPLICABILITY OF TYPICAL DETAILS.
- 6. WHERE CONFLICTS EXIST BETWEEN STRUCTURAL DOCUMENTS THE STRICTEST REQUIREMENTS,

AS INDICATED BY THE STRUCTURAL ENGINEER SHALL GOVERN.

- 7. THE GENERAL CONTRACTOR SHALL REVIEW AND DETERMINE THAT DIMENSIONS ARE COORDINATED BETWEEN ARCHITECTURAL AND STRUCTURAL DRAWINGS PRIOR TO FABRICATION OR START OF CONSTRUCTION.
- 8. NO STRUCTURAL MEMBER SHALL BE CUT OR NOTCHED OR OTHERWISE REDUCED IN STRENGTH UNLESS APPROVED BY THE STRUCTURAL ENGINEER.
- THE GENERAL CONTRACTOR SHALL COORDINATE ARCHITECTURAL, AND MECHANICAL, DRAWINGS FOR ANCHORED, EMBEDDED OR SUPPORTED ITEMS. NOTIFY THE

ARCHITECT / ENGINEER OF ANY DISCREPANCIES. PRIMARY BUILDING CODES AND SPECIFICATIONS:

1. GENERAL BUILDING CODE:

A. INTERNATIONAL RESIDENTIAL CODE, 2015, 2018, 2021

B. INTERNATIONAL BUILDING CODE, 2015, 2018, 2021

C. CBC 2020, 2022

D. FBC 2020, 2022 DESIGN LOADS:

1. PER IRC, 2015, 2018, 2021:

A. LIVE LOADS uniform (psf): 40

B. LIVE LOADS concentrated (lb): 300

C. LIVE LOADS handrail (plf): 50
D. LIVE LOADS handrail concentrated (lb): 200

2. PER IBC, 2015, 2018, 2021:

A. LIVE LOADS uniform (psf): 100

B. LIVE LOADS concentrated (lb): 300

C. LIVE LOADS handrail (plf): 50
D. LIVE LOADS handrail concentrated (lb): 200

3. CBC 2020, 2022

4. FBC 2020, 2022 ALUMINUM MATERIAL:

1. SEE NOTES ON PRIMARY CODES AND SPECIFICATIONS.

2. MATERIALS:

ANCHOR RODS......ASTM F1554, GRADE 55
WELDED HEADED STLIDS ASTM A 108

WELDED HEADED STUDS...... ASTM A108
DEFORMED BAR ANCHORS..... ASTM A496

MECHANICAL ANCHORS INTO CONCRETE:

1. USE THE FOLLOWING:

A. HILTI KWIK BOLT TZ CARBON AND STAINLESS STEEL ANCHORS - PER ESR-1719 (per application) FINISH:

1.POWDER COAT......PER SPECIFICATION ERECTION:

1. ENGINEER SHALL BE CONTACTED FOR APPROVAL OF ANY FIELD MODIFICATIONS OF ANCHOR BOLTS OR RODS AND COLUMN BASE PLATES (PER OSHA).

2. TEMPORARY BRACING OF STRUCTURAL STEEL ELEMENTS IS THE RESPONSIBILITY OF THE CONTRACTOR. STRUCTURAL STABILITY SHALL BE MAINTAINED AT ALL TIMES DURING THE ERECTION PROCESS.

3. CONTRACTOR MUST PROVIDE NOTIFICATION TO THE ERECTOR THAT, BY TESTING, THE FOUNDATION AND SUPPORTING WALLS HAVE ATTAINED SUFFICIENT STRENGTH TO SUPPORT THE STEEL TO BE ERECTED BEFORE ERECTING STRUCTURAL STEEL.

INSTALLATION RESPONSIBILITY:


1. THE CONTRACT STRUCTURAL DRAWINGS AND SPECIFICATIONS REPRESENT THE COMPLETED STRUCTURE AND ARE NOT INTENDED TO INDICATE THE METHOD OR MEANS OF

STRUCTURE, AND ARE NOT INTENDED TO INDICATE THE METHOD OR MEANS OF CONSTRUCTION. THE CONTRACTOR SHALL SUPERVISE AND DIRECT THE WORK AND SHALL BE SOLELY RESPONSIBLE FOR ALL CONSTRUCTION MEANS, METHODS, PROCEDURES, TECHNIQUES, SEQUENCES, AND FOR JOB SAFETY.

2. THE ENGINEER DOES NOT HAVE CONTROL OR CHARGE OF, AND SHALL NOT BE RESPONSIBLE FOR, CONSTRUCTION MEANS, METHODS, TECHNIQUES, SEQUENCES, OR PROCEDURES, FOR SAFETY PRECAUTIONS AND PROGRAMS IN CONNECTION WITH THE WORK, FOR THE ACTS OR OMISSIONS OF THE CONTRACTOR, SUBCONTRACTOR, OR ANY OTHER PERSONS PERFORMING ANY OF THE WORK, OR FOR THE FAILURE OF ANY OF THEM TO CARRY OUT THE WORK IN ACCORDANCE WITH THE CONTRACT DOCUMENTS.

ENGINEE	ENGINEER SEAL:					
PROJECT	T: STEVEN - SHO	OP	NAME: ALLEN, STEVEN			
DRAWIN ADDRESS	IGS		ALLEIN, SILVLIN			
	А	2277 DOI PTOS, CA 95	_PHIN DR 003-5857 USA			
OWNED BY SA IS NOT PERMITI ADDITIONAL C THIS RESTRICTIC THEFT OF CORI STATUTES. THIS MODIFICATION PROHIBITED. R	LTER SPIRAL STAIR ED. THE REPROD OPIES OR REVISIR ON SHALL BE COR PORATE ASSETS, E PLAN HAS BEEN S N, REVISION, DUP ELIANCE ON THIS ISCRETION AND L	R. REPRODUCTION OF TOUCTION OF A COPY OF A COP	A PROFESSIONAL SERVICE RENDERED BY AND IS HIS PLAN WITHOUT APPROVAL OF SALTER SPIRAL STAIR F THIS PLAN FOR THE PURPOSE OF CREATING NO CIRCUMSTANCE, BE APPROVED. VIOLATION OF OF BOTH THE PROFESSIONAL CODE OF ETHICS AND A BE PROSECUTED TO THE FULLEST EXTENT OF CURRENT D FOR THE PROJECT DESIGNATED HEREON, ANY OUT THE WRITTEN CONSENT OF SALTER SPIRAL STAIR IS SE OTHER THAN THAT WHICH IT IS INTENDED SHALL BE			
REV No.	DATE:	REVIS	IONS: DESCRIPTION:			
		ALUMI SPIRAL				
		Paragon 105 G.P. CLEN	MENT DRIVE			
DRAWN	DATE:	COLLEGEVILL 1-800-368				
	4/4/24		N.T.S.			
DRAWN BY: Y.V.			APPROVED BY: XX			
IOB No.			REV No.			
P-418822 ARCH:			1			
		A-(01			

LOCAL SEAL:

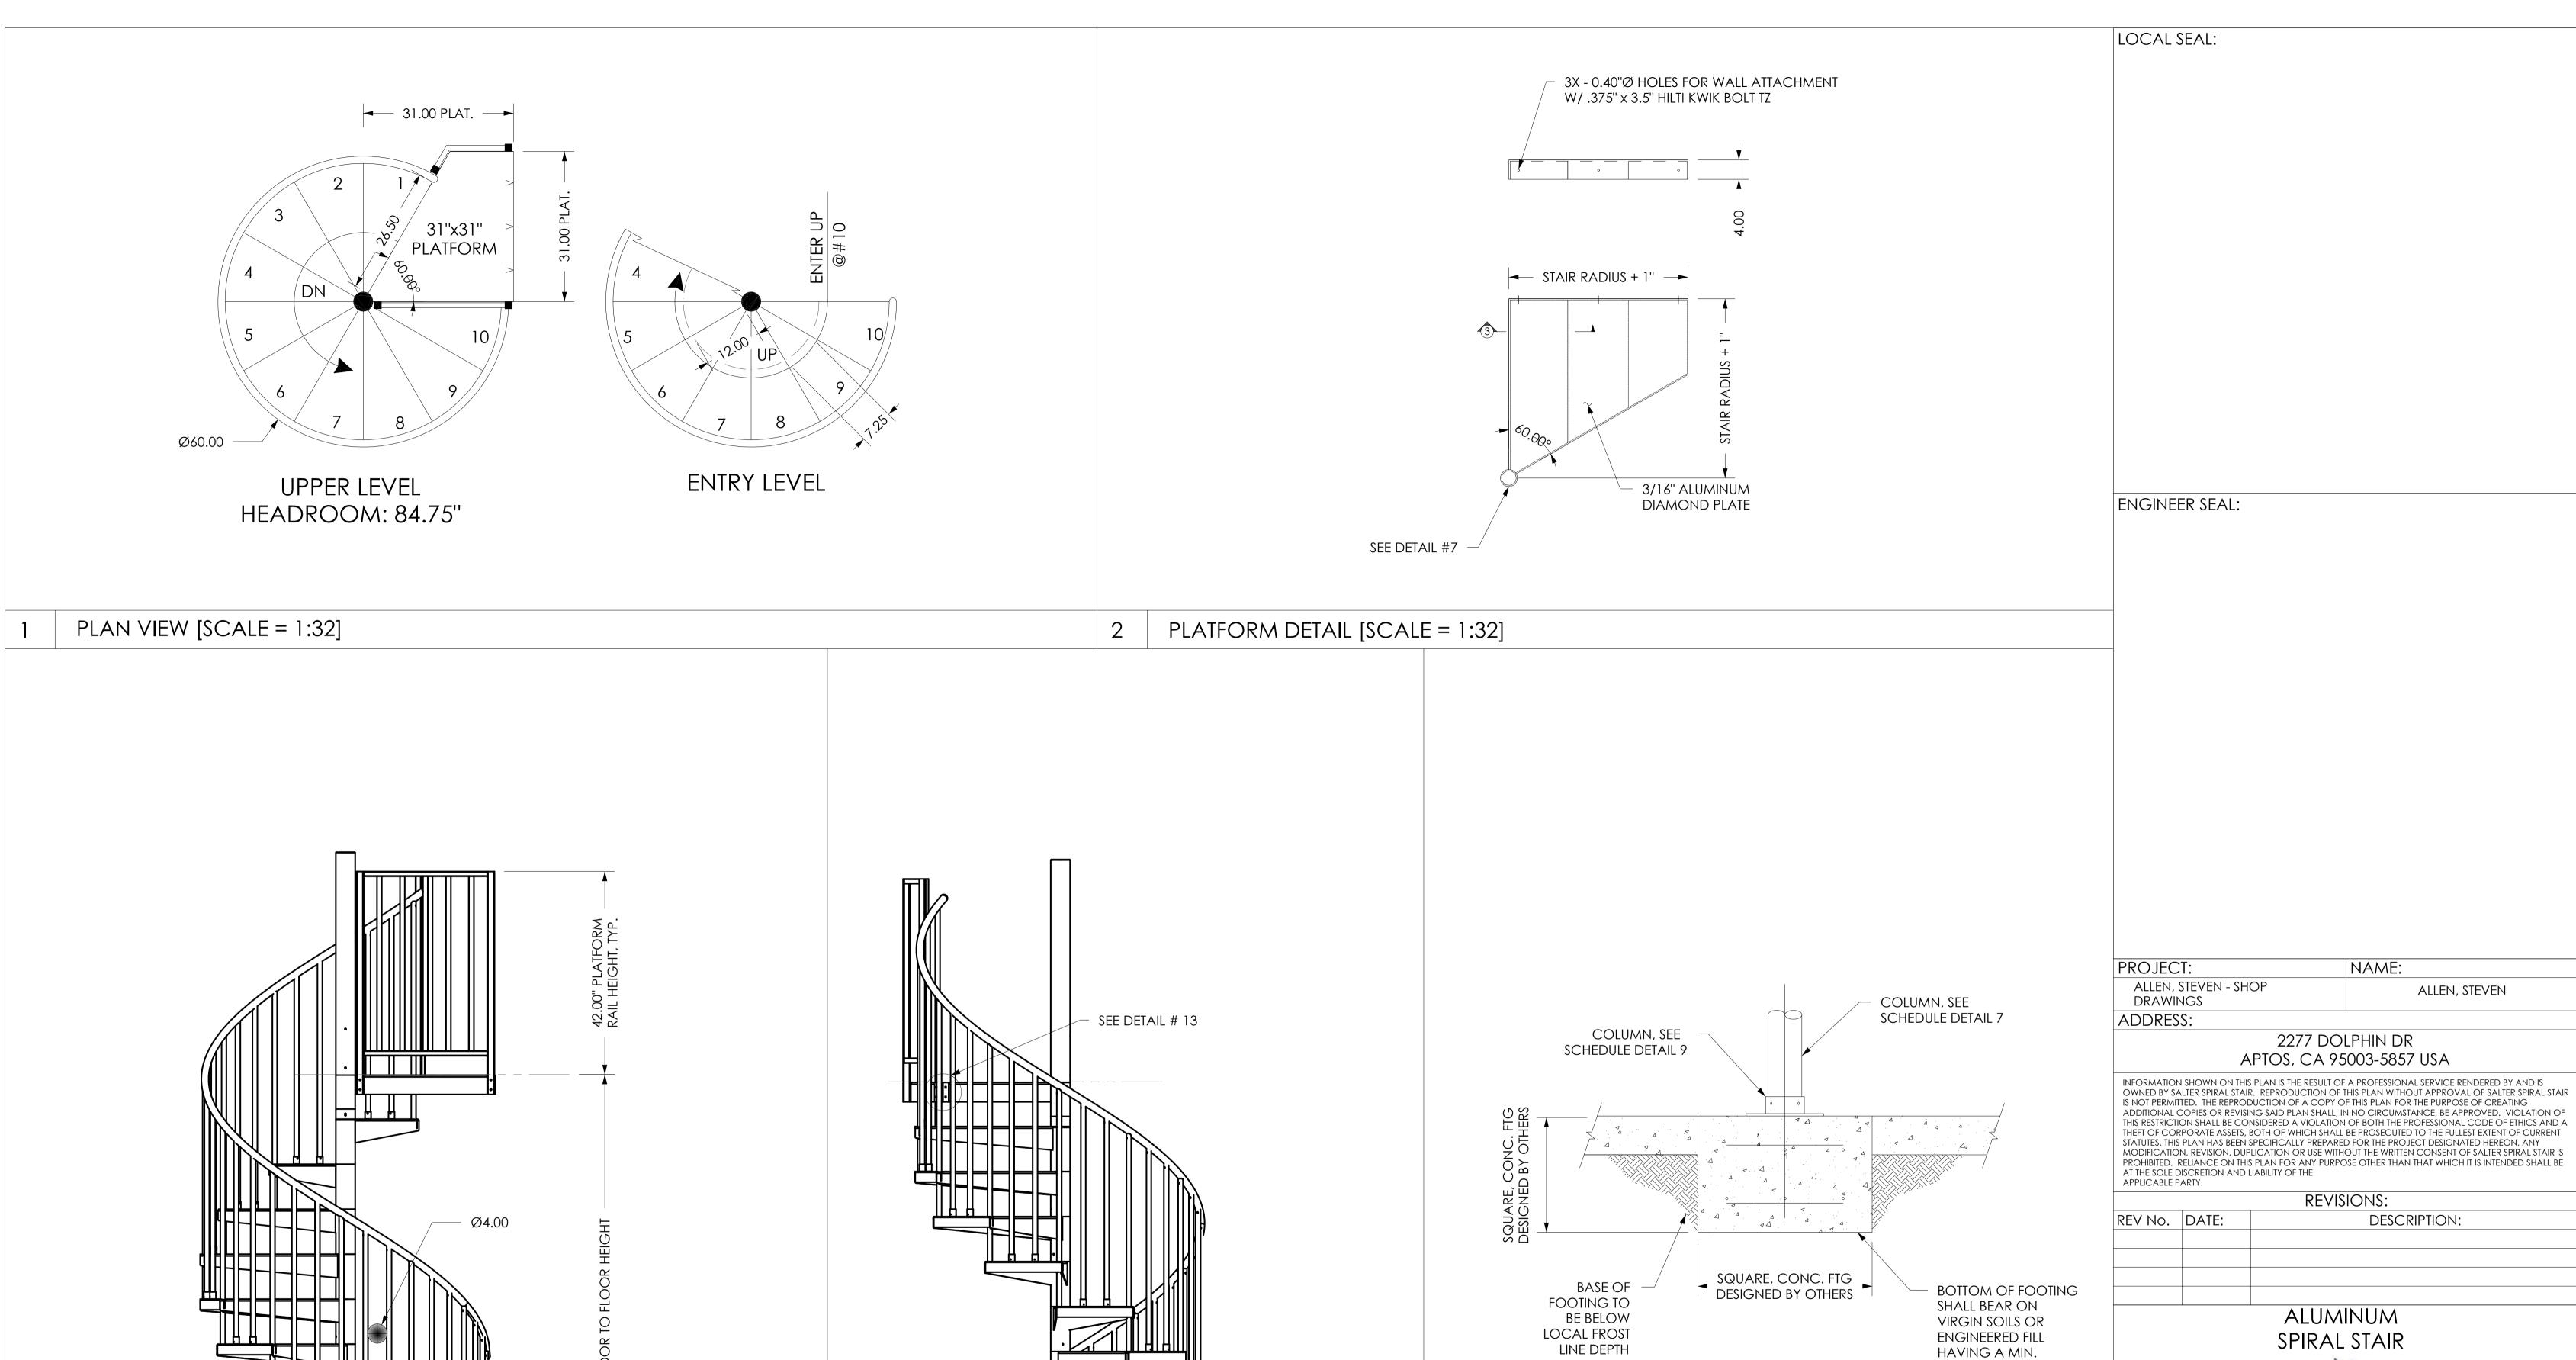

SEE DETAIL #9

RIGHT ELEVATION VIEW [SCALE = 1:32]


SEE DETAIL #12

FRONT ELEVATION VIEW [SCALE = 1:32]

THEFT OF CORPORATE ASSETS, BOTH OF WHICH SHALL BE PROSECUTED TO THE FULLEST EXTENT OF CURRENT STATUTES. THIS PLAN HAS BEEN SPECIFICALLY PREPARED FOR THE PROJECT DESIGNATED HEREON, ANY MODIFICATION, REVISION, DUPLICATION OR USE WITHOUT THE WRITTEN CONSENT OF SALTER SPIRAL STAIR IS PROHIBITED. RELIANCE ON THIS PLAN FOR ANY PURPOSE OTHER THAN THAT WHICH IT IS INTENDED SHALL BE AT THE SOLE DISCRETION AND LIABILITY OF THE APPLICABLE PARTY. REVISIONS: DESCRIPTION: ALUMINUM SPIRAL STAIR Paragon Stairs

NAME:

ALLEN, STEVEN

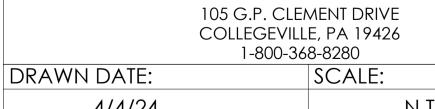


BEARING CAPACITY OF

2000 PSF.

DRAWN DATE:	SCALE:	
4/4/24	N.T.S.	
DRAWN BY:	APPROVED BY:	
Y.V.	XX	
JOB No.	REV No.	
P-418822	1	
ARCH:		
A-02		

BASE PLATE ATTACHMENT [SCALE = 1:16]

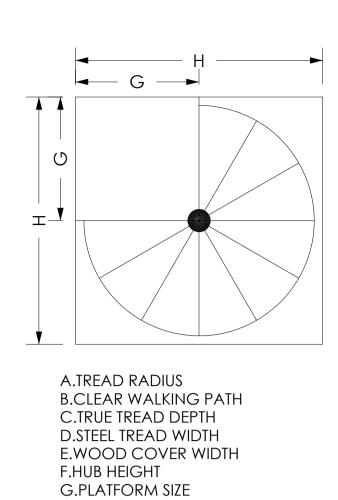

H.MINIMUM WELL OPENING

DIAMETER OF STAIR	30° 5'-0''
Α	30.00
В	26.25
С	9.35
D	16.54
Е	17.25
F	9.28
G	31"x31"
Н	62"x62"
ROTATION W/ 12 TREADS	360°


COLUMNS					
O.D. I.D.		WALL TH.	MATERIAL		
3.5" 3.00"		0.25"	TUBE		
HUBS					
O.D.	O.D. I.D.		MATERIAL		
4" 3.548"		0.226"	TUBE		


ENGINEER SEAL:

LOCAL SEAL:

TREAD SIZES & DIMENSION CHART

COLUMN & HUB SIZE

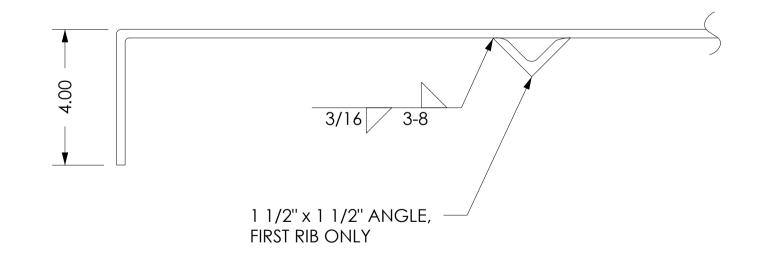

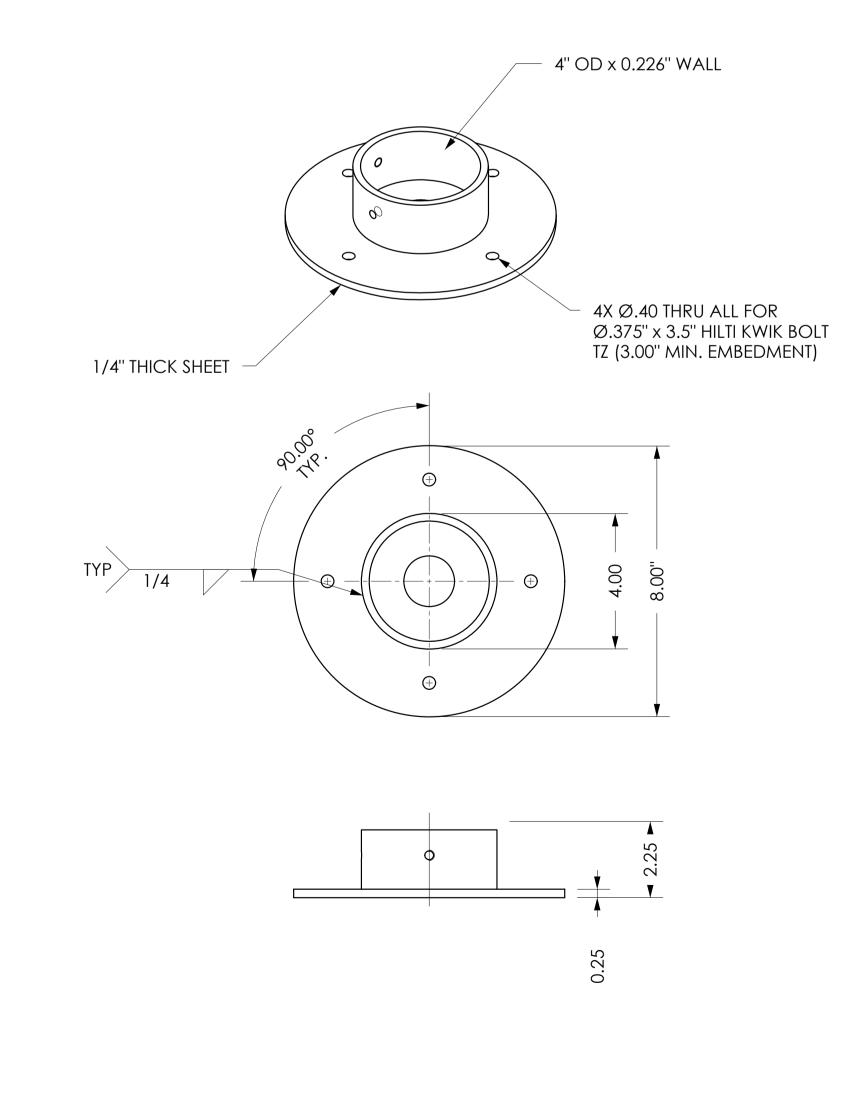

PROJECT: NAME: ALLEN, STEVEN - SHOP ALLEN, STEVEN DRAWINGS ADDRESS:

2277 DOLPHIN DR APTOS, CA 95003-5857 USA

INFORMATION SHOWN ON THIS PLAN IS THE RESULT OF A PROFESSIONAL SERVICE RENDERED BY AND IS OWNED BY SALTER SPIRAL STAIR. REPRODUCTION OF THIS PLAN WITHOUT APPROVAL OF SALTER SPIRAL STAIR IS NOT PERMITTED. THE REPRODUCTION OF A COPY OF THIS PLAN FOR THE PURPOSE OF CREATING ADDITIONAL COPIES OR REVISING SAID PLAN SHALL, IN NO CIRCUMSTANCE, BE APPROVED. VIOLATION OF THIS RESTRICTION SHALL BE CONSIDERED A VIOLATION OF BOTH THE PROFESSIONAL CODE OF ETHICS AND A THEFT OF CORPORATE ASSETS, BOTH OF WHICH SHALL BE PROSECUTED TO THE FULLEST EXTENT OF CURRENT STATUTES. THIS PLAN HAS BEEN SPECIFICALLY PREPARED FOR THE PROJECT DESIGNATED HEREON, ANY MODIFICATION, REVISION, DUPLICATION OR USE WITHOUT THE WRITTEN CONSENT OF SALTER SPIRAL STAIR IS PROHIBITED. RELIANCE ON THIS PLAN FOR ANY PURPOSE OTHER THAN THAT WHICH IT IS INTENDED SHALL BE AT THE SOLE DISCRETION AND LIABILITY OF THE APPLICABLE PARTY.

		revisions:
REV No.	DATE: DESCRIPTION:	
		ALUMINUM
		SPIRAL STAIR
		SI INAL STAIN



105 G.P. CLEMENT DRIVE COLLEGEVILLE, PA 19426 1-800-368-8280

DRAWN DATE:	SCALE:
4/4/24	N.T.S.
DRAWN BY:	APPROVED BY:
Y.V.	XX
JOB No.	REV No.
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ARCH:	

ARCH.

A-03

