COUNTY OF SANTA CRUZ PLANNING DEPARTMENT 701 Ocean Street, 4th Floor Santa Cruz, CA 95060 (831) 454-2580

NOTICE OF PENDING ACTION

The Planning Department has received the following application. The identified planner may be contacted for specific information on this application.

APPLICATON NUMBER: 241435 APN: 025-054-06 SITUS: Intersection of Soquel Drive and Paul Sweet Road

Proposal to extend the expiration date of Commercial Development Permit and Master Site Plan 211088 (Construct a 4,815 square foot administrative office building for the Santa Cruz Metropolitan Transit District) from 11/24/24 to 11/24/25. Requires a Time Extension.

Property is located at the intersection of Soquel Drive and Paul Sweet Road (former Park and Ride lot).

OWNER: Santa Cruz Metro Transit District

APPLICANT: Swift Consulting Services – Ken Hart

SUPERVISORIAL DISTRICT: 1

PLANNER: Randall Adams, (831) 454-3218

EMAIL: Randall. Adams@santacruzcountyca.gov

Public comments must be received by 5:00 p.m. 1/27/2025. A decision will be made on or shortly after 1/28/2025.

Appeals of the decision will be accepted until 5:00 p.m. two weeks after the decision date. Planner will provide notification of decision to any requesting party.

Information regarding the appeal process, including required fees, may be obtained by phoning (831) 454-2130.



CALGREEN PARKING CALCULATIONS

(PER NONRESIDENTIAL MANDATORY MEASURES)

CALGREEN BICYCLE PARKING REQUIREMENTS (CALGREEN 5.106.4)

SHORT-TERM BICYCLE PARKING (PER 5.106.4.1.1):

[PERMANENTLY ANCHORED BICYCLE RACKS WITHIN 200 FT OF ENTRANCE] FOR 5% OF VEHICLE PARKING SPACES (MIN OF ONE TWO-BIKE CAPACITY RACK). TOTAL VEHICLE PARKING SPACES: 27 SPACES @ 5% = 1.35 REQUIRED. 6 PROVIDED (3 TWO-BIKE CAPACITY RACKS).

LONG-TERM BICYCLE PARKING (PER 5.106.4.1.2):

[BIKE LOCKER, LOCKABLE ENCLOSURE, OR A BIKE ROOM] FOR 5% OF VEHICULAR PARKING SPACES (MIN OF ONE BICYCLE PARKING FACILITY). TOTAL VEHICLE PARKING SPACES: 27 SPACES @ 5% = 1.35 REQUIRED.

CALGREEN DESIGNATED PARKING FOR CLEAN AIR VEHICLES (CALGREEN 5.106.5.2)

TOTAL VEHICLE PARKING SPACES: 27 SPACES (BETWEEN 10-25) = 1 REQUIRED. SPACE SHALL BE STRIPE PAINTED WITH "CLEAN AIR/VANPOOL/EV". 1 DEDICATED CLEAN AIR VEHICLE PARKING SPACE PROVIDED.

CALGREEN ELECTRIC VEHICLE (EV) CHARGING (CALGREEN 5.106.5.3)

REQUIREMENT: TO FACILITATE FUTURE INSTALLATION OF ELECTRIC VEHICLE SUPPLY **EQUIPMENT (EVSE).**

TOTAL VEHICLE PARKING SPACES: 27 SPACES = 2 REQ'D EV CHARGING SPACES

5.106.5.3.2 MULTIPLE CHARGING SPACE REQUIREMENTS. WHEN MULTIPLE CHARGING SPACES ARE REQUIRED ... RACEWAY(S) IS/ARE REQUIRED TO BE INSTALLED AT THE

3. PLAN DESIGN SHALL BE BASED UPON 40-AMPERE MINIMUM BRANCH CIRCUITS

TIME OF CONSTRUCTION ... 1. THE TYPE AND LOCATION OF THE EVSE.

2 BIKE LOCKERS PROVIDED.

2. THE RACEWAY(S) SHALL ORIGINATE AT A SERVICE PANEL OR A SUBPANEL(S) SERVING THE AREA, AND SHALL TERMINATE IN CLOSE PROXIMITY TO THE PROPOSED LOCATION OF THE CHARGING EQUIPMENT AND INTO LISTED SUITABLE CABINET(S), BOX(ES), ENCLOSURE(S) OR EQUIVALENT.

4. ELECTRICAL CALCULATIONS SHALL SUBSTANTIATE THE DESIGN OF THE ELECTRICAL SYSTEM, TO INCLUDE THE RATING OF EQUIPMENT AND ANY ON-SITE DISTRIBUTION TRANSFORMERS AND HAVE SUFFICIENT CAPACITY TO SIMULTANEOUSLY CHARGE ALL REQUIRED EVS AT ITS FULL RATED AMPERAGE. 5. THE SERVICE PANEL OR SUBPANEL(S) SHALL HAVE SUFFICIENT CAPACITY TO ACCOMMODATE THE

REQUIRED NUMBER OF DEDICATED BRANCH CIRCUIT(S) FOR THE FUTURE INSTALLATION OF THE EVSE.

PARKING CALCULATIONS

BUILDING AREA: 4,815 SF

DESCRIPTION OF USE: ADMINISTRATIVE OFFICE BUILDING

REQUIRED PARKING: 1 PARKING SPACE PER 300 SF

4,815 SF / 300 = 16 PARKING SPACES

REQUIRED BIKE PARKING: 1 BIKE PARKING PER 1,000 SF 4,815 SF / 1,000 = 4.8 = 5 BIKE PARKING

EXISTING PARKING COUNT: 117 PARKING SPACES

PROPOSED PARKING: 25 PASSENGER VEHICLE PARKING

1 ADA VAN ACCESSIBLE PARKING SPACE 1 ADA STANDARD ACCESSIBLE PARKING SPACE 27 TOTAL PARKING SPACES (PER EMPLOYEE COUNT)

PROPOSED BIKE PARKING: 6 BIKE PARKING

PROPOSED FLEET VEHICLE PARKING: 32 SHUTTLE VAN PARKING SPACES

ZONING REGULATIONS

ZONING: PF (PUBLIC AND COMMUNITY FACILITIES)

MAXIMUM HEIGHT: 35 FT, 3-STORIES

FRONT SETBACK: **20FT (ABUTS RESIDENTIAL USE)**

20FT (ABUTS RESIDENTIAL USE) SIDE SETBACK: **REAR SETBACK: 20FT (ABUTS RESIDENTIAL USE)**

PROPOSED BUILDING

BUILDING AREA: 4,815 SF

1-STORY STORIES:

BUILDING HEIGHT: 24 FT MAX (FROM EXISTING AND FINISH GRADE)

DESCRIPTION OF USE: ADMINISTRATIVE OFFICE BUILDING

OCCUPANCY GROUP: B

CONSTRUCTION TYPE: V-B

SPRINKLERS: **BUILDING SHALL BE FULLY SPRINKLERED**

SHEET INDEX

A101 PROPOSED SITE PLAN

A102 EXISTING SITE PLAN

A121 SITE DETAILS A201 FLOOR PLAN AND ROOF PLAN

A301 EXTERIOR ELEVATIONS & BLDG SECTIONS

A302 3D MODEL VISUALIZATIONS C1 TITLE SHEET

C2 SITE DIMENSION PLAN

C3 EXISTING DRAINAGE PLAN

C4 GRADING PLAN

C5 STORMWATER CONTROL PLAN C6 UTILITY PLAN

C7 DETENTION BASIN DETAIL

C8 SIGNING AND STRIPING PLAN

L1.0 PRELIMINARY LANDSCAPE

E1 LIGHTING PLAN

L1.1 PLANT IMAGES

P1 LIGHTING ANALYSIS

PROJECT INFORMATION

PROJECT NAME: SC METRO PARATRANSIT FACILITY

ADDRESS: XX PAUL SWEET ROAD, SANTA CRUZ, CA 95065

A.P.N.: 025-054-06

PROJECT DESCRIPTION: PROPOSED NEW CONSTRUCTION OF A 4,815 SF ADMINISTRATIVE OFFICE BUILDING AND ASSOCIATED

SITE IMPROVEMENTS FOR THE SANTA CRUZ METROPOLITAN TRANSIT DISTRICT. THE FACILITY WILL HOUSE THE DISTRICT'S PARCRUZ PROGRAM AND

GRAPHIC SCALE: 1"=20'-0"

DISPATCH SHUTTLE VANS.

OVERALL PROPOSED SITE PLAN

ZONING: PF (PUBLIC AND COMMUNITY FACILITIES) **GENERAL PLAN:**


O-U; P

PARCEL AREA: 2.92 ACRES (ASSESSOR'S ACREAGE)

EXISTING USE: PARK AND RIDE FACILITY

PROPOSED USE: PARACRUZ ADMIN OFFICES AND SHUTTLE VANS

VICINITY MAP

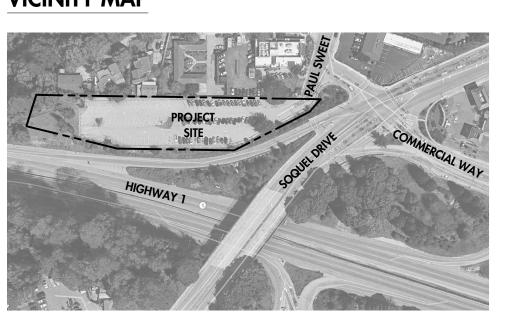



WRITTEN CONSENT C


ility U O H S

> PLANNING APPLICATION 03/01/202 RESUBMITTAL 07/30/202 SHEET NAME: **PROPOSED** SITE PLAN

SCA PROJECT NUMBER: 20057

SET ISSUED:

HEET NUMBER:

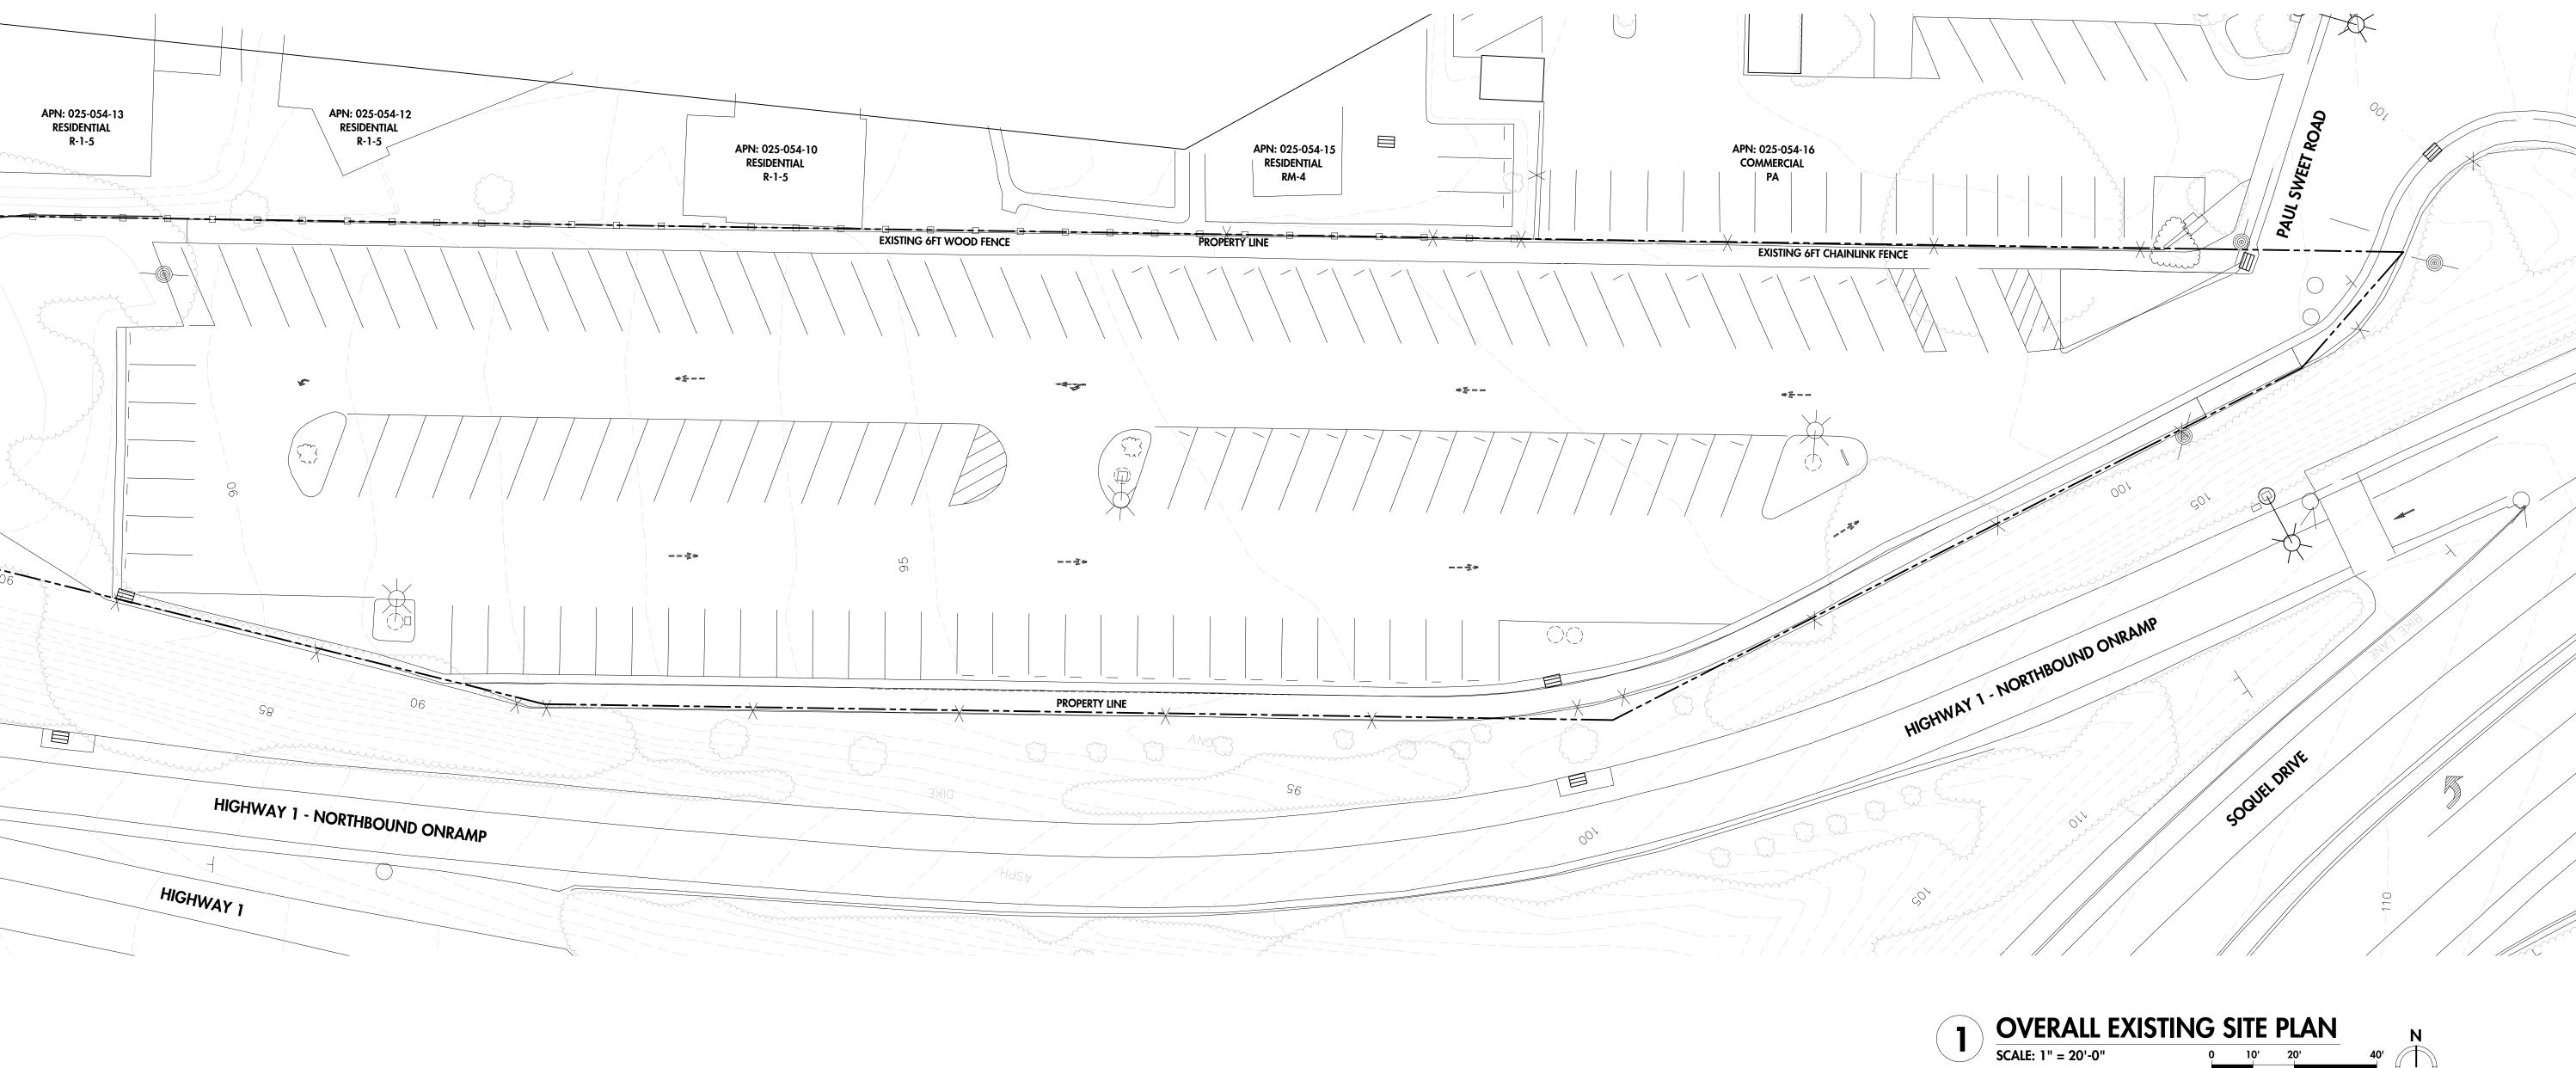



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SCHEMATIC DESIGN FOR:

SC Metro ParaTransit Facility

XX PAUL SWEET ROAD

SCA PROJECT NUMBER: 20057

SET ISSUED:

PLANNING APPLICATION 03/01/2021

1 RESUBMITTAL 07/30/2021

SITE PLAN

SHEET NUMBER:


EXISTING

SHEET NAME:


REFUSE ENCLOSURE DESIGN SCALE: 1/4" = 1'-0"






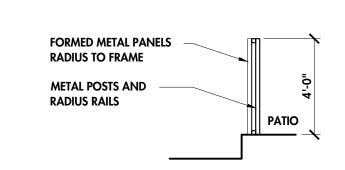



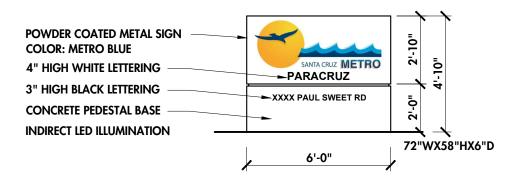

MONUMENT SIGN AT SITE ENTRY

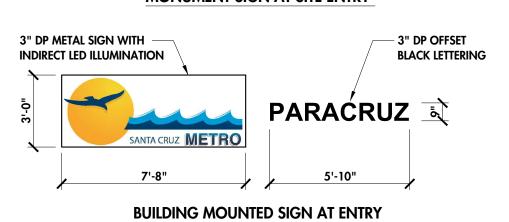





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HEMATIC DESIGN FOR:

C Metro ParaTransit Facility

ULI SWEET ROAD

SCA PROJECT NUMBER: 20057

SET ISSUED:


PLANNING APPLICATION 03/01/202

1 RESUBMITTAL 07/30/202

SHEET NAME:

SITE DETAILS

A121

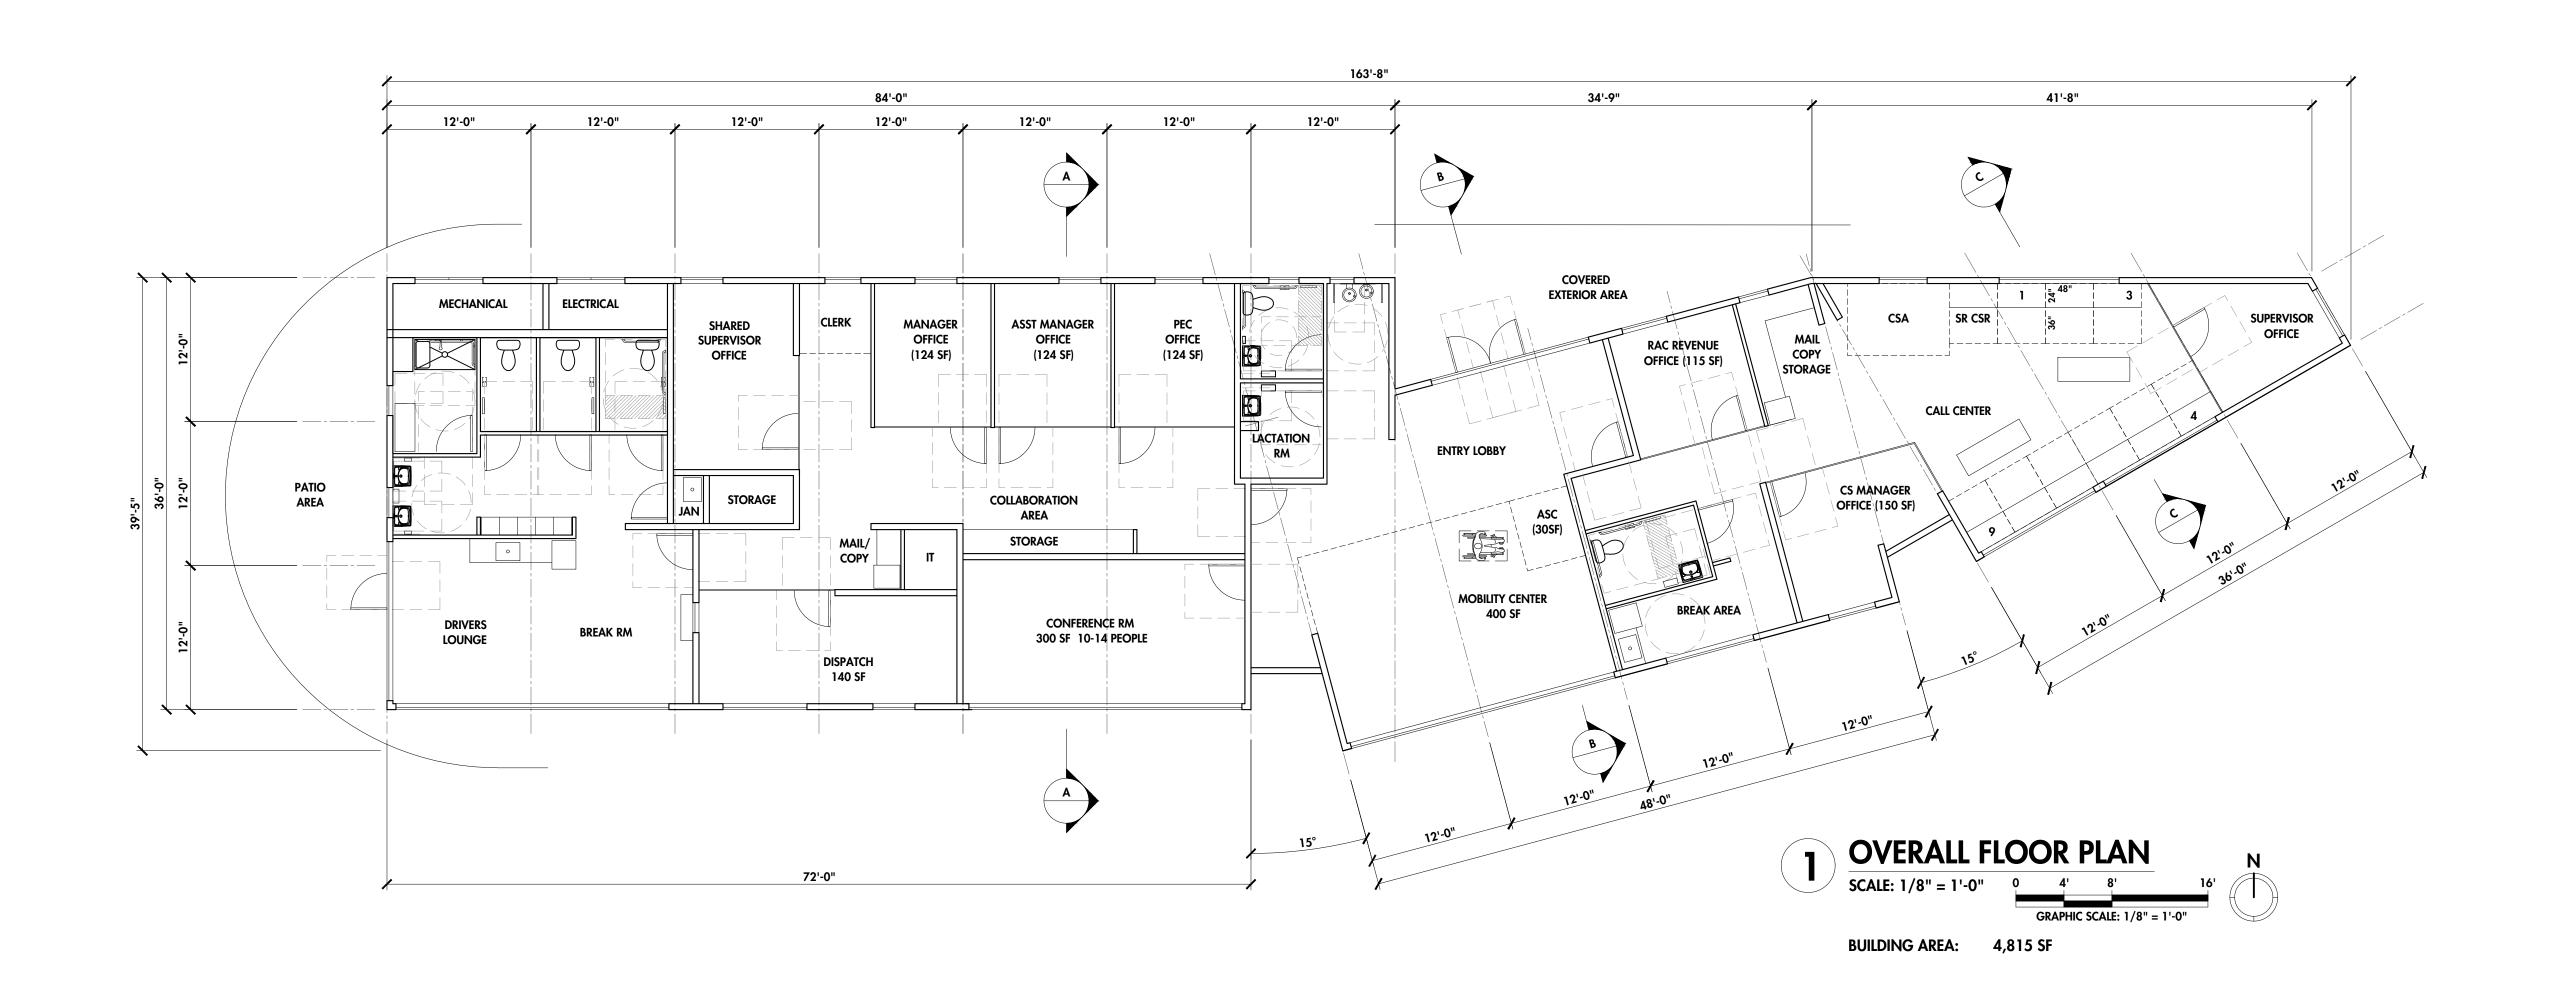



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SCHEMATIC DESIGN FOR:

SC Metro ParaTransit Facility

SCA PROJECT NUMBER: 20057

PLANNING APPLICATION 03/01/2021RESUBMITTAL 07/30/2021

FLOOR PLAN

& ROOF PLAN

SET ISSUED:

SHEET NAME:

SPECTOR CORBETT ARCHITECTS SANTA CRUZ | WATSONVILLE relocating 54 Penny Ln office Suite C 9 5 0 6 0 9 5 0 7 6 8 3 1 - 3 1 9 - 4 0 4 5 SPECTORCORBETT.COM

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Facility IGN FOR:
ParaTransit

SCA PROJECT NUMBER: 2005

SET ISSUED: PLANNING APPLICATION 03/01/202

RESUBMITTAL 07/30/202

SHEET NAME: **EXTERIOR ELEVATIONS &**

BLDG SECTIONS

GRAPHIC SCALE: 1/8" = 1'-0"

SITE Q VIEWS STREET




INTERSECTION AT SOQUEL DRIVE AND PAUL SWEET ROAD



NORTHBOUND ONRAMP TO CA HIGHWAY 1



SOQUEL DRIVE OVERPASS BRIDGE

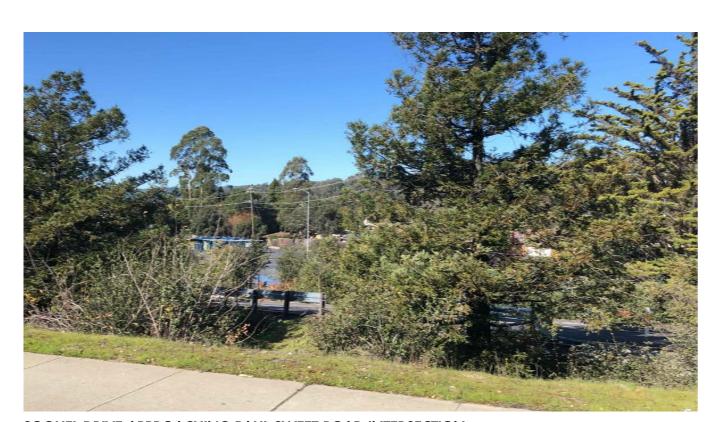

SOQUEL DRIVE APPROACHING PAUL SWEET ROAD INTERSECTION






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PLANNING APPLICATION 03/01/202 \ RESUBMITTAL 07/30/2021 3D MODEL **VISUALIZATIONS**

acility

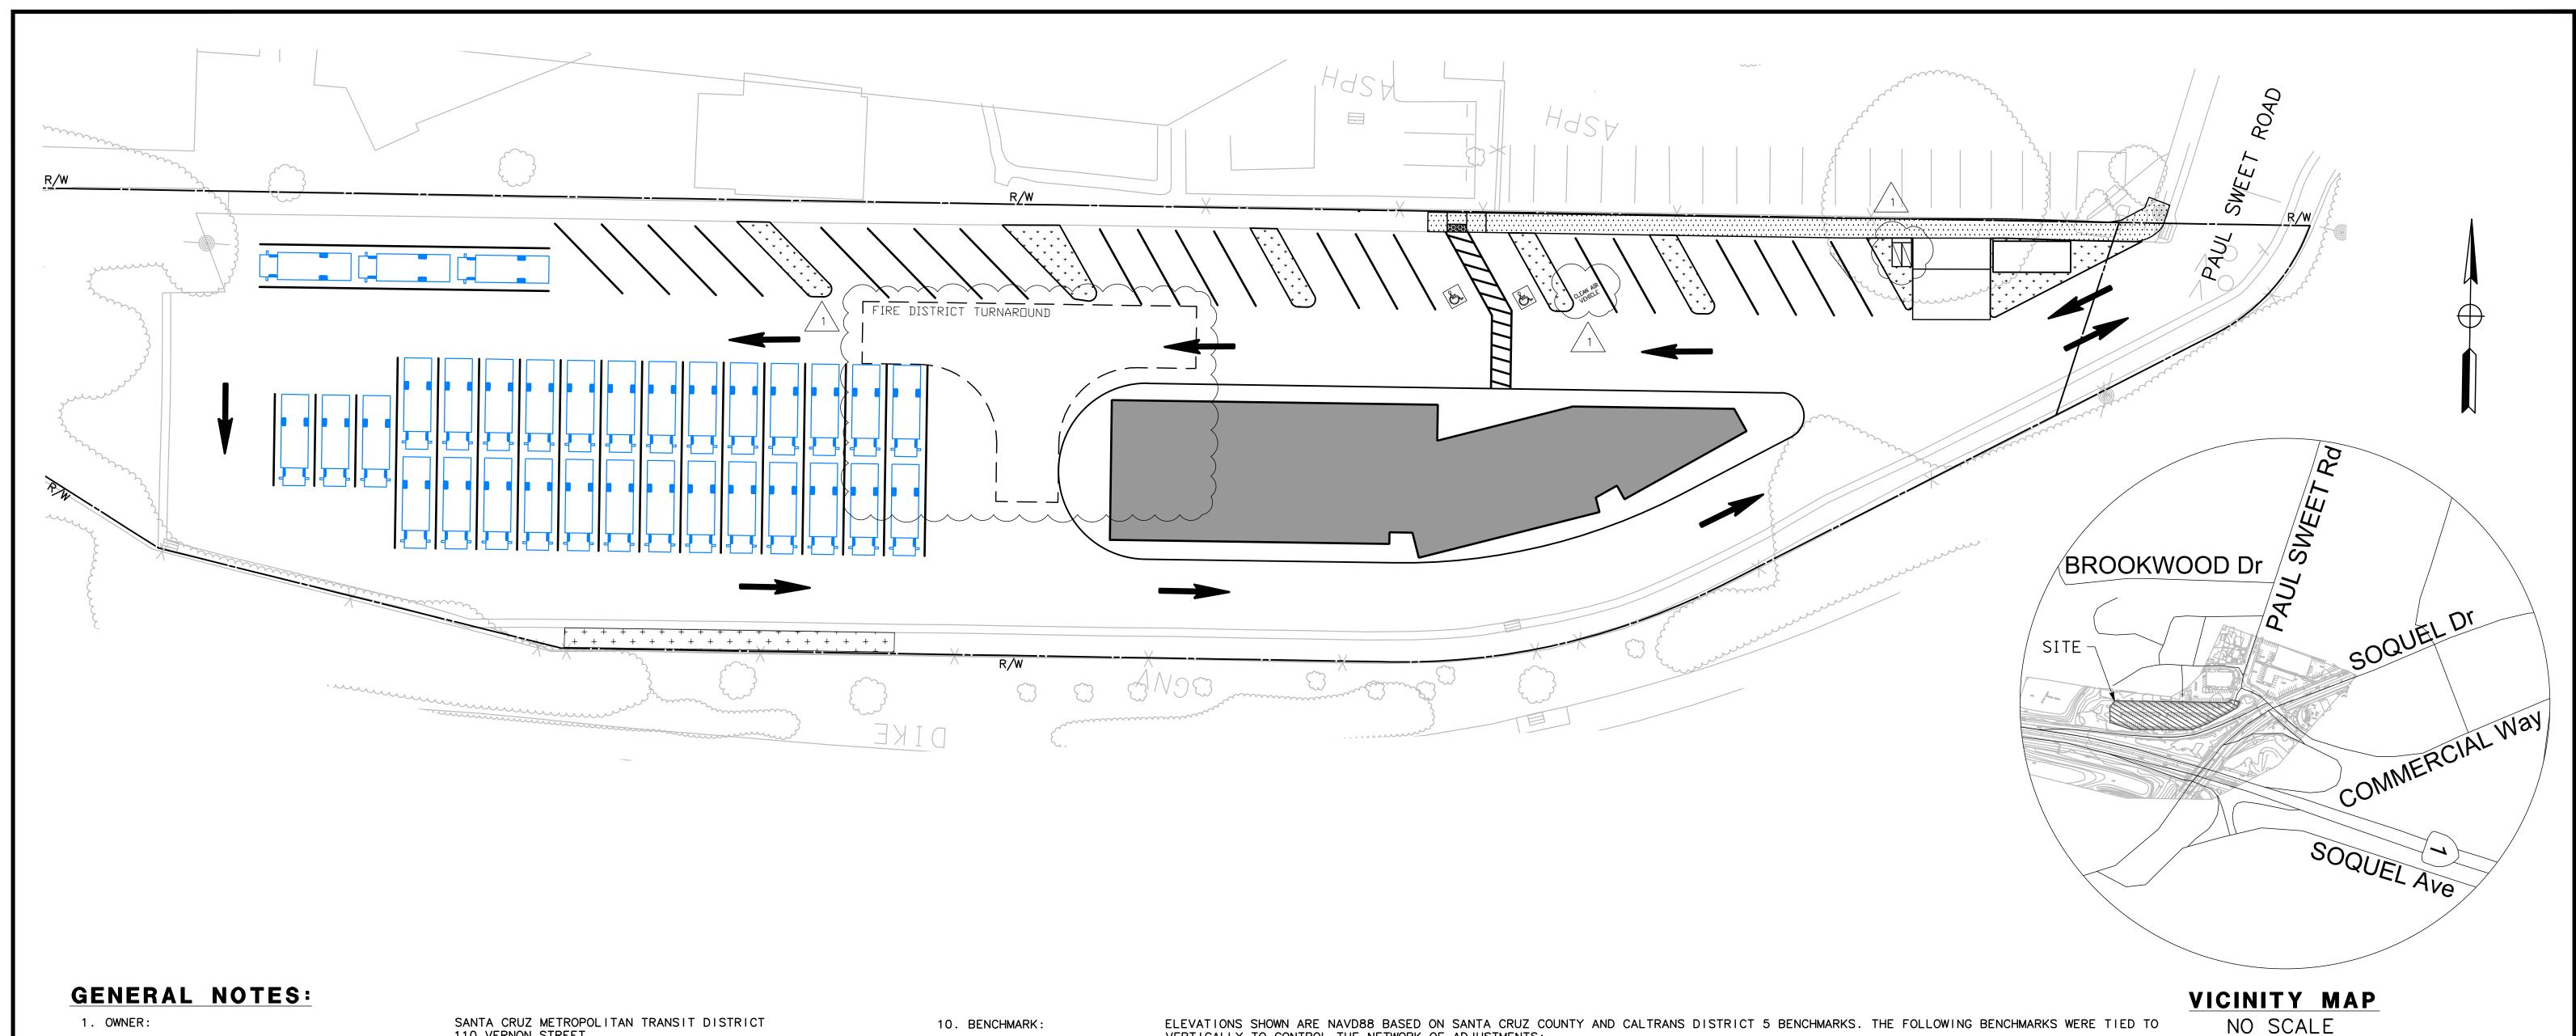

110 VERNON STREET

SANTA CRUZ, CA 95060

2. ENGINEER: MARK THOMAS & COMPANY, INC. 360 22ND STREET, SUITE 501 OAKLAND, CA 94612

3. SOILS ENGINEER: DEES & ASSOCIATES, INC. 501 MISSION STREET, SUITE 8A

SANTA CRUZ, CA 65060

SPECTOR CORBETT ARCHITECTS, INC. 877 CEDAR STREET, SUITE 248 4. ARCHITECT: SANTA CRUZ, CA 95060

5. EXISTING USE: PARKING LOT 6. PROJECT AREA: 1.23± AC

7. OWNERSHIP AND MAINTENANCE: OWNED AND MAINTAINED BY SANTA CRUZ METROPOLITAN TRANSIT DISTRICT

8. THIS PROPERTY LIES IN THE JURISDICTION OF:

-FIRE PROTECTION: CENTRAL FIRE PROTECTION DISTRICT -DOMESTIC WATER: CITY OF SANTA CRUZ -SANITARY SEWER: SANTA CRUZ SANITATION DISTRICT

-STORM DRAIN WITHIN PUBLIC STREET/EASEMENT: CITY OF SANTA CRUZ

02505406 9. ASSESSOR PARCEL NUMBERS:

VERTICALLY TO CONTROL THE NETWORK OF ADJUSTMENTS: POINT: PM1486 SCR1 DN323 ELEVATION: 112.06 DESCRIPTION: CT LEAD & TACK

ELEVATION: 99.79 DESCRIPTION: SCC BM POINT: BM-44A

THE COORDINATES AND BEARINGS SHOWN HEREON ARE BASED UPON THE CALIFORNIA COORDINATE SYSTEM OF 1983, CCS83, ZONE 3, (2017.50) IN ACCORDANCE WITH THE CALIFORNIA PUBLIC RESOURCES CODE SECTIONS 8801-8819; SAID COORDINATES (US SURVEY FEET) AND BEARINGS ARE BASED LOCALLY UPON FIELD-OBSERVED TIES TO THE FOLLOWING CALIFORNIA SPATIAL REFERENCE NETWORK:

P212 (N)1811539.974 (E)6163514.713 (Elev.)230.96 P213 (N)1899375.801 (E)6127479.738 (Elev.)656.51 P534 (N)1849474.814 (E)6054667.384 (Elev.)782.18

SODB (N)1886225.298 (E)6146305.297 (Elev.)3341.36

PREPARED BY MARK THOMAS & COMPANY, INC., DATED DECEMBER 15, 2020

11. BASIS OF BEARINGS:

12. TOPOGRAPHY:

13. FLOOD ZONE:

SANTA CRUZ COUNTY PARCEL INFORMATION DETAIL REPORT MAP NUMBER: 06087C0351E

EFFECTIVE DATE: FEBRUARY 2, 2021

RESUBMITTAL 07/30/2021

DRAWN BY: CK DESIGNED BY: AL CHECKED BY: AL SCALE: 1" = 20'

PARATRANSIT FACILITY


SANTA CRUZ METROPOLITAN TRANSIT DISTRICT TITLE SHEET


MARK 360 22nd STREET, SUITE 501
OAKLAND, CA 94612 ■ THOMAS (510) 844-5600 www.markthomas.com





110 VERNON STREET SANTA CRUZ, CA 95060


07/30/2021 SHEET _7_of_18_ PROJECT No. SJ-20107

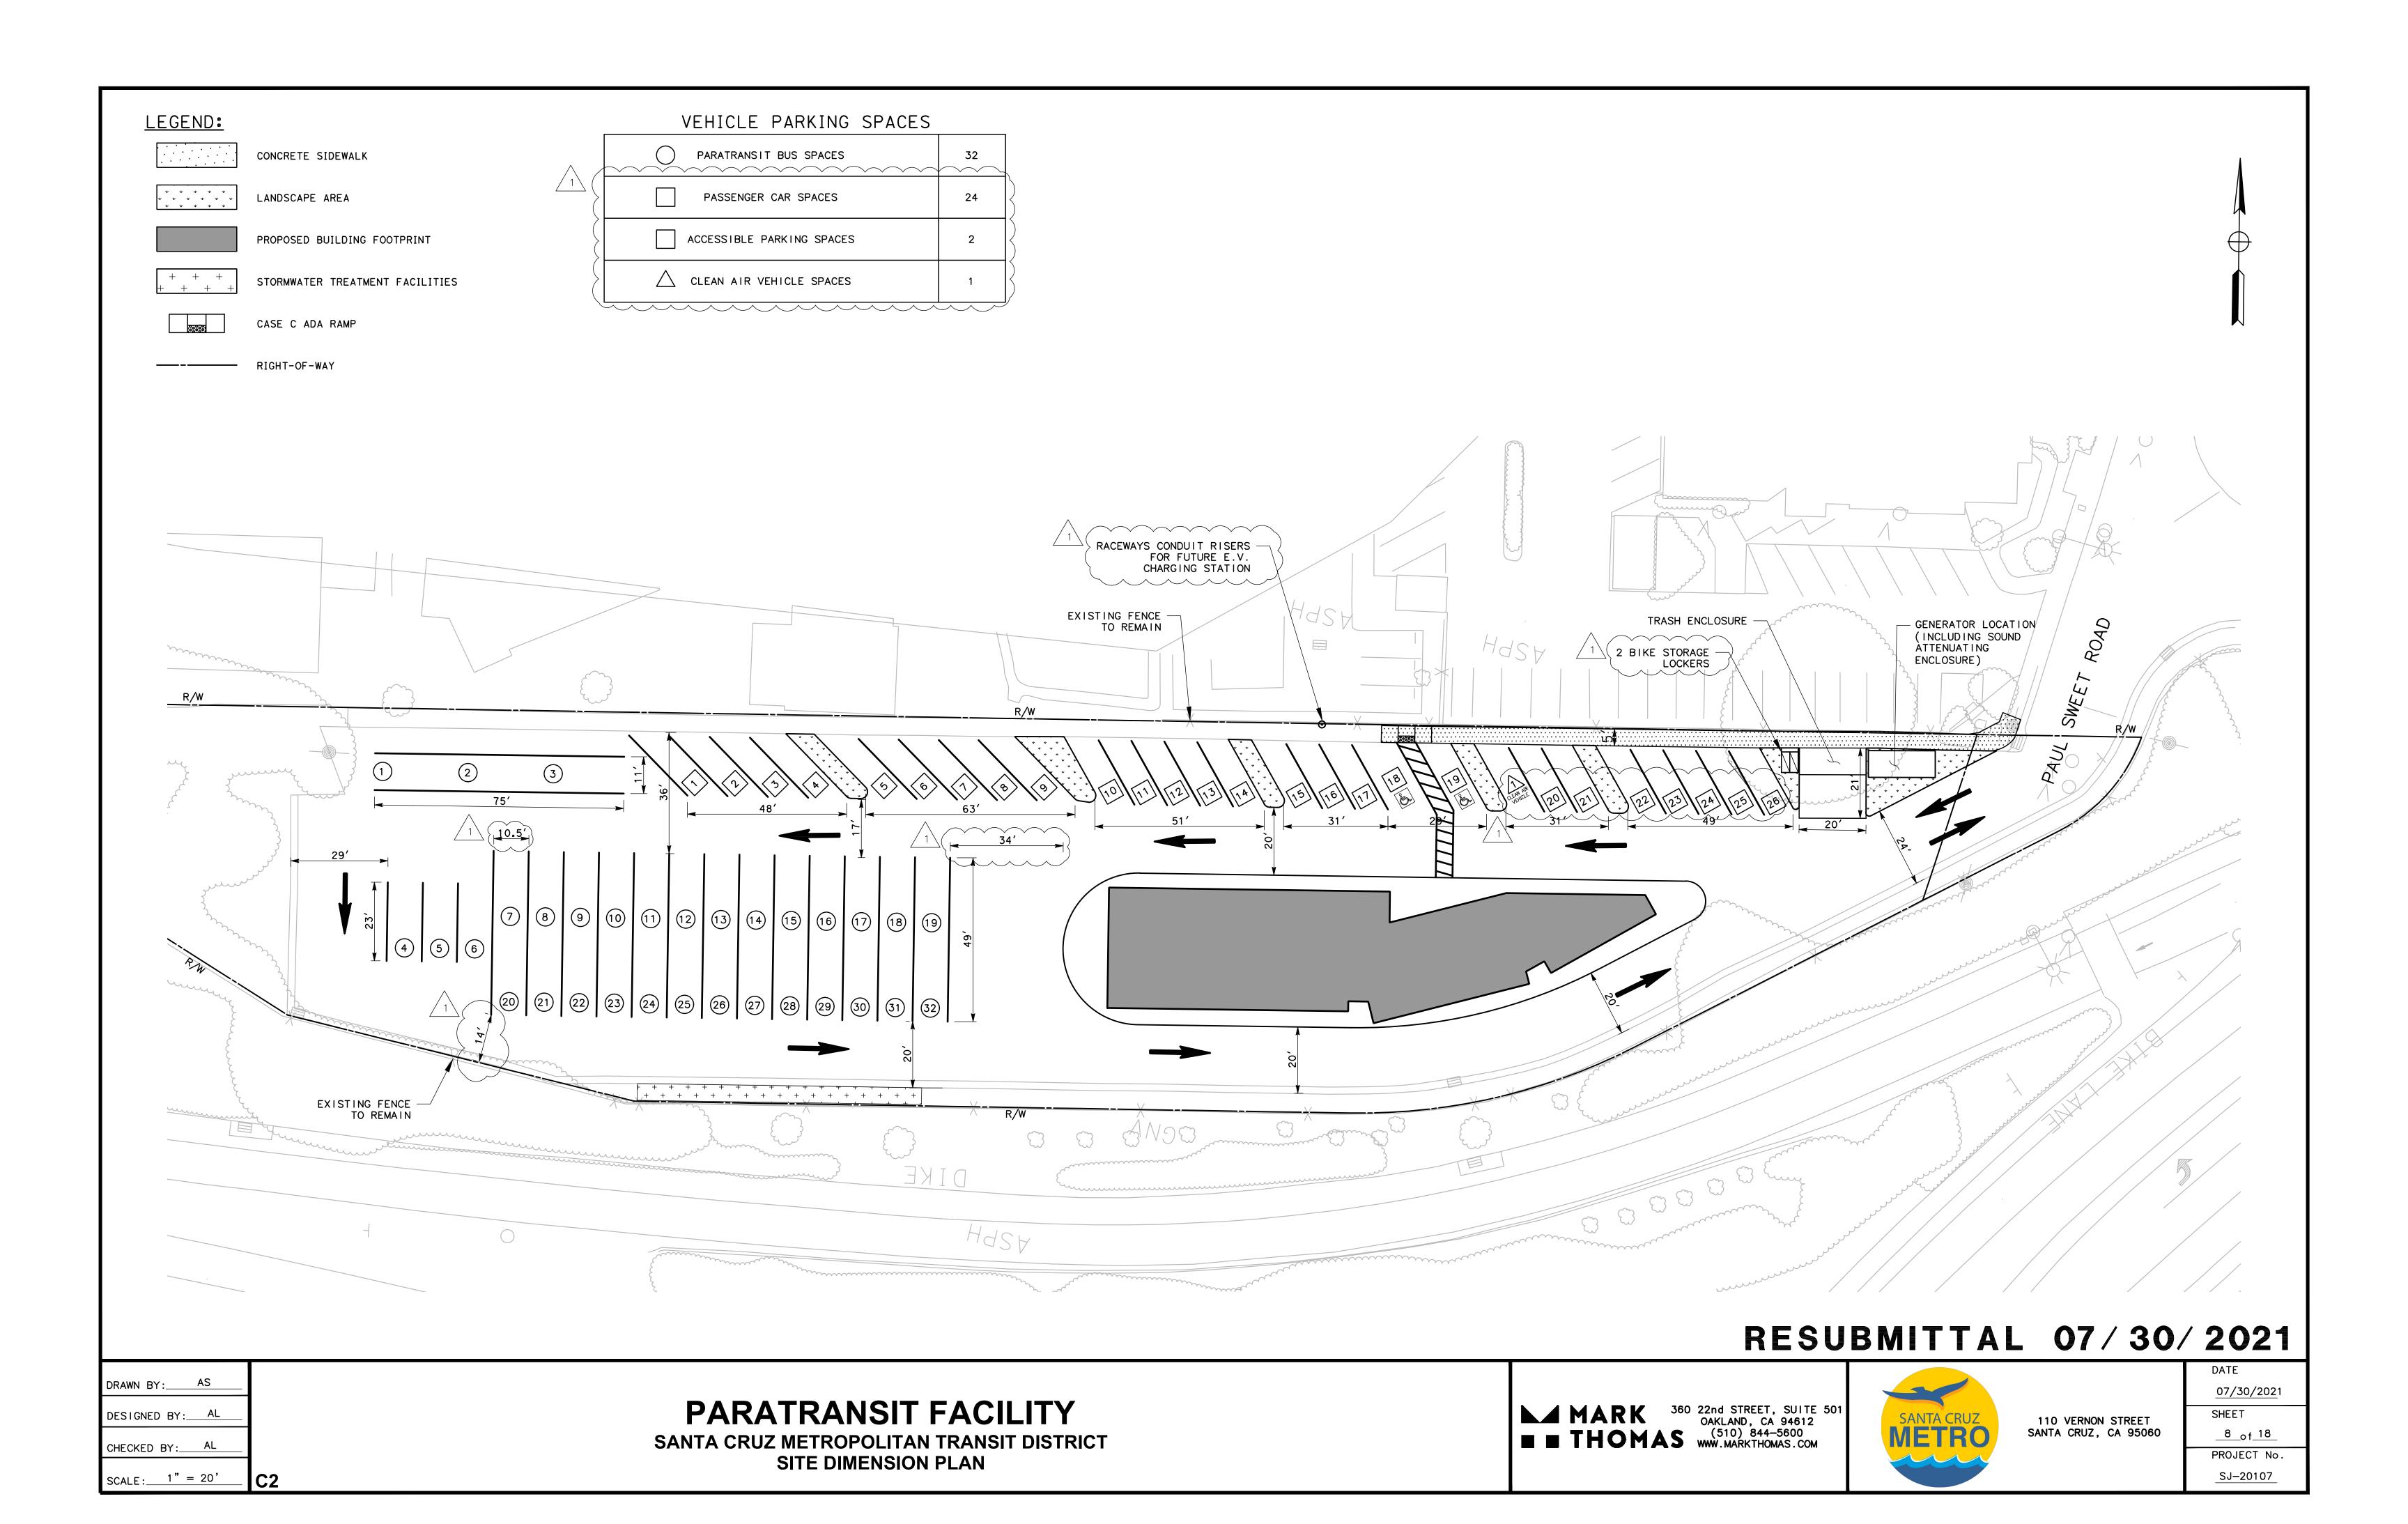


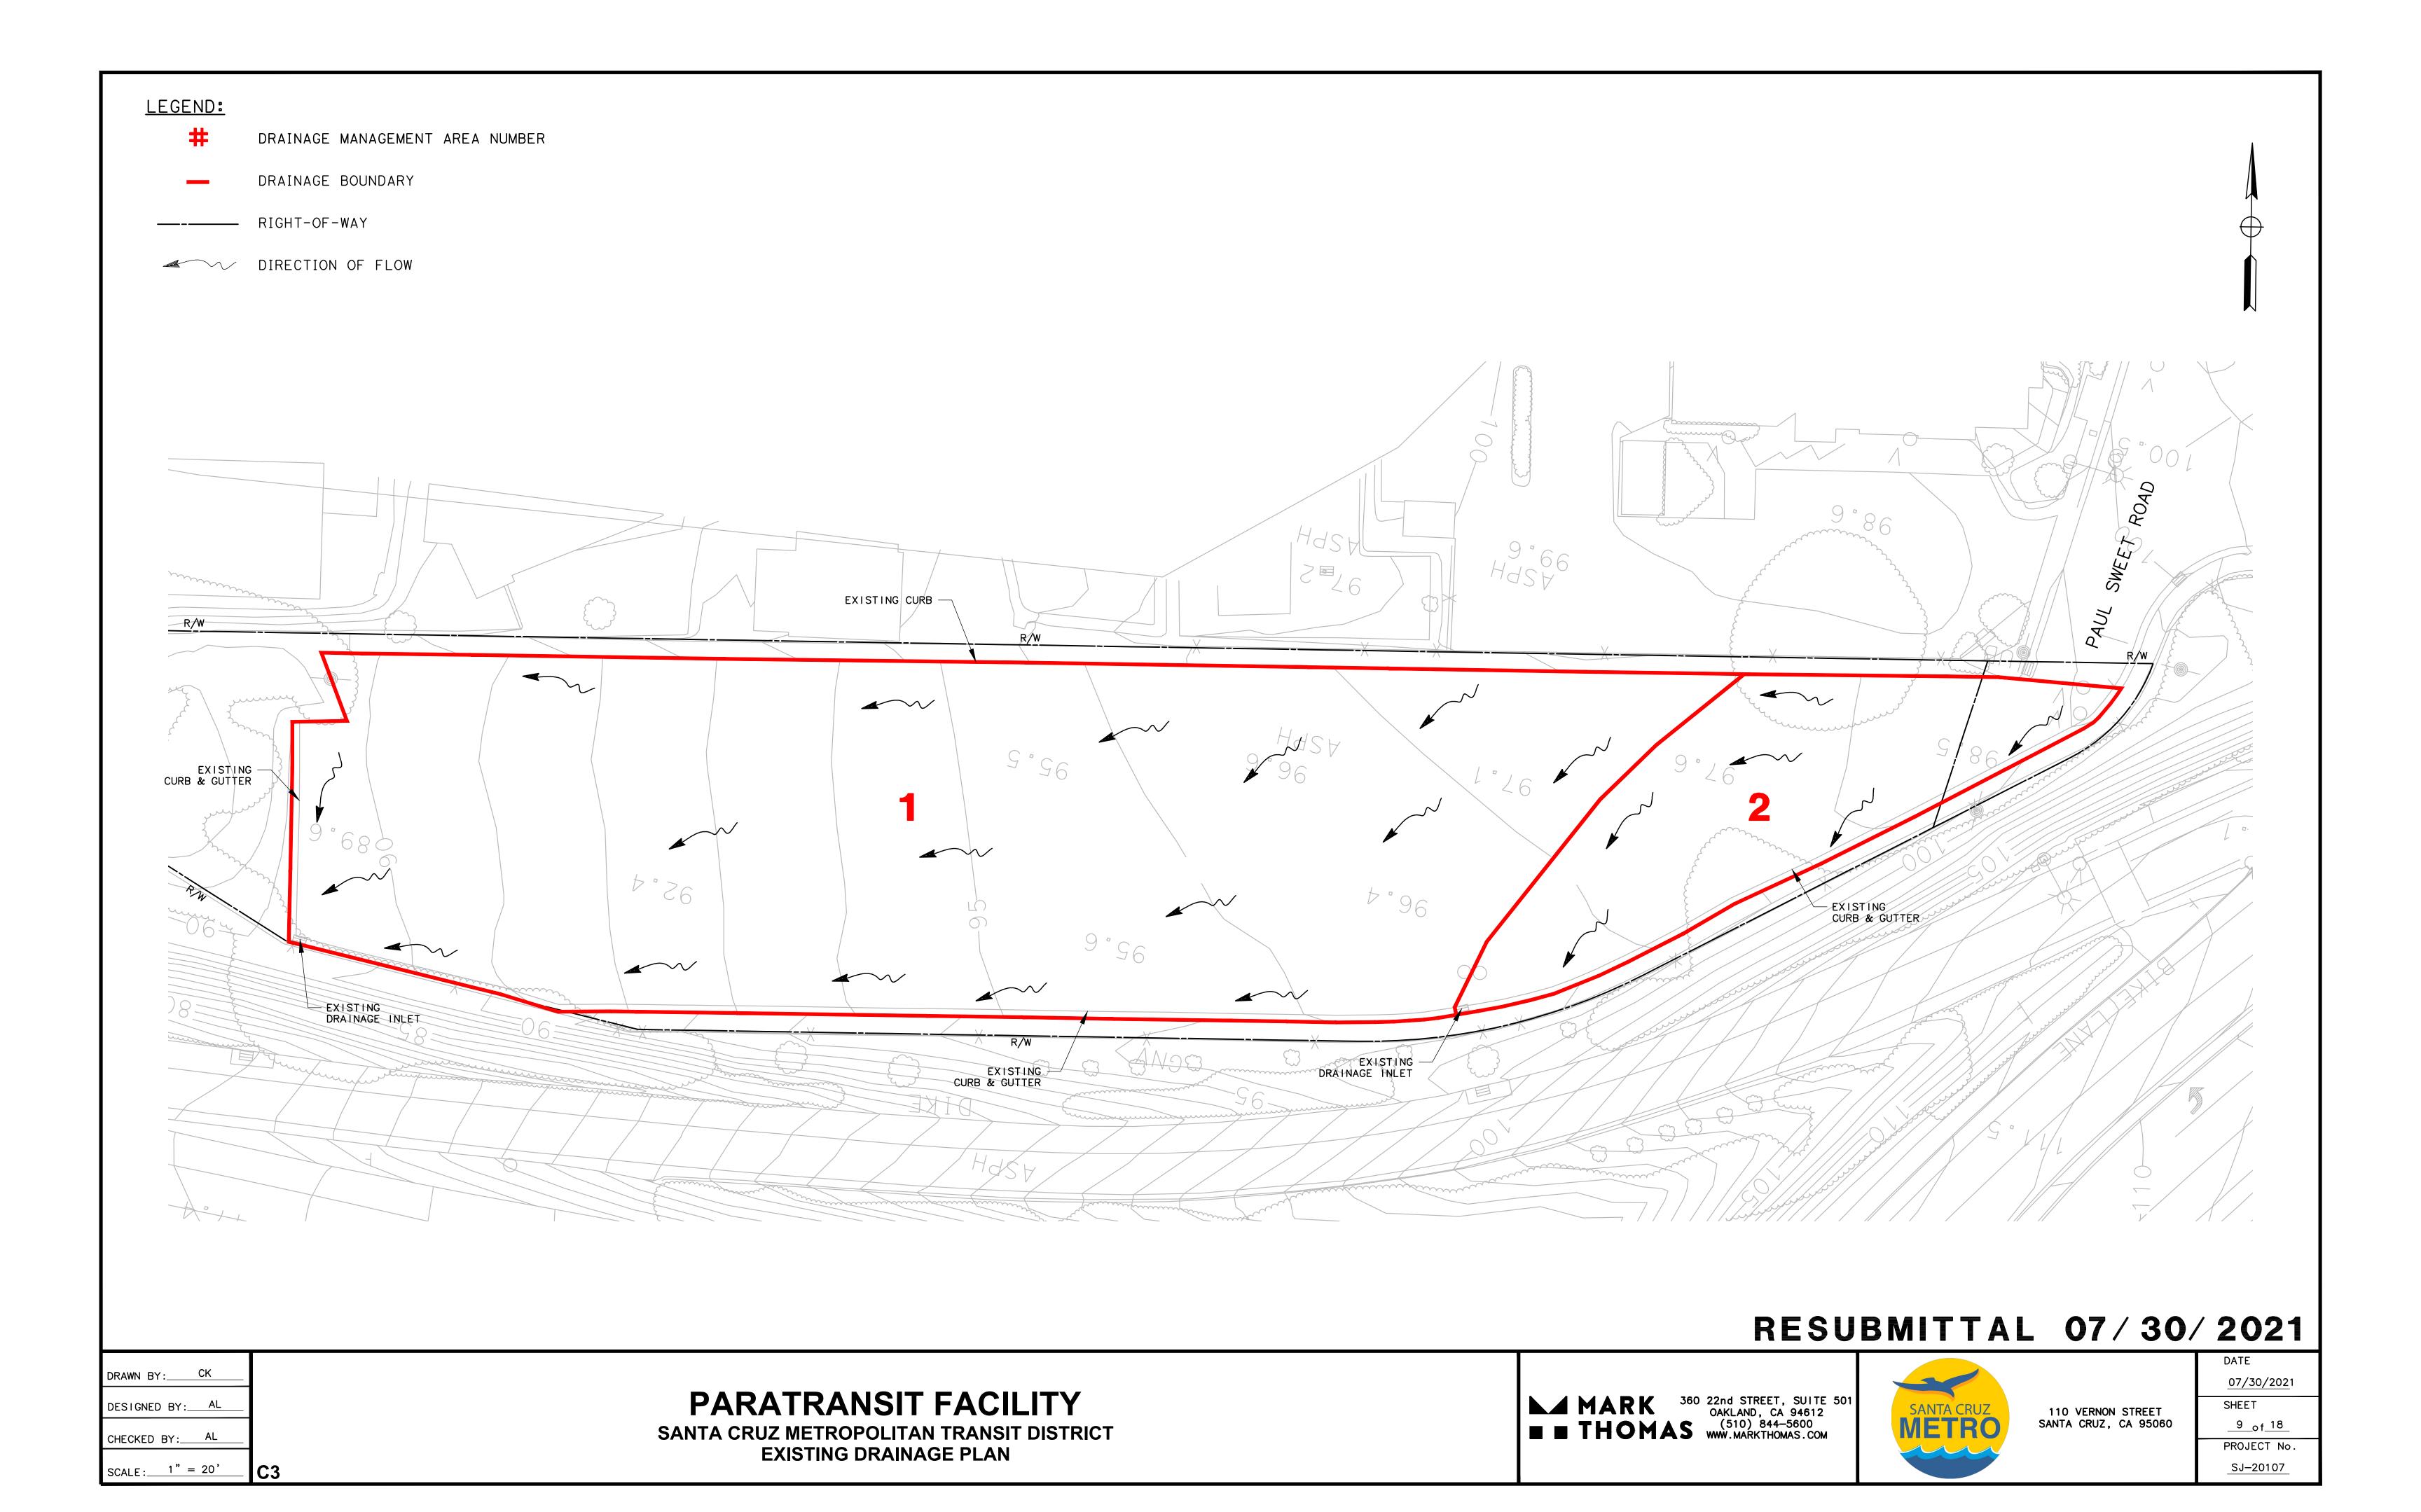

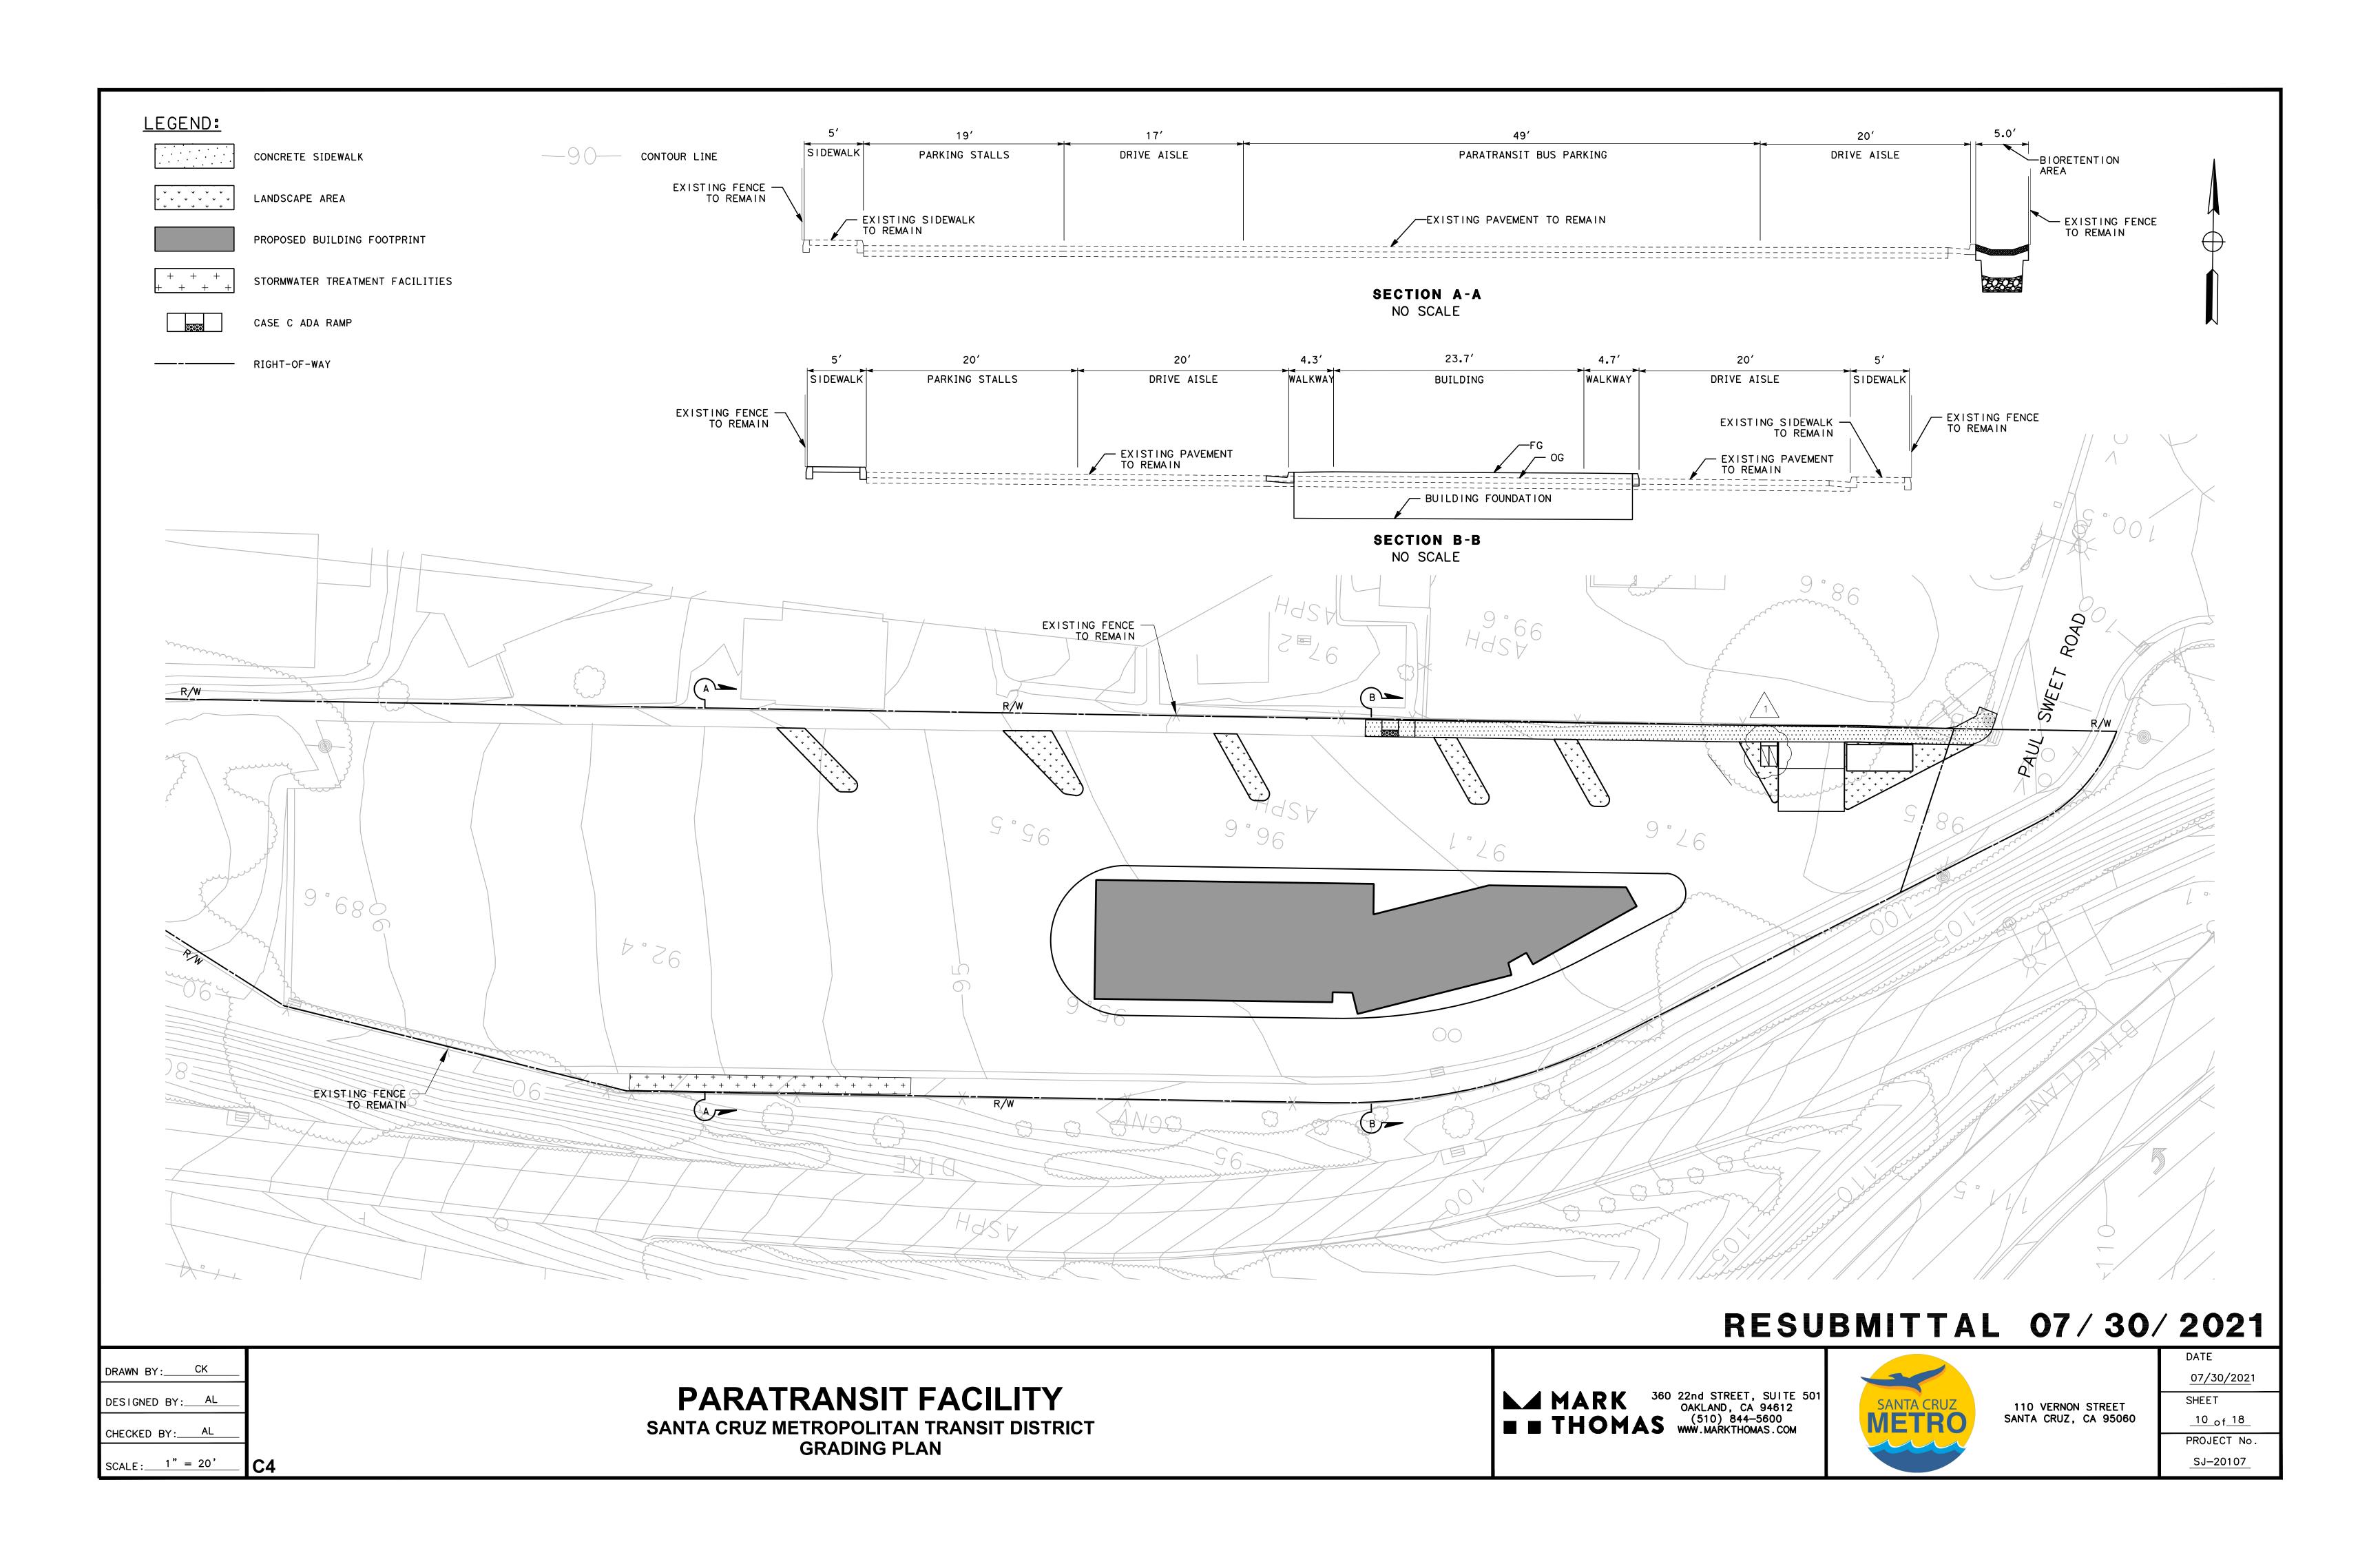

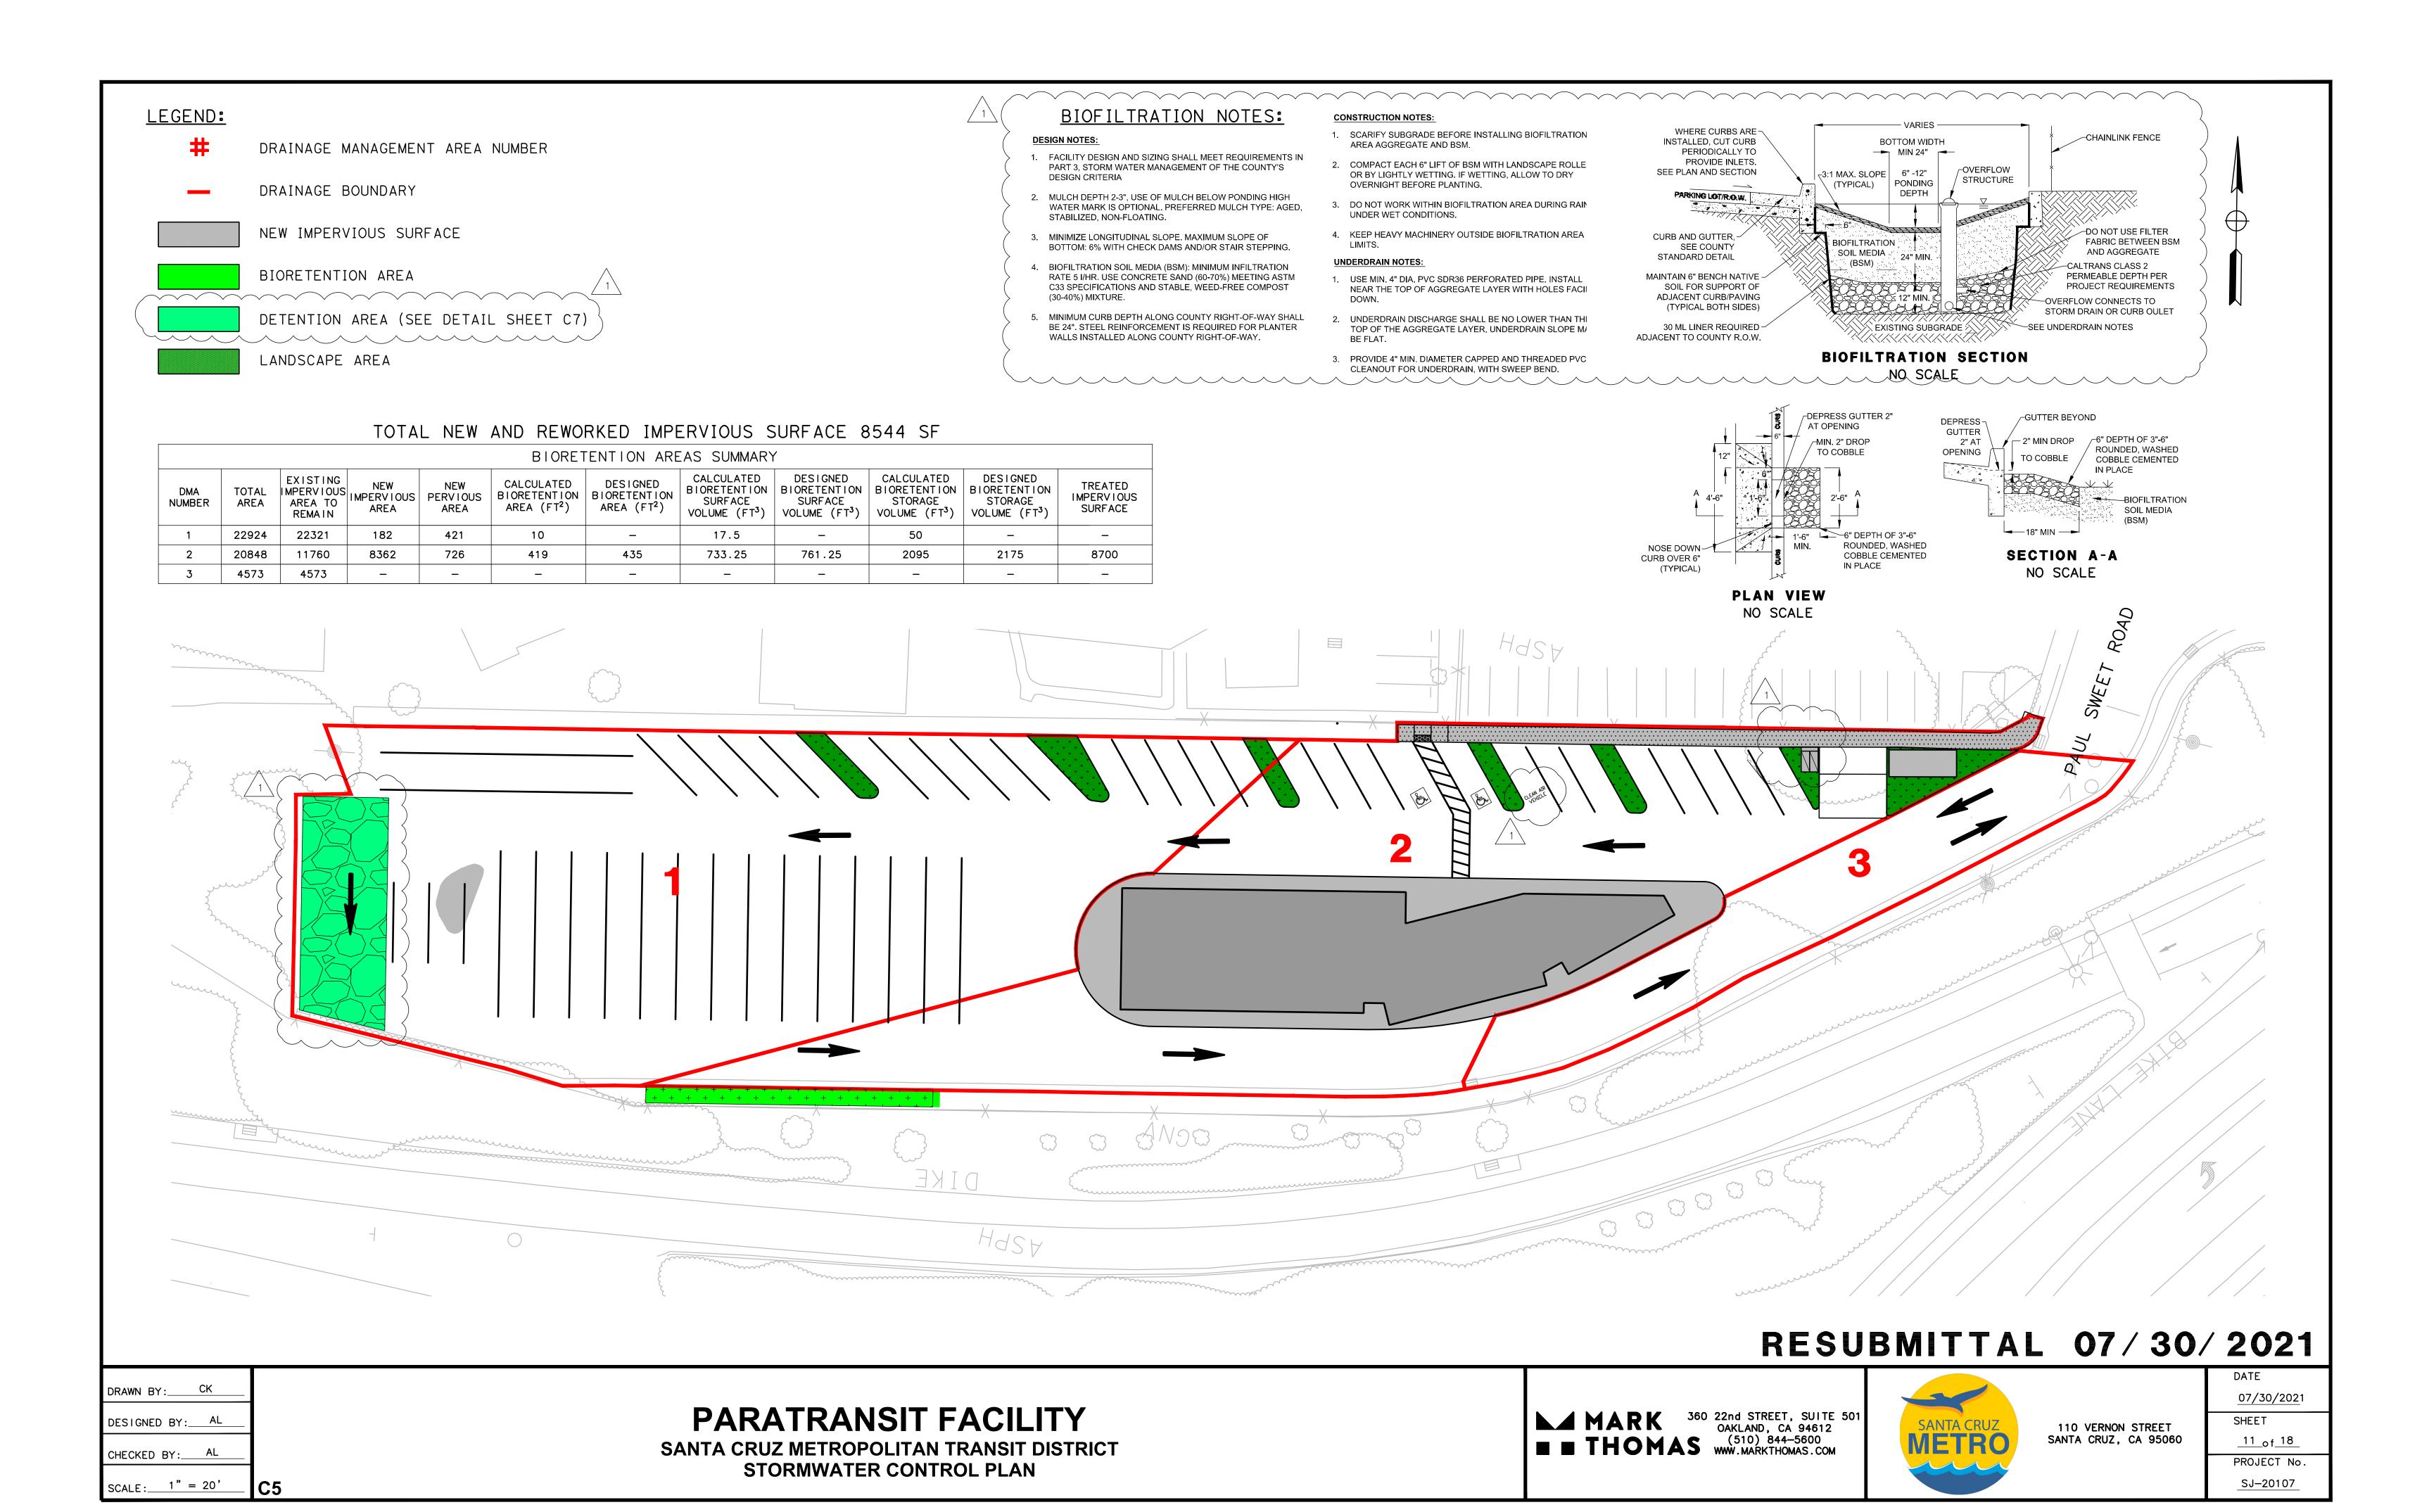

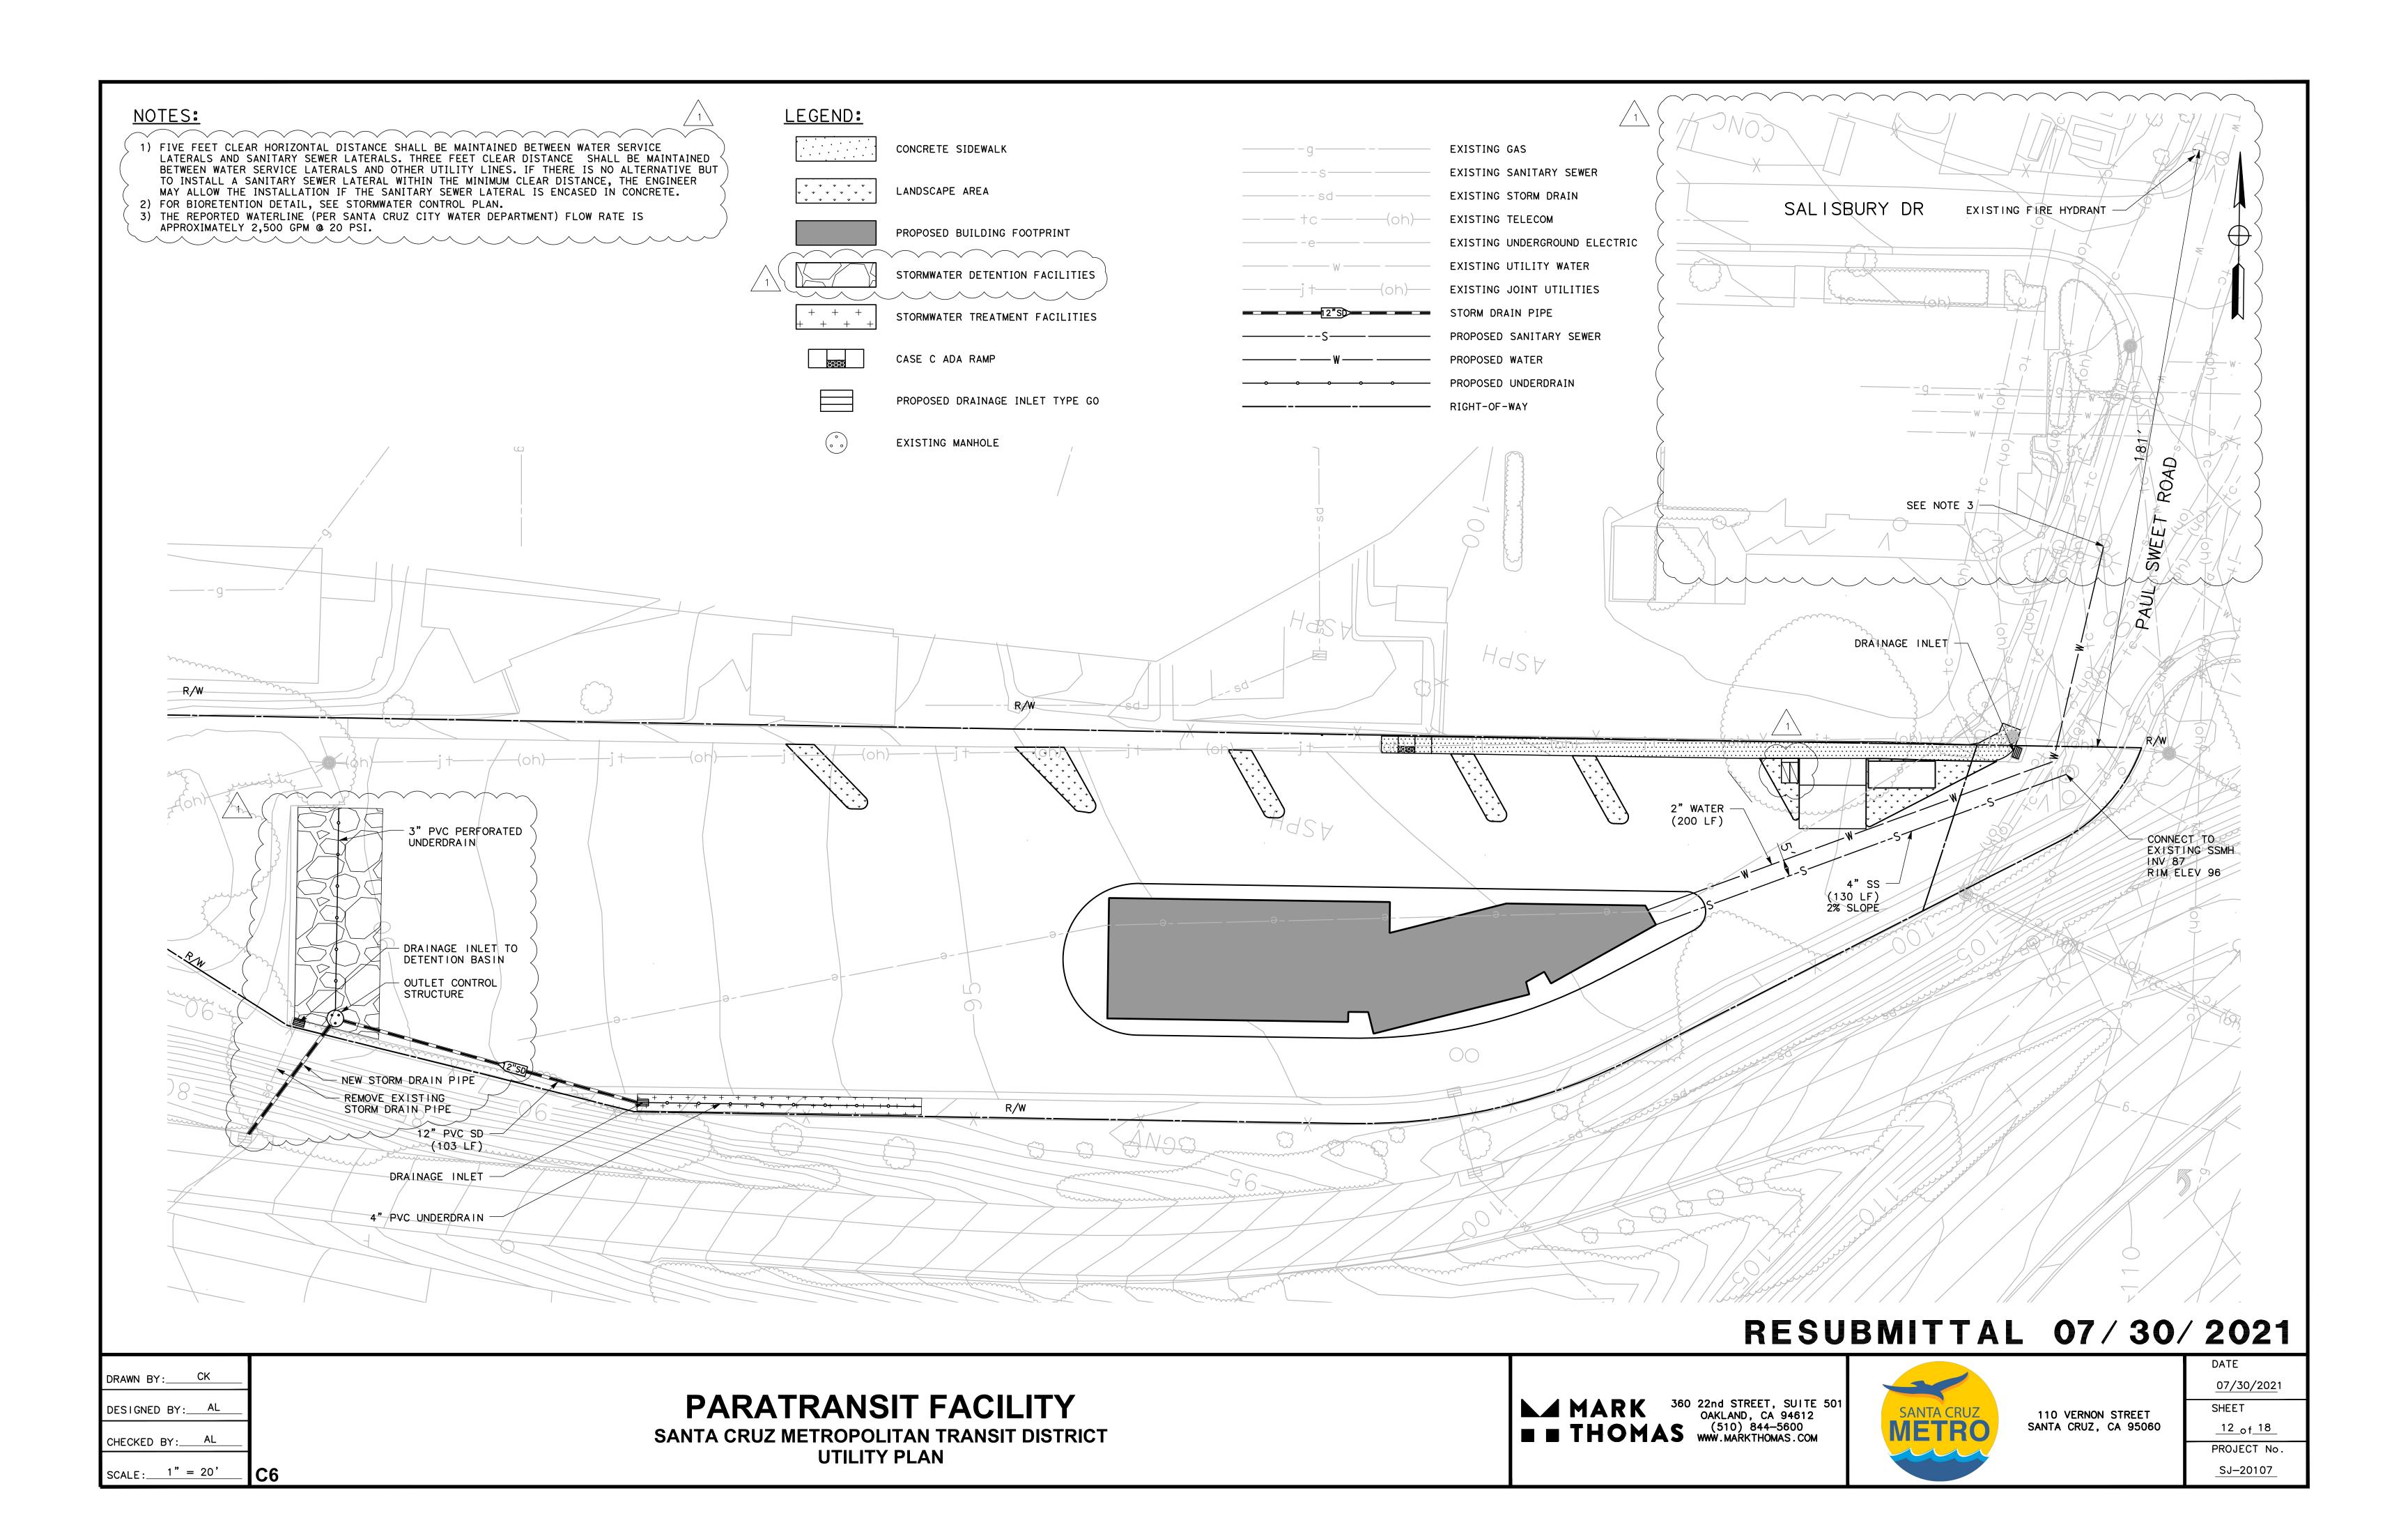

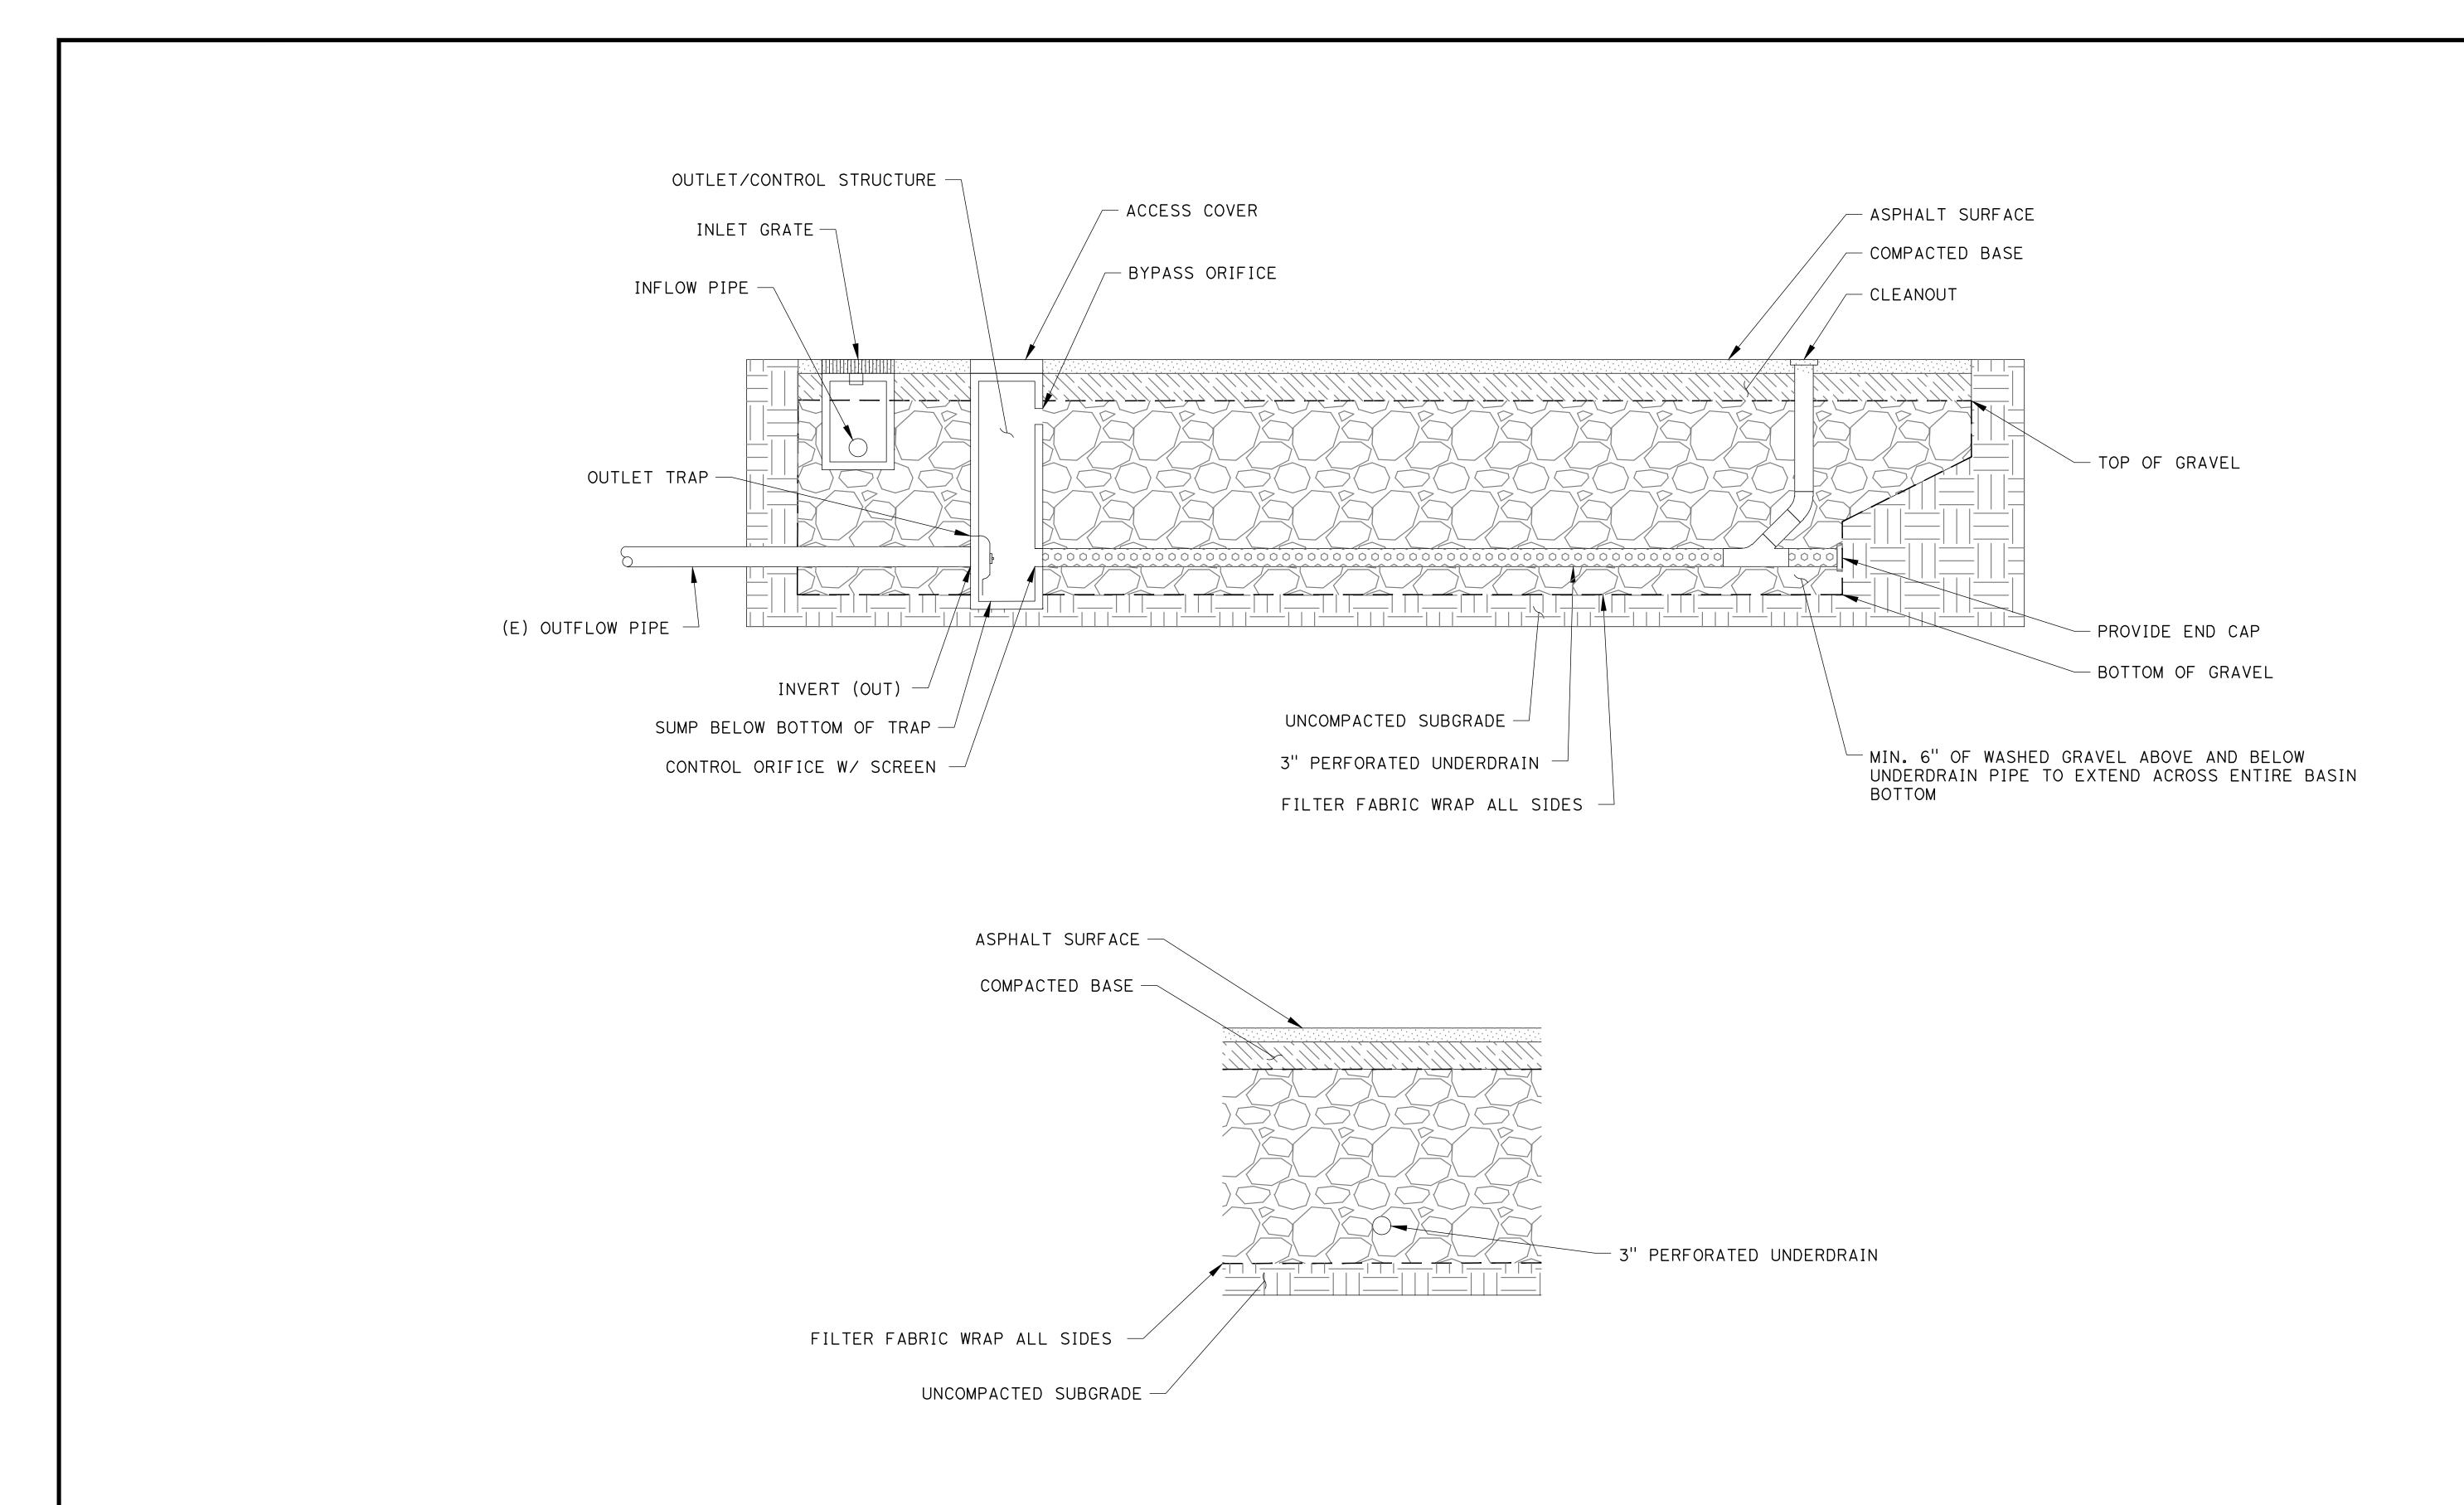

RESUBMITTAL 07/30/2021

DRAWN BY: CK

DESIGNED BY: AL

CHECKED BY: AL

SCALE: 1" = 20'

PARATRANSIT FACILITY


SANTA CRUZ METROPOLITAN TRANSIT DISTRICT DETENTION BASIN DETAIL





110 VERNON STREET SANTA CRUZ, CA 95060

SJ-20107

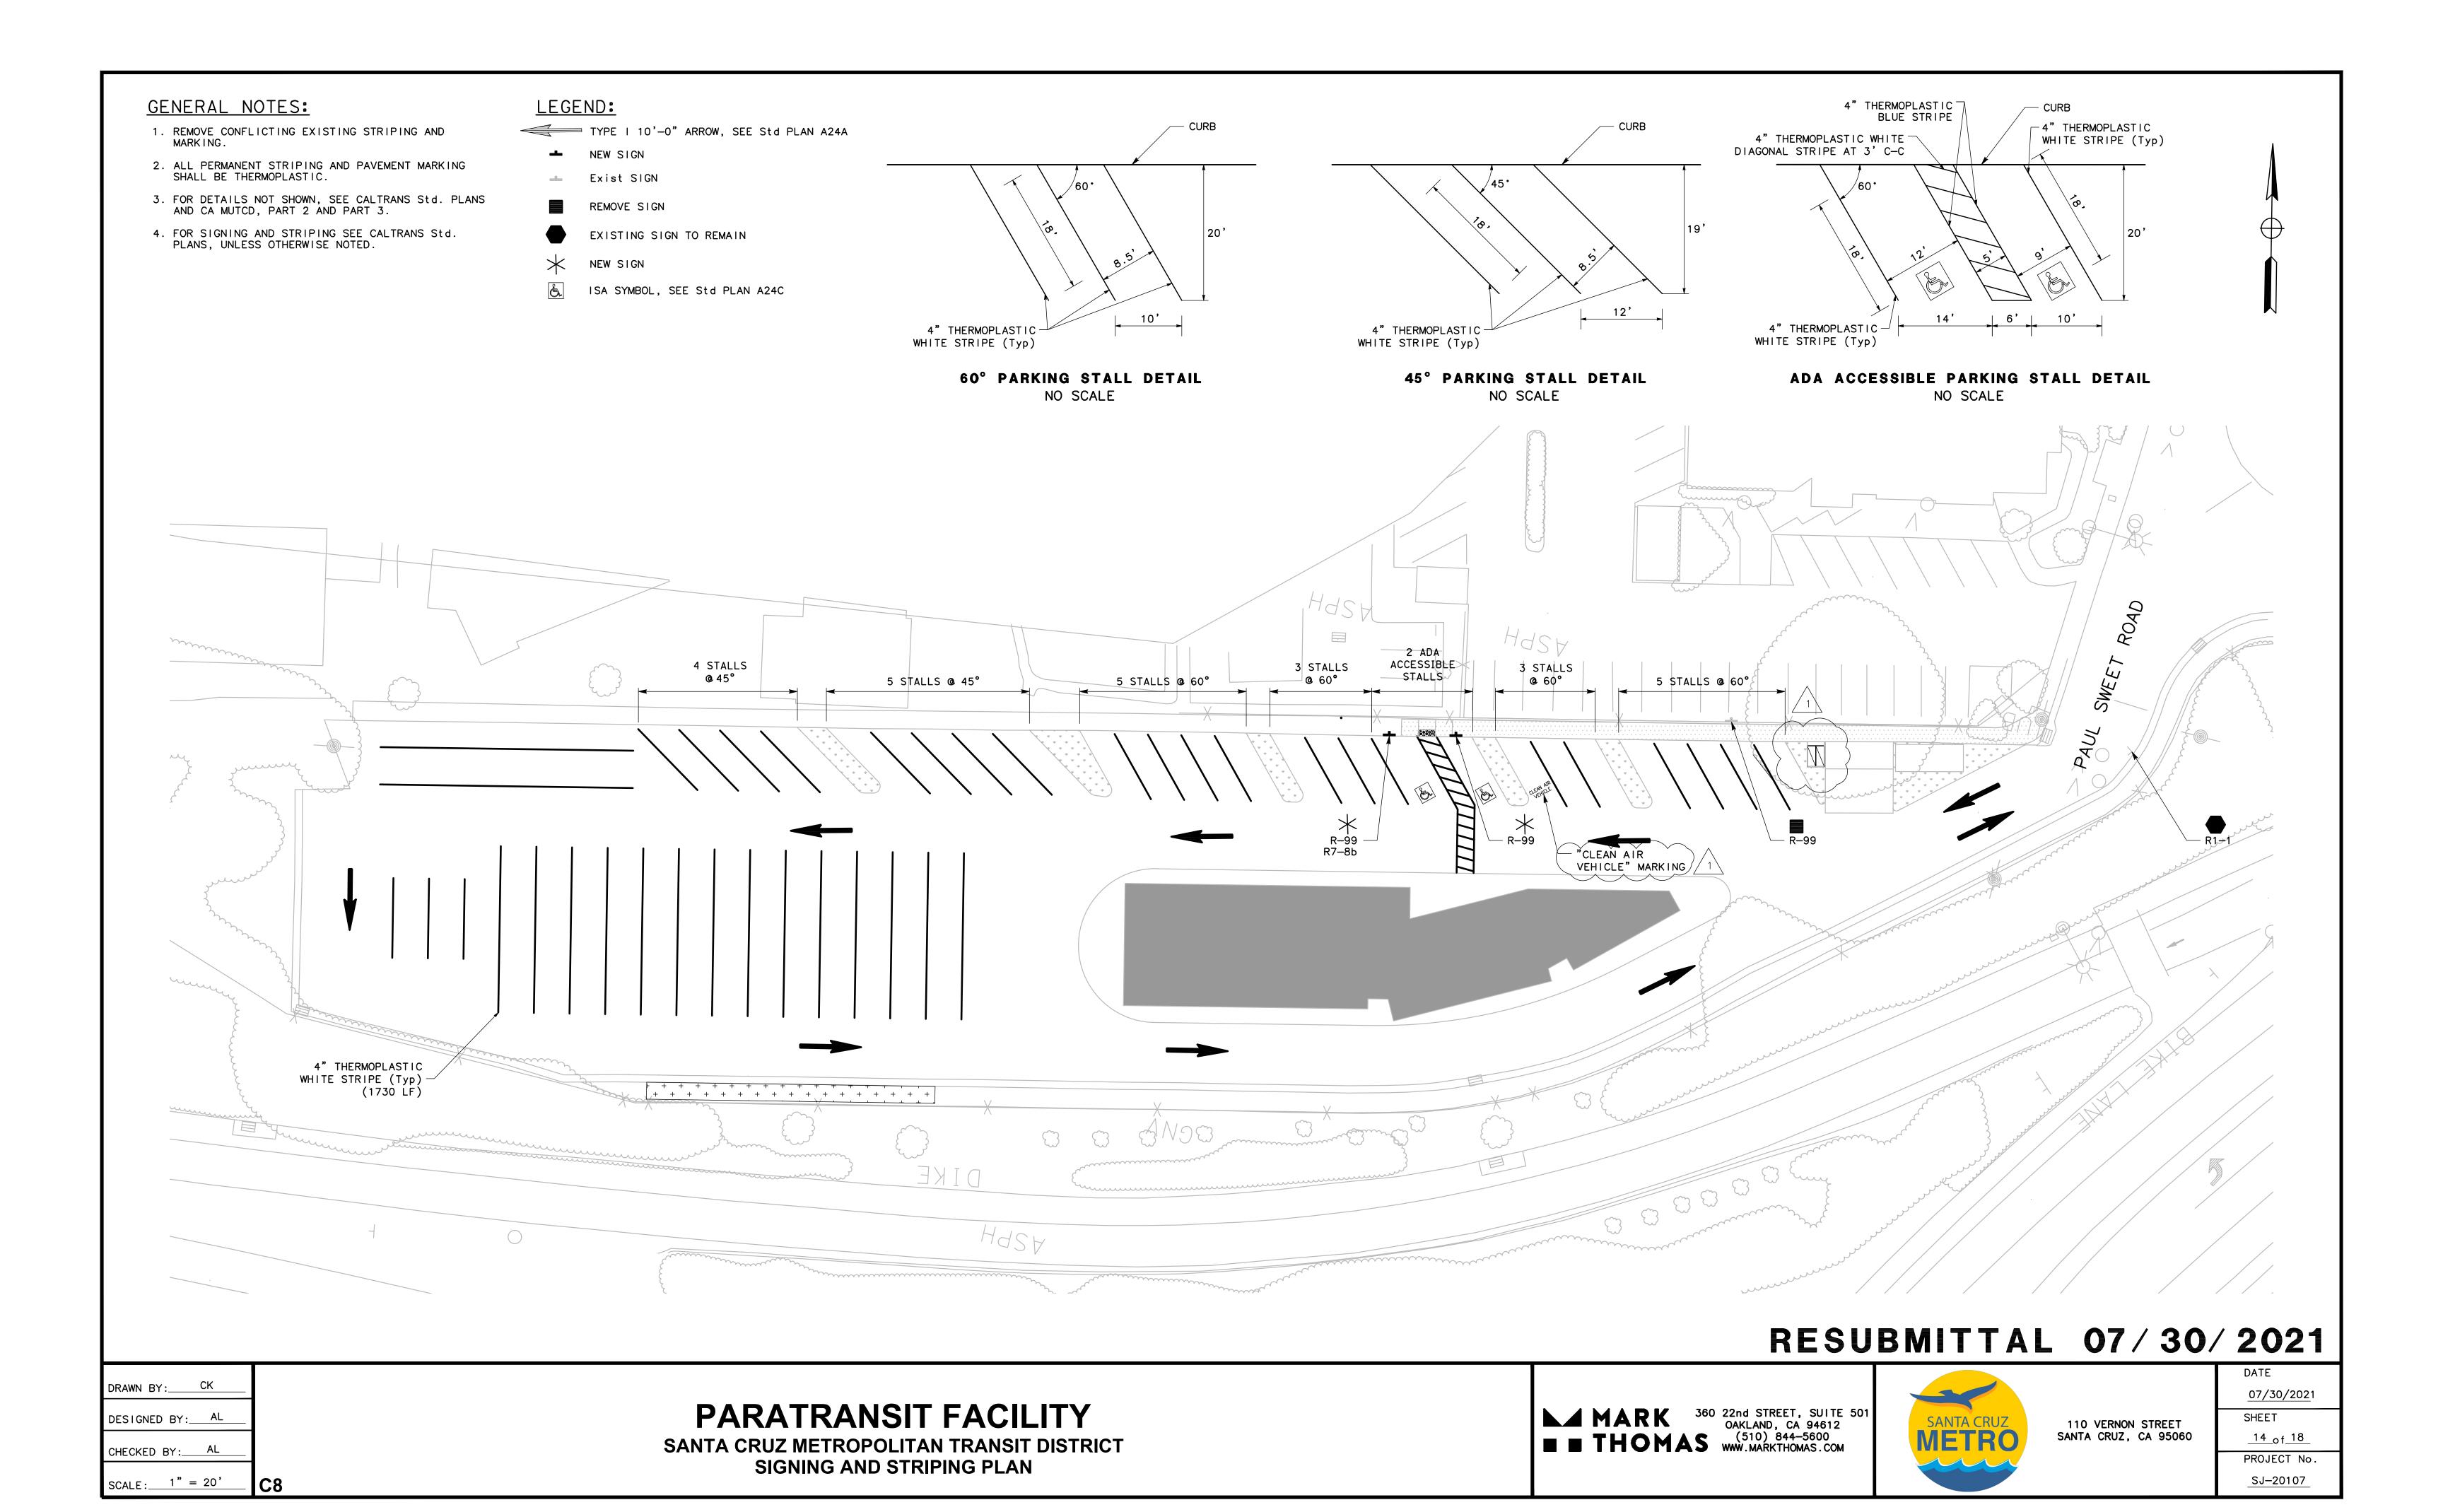



mike@arnonelandscape.com 831.462.4988

Landscape design for:

CD Metro ParaTransit Facility
Paul Sweet Road
Santa Cruz, CA 95065

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Landscape Architect - 2021

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USER'S RESPONSIBILITY WITHOUT LIABILITY TO THE LANDSCAPE ARCHITECT.

OWNER SHALL ASSUME RESPONSIBILITY FOR COMPLIANCE WITH ALL EASEMENTS, SETBACK REQUIREMENTS AND PROPERTY LINES. OWNER SHALL ACQUIRE ALL NECESSARY PERMITS REQUIRED TO PERFORM WORK SHOWN ON PLANS. BASE INFORMATION HAS BEEN PROVIDED BY THE OWNER. MICHAEL ARNONE LANDSCAPE

ARCHITECTURE ASSUMES NO LIABILITY FOR THE ACCURACY OF SAID PROPERTY LINE BOUNDARIES, FENCE LINES OR PROPERTY CORNERS.

ELECTRONIC TRANSFER OF DATA SHALL BE THE

REVISIONS


PRELIMINARY LANDSCAPE

JOB NO. 202105


SCALE as noted DRAWN MA

CHECK JC/MA
DATE 3.1.2021

SHEET L-1.0

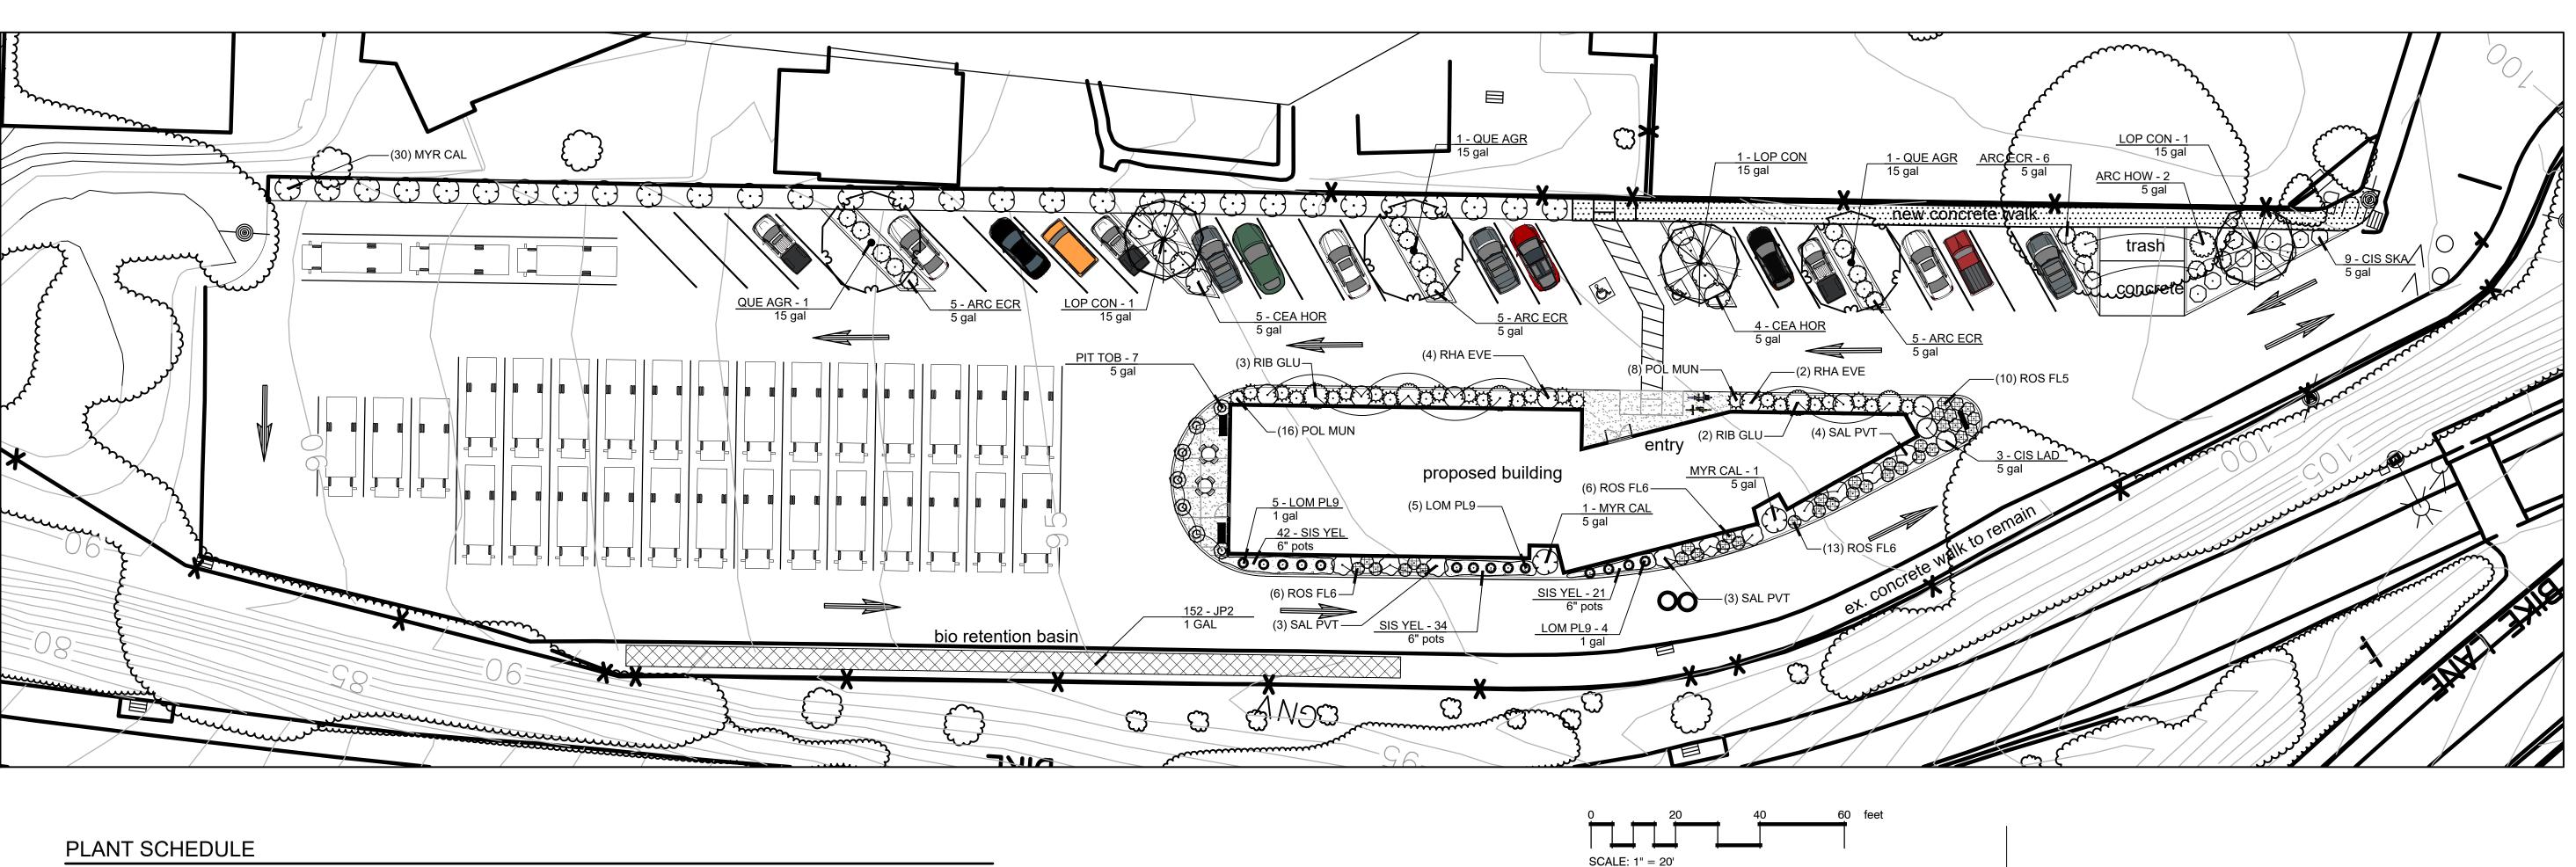

PLANT SCH	IEDULE					
TREES	CODE	BOTANICAL / COMMON NAME	CONT		<u>QTY</u>	CAL NATIVE
	LOP CON	Lophostemon confertus / Brisbane Box	15 gal		3	NO
	QUE AGR	Quercus agrifolia / Coast Live Oak	15 gal		3	YES
SHRUBS	CODE	BOTANICAL / COMMON NAME	CONT		QTY	CAL NATIVE
	ARC HOW	Arctostaphylos densiflora `Howard McMinn` / Howard McMinn Vine Hill Manzanita	5 gal		2	YES
0	ARC ECR	Arctostaphylos edmundsii `Carmel Sur` / Carmel Sur Little Sur Manzanita	5 gal		21	YES
\bigcirc	CEA HOR	Ceanothus griseus horizontalis / Carmel Creeper	5 gal		9	YES
\odot	CIS LAD	Cistus ladanifer / Crimson Spot Rockrose	5 gal		3	YES
\odot	CIS SKA	Cistus x skanbergii / Coral Rockrose	5 gal		9	YES
\odot	MYR CAL	Myrica californica / Pacific Wax Myrtle	5 gal		32	YES
\odot	PIT TOB	Pittosporum tobira / Mock Orange	5 gal		7	NO
***	POL MUN	Polystichum munitum / Western Sword Fern	5 gal		24	YES
\odot	RHA EVE	Rhamnus californica `Eve Case` / California Coffeeberry	5 gal		6	YES
\odot	RIB GLU	Ribes sanguineum glutinosum / Red Flowering Currant	5 gal		5	YES
	ROS FL5	Rosa x `Flower Carpet Red` / Rose	5 gal		10	NO
	ROS FL6	Rosa x `Flower Carpet White` / Rose	5 gal		25	NO
\odot	SAL PVT	Salvia leucantha `Purple Velvet` / Purple Velvet Mexican Bush Sage	5 gal		10	NO
GRASSES	CODE	BOTANICAL / COMMON NAME	CONT		QTY	CAL NATIVE
MANUAL MA	LOM PL9	Lomandra longifolia Platinum Beauty / Variegated Mat Rush	1 gal		14	NO
GROUND COVERS	CODE	BOTANICAL / COMMON NAME	CONT	SPACING	QTY	CAL NATIVE
	JP2	Juncus patens / California Gray Rush	1 GAL	30" o.c.	152	NO
	SIS YEL	Sisyrinchium californicum / Yellow Eyed Grass	6" pots	18" o.c.	97	YES

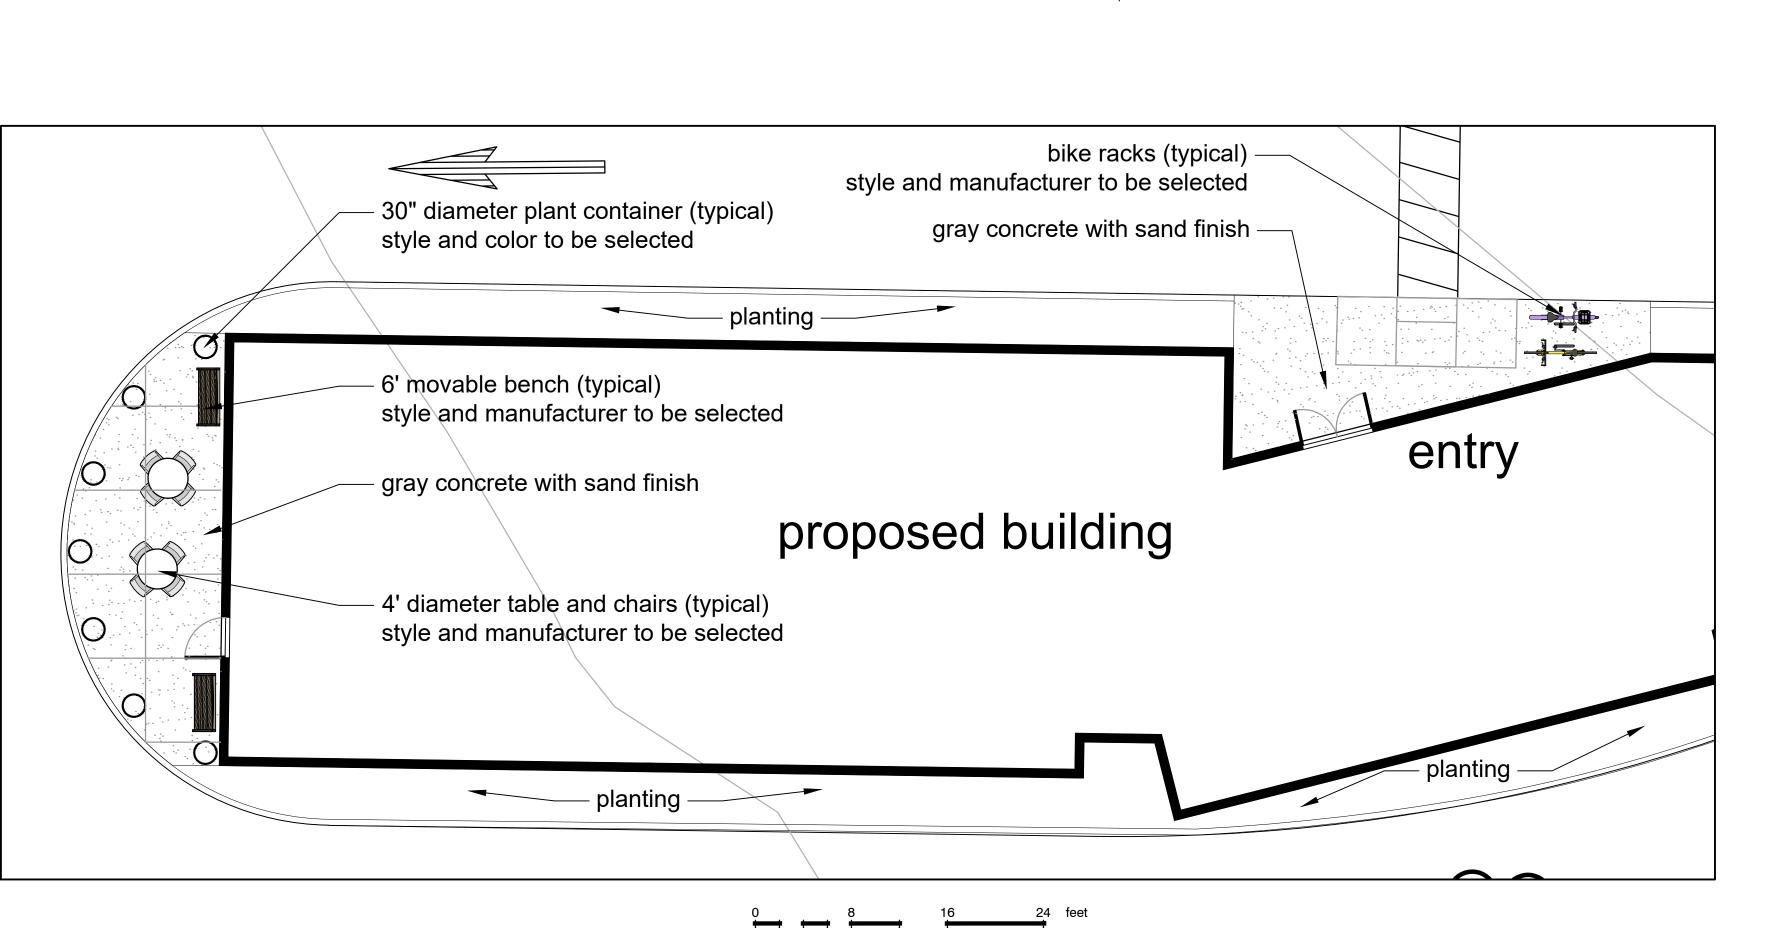







Pittosporum tobira / Mock Orange





Polystichum munitum

Rhamnus californica `Eve Case` California Coffeeberry Western Sword Fern





Rosa x 'Flower Carpet Red'

Red Flower Carpet Rose





Rosa x 'Flower Carpet White' White Flower Carpet Rose

Salvia leucantha `Purple Velvet` Purple Velvet Mexican Bush Sage

OWNER. MICHAEL ARNONE LANDSCAPE
ARCHITECTURE ASSUMES NO LIABILITY FOR THE
ACCURACY OF SAID PROPERTY LINE BOUNDARIES,
FENCE LINES OR PROPERTY CORNERS.

RETENTION BASIN PLANTS



Juncus patens / California Gray Rush

GROUND COVERS

Ribes sanguineum glutinosum

Red Flowering Currant



Sisyrinchium californicum / Yellow Eyed Grass

ORNAMENTAL GRASSES



Lomandra longifolia Platinum Beauty Variegated Mat Rush

PLANT IMAGES

JOB NO. 202105 **SCALE** not to scale

DRAWN MA CHECK JC/MA **DATE** 3.1.2021

SHEET **L-1.1**



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OWNER SHALL ASSUME RESPONSIBILITY FOR COMPLIANCE WITH ALL EASEMENTS, SETBACK REQUIREMENTS AND PROPERTY LINES. OWNER SHALL ACQUIRE ALL NECESSARY PERMITS
REQUIRED TO PERFORM WORK SHOWN ON PLANS.
BASE INFORMATION HAS BEEN PROVIDED BY THE

REVISIONS



LIGHTING SITE PLAN SCALE: 1" = 20' - 0"

SHEET NOTES

NEW POLE MOUNTED LIGHTING FIXTURE. SEE FIXTURE SCHEDULE AND MOUNTING DETAIL.

Approx.			Fixture			Electrical			
Qty.	Туре	Description	Manufacturer / Part #	BUG Rating	Control Method	Driver	Volt.	Watt.	Notes
7		Wet-listed pole-mounted area light with Type 4 distribution - Parking Lot	Fixture: Cree OSQ-A-NM-4ME-B-40K-UL-BZ-OSQBLSMF Mount: Cree OSQ-DA-BZ Accessory: Cree OSQ-DA-BZ, XA-SENSRM, OSQ-BLSMF Pole: LytePole 401-3011-13	B1 U0 G2	PC/TC	Integral	120	86	*Contractor shall provide pole metal parts in matching finish.
5		Wet-listed pole-mounted area light with Type 3 distribution - Parking Lot	Fixture: Cree OSQ-A-NM-3ME-B-40K-UL-BZ-OSQBLSMF Mount: Cree OSQ-DA-BZ Accessory: Cree OSQ-DA-BZ, XA-SENSRM, OSQ-BLSMF Pole: LytePole 401-3011-13	B1 U0 G2	PC/TC	Integral	120	86	*Contractor shall provide pole metal parts in matching finish.

General Notes:

1. Contractor shall provide all parts necessary for a complete, functioning, and finished system. Provide all lighting fixtures as shown complete with all lamps, completely wired, controlled and securely attached to supports. 2. Where both written and pictorial fixture descriptions are provided, the written description shall take precedence and prevail.

3. Contractor shall provide and install fixtures to meet the standards and regulations of Underwriters Laboratories, state building codes, and local Building and Life Safety code agencies, and according to manufacturer

4. All fixtures and workmanship shall be guaranteed free of defects and fully operational for a minimum of one year after the acceptance of the project by the Owner. Any fixtures or workmanship (excluding lamps) found to be

defective during the warranty period will be either fixed or replaced by the Contractor at no cost to the Owner.

5. Fixtures are shown diagrammatically and do not indicate means and methods of installation. Verify exact location and spacing with Architect at the site during installation. Notify Architect about field conditions at variance with Contract Documents before commencing installation.


6. Provide adequate and sturdy support for each lighting fixture. Contractor shall be responsible for verifying weight and mounting method of all fixtures and furnish and install suitable supports. Fixture mounting assemblies shall

comply with all local seismic codes and regulations. 7. At the completion of construction, Contractor shall clean lenses and reflectors of all lighting fixtures so as to render them free of any material, substance or film foreign to the fixture. Blemished, damaged, or unsatisfactory

fixtures shall be replaced at no cost to Owner. 8. Contractor shall replace all burned-out or inoperative lamps, and inoperative ballasts in all fixtures before the building is accepted by the Owner so that all lighting fixtures will be in as-new operating condition.

9. Contractor shall review existing circuiting and verify new loads and panel capacity. Contractor shall notify Architect if a conflict between design documents and field conditions occur. 10. Where dimming control is noted, Contractor shall provide dimming control per manufacturer recommendations, control intent diagrams, and Engineer's direction.


11. Unless otherwise noted, all electrical fittings are to be concealed. Contractor shall notify Architect in writing if any electrical fittings are to be exposed due to field conditions.

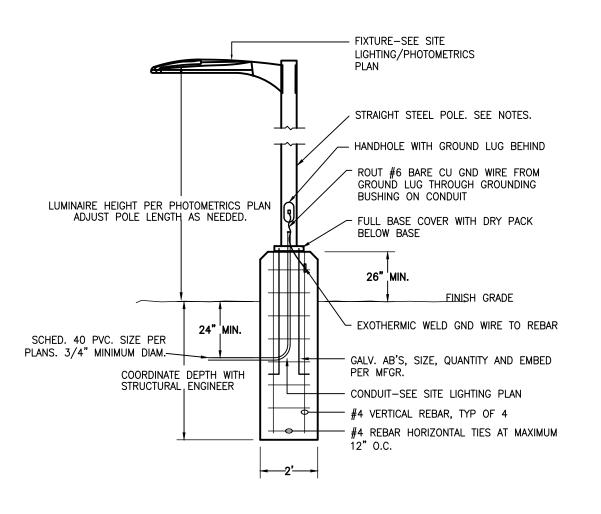

2 PARKING LOT POLE LIGHT DETAIL SCALE: NOT TO SCALE

Revisions lanning Application 03/01/2021

Scale: As Noted

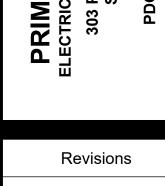

ANTA CRUZ METRO
PARKING LOT
PAULS SWEET ROAD
SANTA CRUZ, CA

31, 40, 40, 44, 13, 25, 31, 60, 53, 40, 73, 70, 30, 12, 12, 14, 12, 13, 10, 10, 10, 10, 10, 10, 10, 10, 10, 10	
08	
22 53 58 52 50 15 04 03 08 31 46 58 46 33 09 04 06 14 22 44 64 33 17 10 04 02 04 08 11 35 63	
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Schedule																	
Symbol	Label	Image	QTY	Manufacturer	Catalog Number	Description	Lamp	Number Lamps	Filename	Lumens per Lamp	Lumen Multiplie r	LLF	Wattage	Efficiency	Distribut ion	Polar Plot	Notes
	A		7	Cree Inc	FROM OSQ-A-xx-4ME-B-	Cree OSQ Series Area Luminaire, Type IV Medium Distribution, B Input Power Designator, 4000K CONFIGURED FROM Cree OSQ Series Area Luminaire, Type IV Medium Distribution, B Input Power Designator, 3000K	CONFIGURED FROM Eight Cree MDA LEDs	1	OSQ-A-XX-4ME- -B-40K- ULXXXXX_CONF IGURED.ies		1	1	86	100%		Max: 8024cd	
	В		5	Cree Inc		Cree OSQ Series Area Luminaire, Type III Medium Distribution, B Input Power Designator, 4000K CONFIGURED FROM Cree OSQ Series Area Luminaire, Type III Medium Distribution, B Input Power Designator, 3000K	CONFIGURED FROM Eight Cree MDA LEDs	1	OSQ-A-XX-3ME- -B-40K- ULXXXXX_CONF IGURED.ies	11425	1	1	86	100%		Max: 7198cd	

Statistics						
Description	Symbol	Avg	Min	Max/Min	Avg/Min	Max
Calc Zone #3	+	2.1 fc	0.1 fc	152.0:1	21.0:1	15.2 fc

Scale: As Noted