

### **Staff Report to the Planning Commission**

Application Number: 201354

**Applicant:** Noll & Tam Architects **Agenda Date:** July 14, 2021

 Owner:
 County of Santa Cruz
 Agenda Item #: 8

 APN:
 027-241-06 & 027-251-12
 Time: After 9:30 a.m.

Site Address: 979 17th Avenue, Santa Cruz

**Project Description**: Proposal to construct a library annex at the Simpkins Swim Center.

**Location**: Property is located approximately 300 feet south of the intersection of 17th Avenue and

Kinsley Street in the Live Oak planning area. (979 17th Ave)

**Permits Required**: Commercial Development Permit, Coastal Development Permit

Supervisorial District: 1st District (District Supervisor: Manu Koenig)

### **Staff Recommendation:**

- Determine that the proposal is exempt from further Environmental Review under the California Environmental Quality Act.
- Approval of Application 201354, based on the attached findings and conditions.

### **Project Background**

The Simpkins Swim Center was approved under development permit numbers 93-0602, 94-0450, and 95-0384. The swim center provides recreational swimming opportunities and a community center for the Live Oak area. This application requires approval of a Master Site Plan Amendment for the Simpkins Swim Center.

### **Project Description & Setting**

The current application is to construct an addition to the existing Simpkins Swim Center that would include an annex for the Live Oak Library and a new entrance to the Simpkins Swim Center. The existing swim center building is approximately 20,000 square feet in floor area. A total of approximately 2,000 square feet of new floor area is proposed in the first phase. The lobby and interior of the swim center would be remodeled to create space for the library annex and associated activities. A second phase would include the construction of a childcare space (approximately 545 square feet) at the rear of the building.

The subject property is located off of 17th Avenue in the Live Oak planning area. The property is

County of Santa Cruz Planning Department 701 Ocean Street, 4th Floor, Santa Cruz CA 95060

located behind the Shoreline Middle School and is accessed off of a driveway to 17th Avenue that is shared with the Boys and Girls Club. The property is bordered on the side by the railroad tracks and Schwan Lake park (a component of Twin Lakes State Beach) to the rear.

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### **Zoning & General Plan Consistency**

The subject property is located in the PR (Parks, Recreation and Open Space) zone district, a designation which allows recreational uses. The existing public recreation facility is a permitted use within the zone district and the zoning is consistent with the site's O-R (Parks, Recreation and Open Space) General Plan designation.

### **Master Site Plan**

The proposed library annex would be added to the existing recreation facility and community center as part of the Simpkins Swim Center facilities. Community centers and public facilities are allowed uses within the zone district and the proposed use would be consistent with the existing public facilities and community use of the site. The existing swim center was approved with a Master Site Plan and the current proposal is considered as an amendment to the existing Master Site Plan approval. The proposed library annex will be a compatible public use that is consistent with the prior approvals for the swim center as a community facility.

Grading of approximately 570 cubic yards (cut) and 420 cubic yards (fill) is proposed to prepare the site for the project. The existing circular driveway is proposed to be modified to remove the circular component and seven adjacent parking spaces to accommodate the proposed addition and hardscape improvements at the new front entry to the swim center building. Adequate parking will remain in the main parking area, with sufficient parking for the swim center, library annex, administrative offices, and the adjacent Schwan Lake trails.

A total of eleven trees are proposed for removal due to their location in the construction area. The trees proposed for removal are all relatively young and none are large enough to be considered as significant trees per County regulations. A landscape plan has been provided with eight replacement trees, vegetation, and hardscape designed to complement the proposed addition to the swim center building.

### **Design Review**

The proposed addition and remodel of an existing public facility complies with the requirements of the County Design Review Ordinance, in that the proposed project is designed in a manner to match the existing architectural style of the swim center building. The project design will also be compatible with the architecture of surrounding public and community facilities, including the adjacent Boys and Girls Club and the Shoreline Middle School.

### **Local Coastal Program Consistency**

The proposed modifications to an existing public facility and addition of a library annex to the existing swim center is in conformance with the County's certified Local Coastal Program, in that the proposed addition is designed to be visually compatible and in scale with the existing improvements on the property and the structures in the surrounding area.

The project site is located between the shoreline and the first public road with public beach access at Twin Lakes State Beach. The subject property is identified as a priority site in the County's Local Coastal Program and the site has been acquired for public use as specified in Local Coastal Program Policy 2.23.2 and Figure 2-5. The proposed addition and library annex will not interfere with the existing swim center use or public access to the adjacent Schwan Lake area of Twin Lakes State Beach. Consequently, the proposed project will not interfere with public access to the beach, ocean, or other nearby body of water.

### **Public Outreach/Public Comment**

In addition to preliminary meetings and public discussion by the Board of Supervisors to approve the concept for a Live Oak Library Annex in 2017, four community meetings were held through 2018 and 2019 to solicit input regarding the proposed project. A summary of the community meetings that were held is included in Exhibit G of this report.

### **Conclusion**

As proposed and conditioned, the project is consistent with all applicable codes and policies of the Zoning Ordinance and General Plan/LCP. Please see Exhibit "B" ("Findings") for a complete listing of findings and evidence related to the above discussion.

### **Staff Recommendation**

- Determine that the proposal is exempt from further Environmental Review under the California Environmental Quality Act.
- APPROVAL of Application Number 201354, based on the attached findings and conditions.

Supplementary reports and information referred to in this report are on file and available for viewing at the Santa Cruz County Planning Department, and are hereby made a part of the administrative record for the proposed project.

The County Code and General Plan, as well as hearing agendas and additional information are available online at: www.sccoplanning.com

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APN: 027-241-06 & 027-251-12 Owner: County of Santa Cruz

Report Prepared By:

Randall Adams

Santa Cruz County Planning Department

701 Ocean Street, 4th Floor Santa Cruz CA 95060

Phone Number: (831) 454-3218

E-mail: randall.adams@santacruzcounty.us

Report Reviewed By: \_\_\_\_

Jocelyn Drake
Principal Planner
Development Review

Santa Cruz County Planning Department

### **Exhibits**

- A. Categorical Exemption (CEQA determination)
- B. Findings
- C. Conditions
- D. Project plans
- E. Assessor's, Location, Zoning and General Plan Maps
- F. Parcel information
- G. Comments & Correspondence

APN: 027-241-06 & 027-251-12 Owner: County of Santa Cruz

### CALIFORNIA ENVIRONMENTAL QUALITY ACT NOTICE OF EXEMPTION

The Santa Cruz County Planning Department has reviewed the project described below and has determined that it is exempt from the provisions of CEQA as specified in Sections 15061 - 15332 of CEQA for the reason(s) which have been specified in this document.

Assessor Parc	Tumber: 201354 el Number: 027-241-06 & 027-251-12 on: 979 17th Avenue, Santa Cruz
Project Desci	ription: Construct a library annex and new entry at the Simpkins Swin Center
Person or Ag	ency Proposing Project: Noll & Tam Architects
Contact Phoi	ne Number: 510-542-2200
A B C D	The proposed activity is not a project under CEQA Guidelines Section 15378. The proposed activity is not subject to CEQA as specified under CEQA Guidelines Section 15060 (c).  Ministerial Project involving only the use of fixed standards or objective measurements without personal judgment.  Statutory Exemption other than a Ministerial Project (CEQA Guidelines Section 15260 to 15285).
E. <u>X</u>	Categorical Exemption
Specify type:	Class 1 - Existing Facilities (Section 15301)
F. Reaso	ns why the project is exempt:
	of an addition to an existing public facility in an area designated for public recreation ity facilities uses, located within the urban services line with all urban services
In addition, no	one of the conditions described in Section 15300.2 apply to this project.
	Date:
Randall Adan	ns, Project Planner

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### **Coastal Development Permit Findings**

1. That the project is a use allowed in one of the basic zone districts that are listed in LCP Section 13.10.170(D) as consistent with the LCP Land Use Plan designation of the site.

This finding can be made, in that the property is zoned PR (Parks, Recreation and Open Space), a designation which allows recreation and public facilities uses. The proposed addition to an existing public facility is a permitted use within the zone district, and the zoning is consistent with the site's O-R (Parks, Recreation and Open Space) General Plan designation.

2. That the project does not conflict with any existing easement or development restrictions such as public access, utility, or open space easements.

This finding can be made, in that no such easements or restrictions are known to encumber the project site. Access to the open space and trails at Schwan Lake will continue to be available at the rear of the property.

3. That the project is consistent with the design criteria and special use standards and conditions of this chapter pursuant to SCCC 13.20.130 and 13.20.140 et seq.

This finding can be made, in that the proposed project is designed in a manner to match the existing architectural style of the swim center building. The project design will also be compatible with the architecture of surrounding public and community facilities, including the adjacent Boys and Girls Club and the Shoreline Middle School.

4. That the project conforms with the public access, recreation, and visitor-serving policies, standards and maps of the LCP Land Use Plan, including Chapter 2: Section 2.5 and Chapter 7.

This finding can be made, in that the project site is identified as a priority acquisition site in the County Local Coastal Program which has been developed for recreation and community park facilities uses as directed in LCP Policy 2.23.2 and Figure 2.5 of the General Plan/Local Coastal Program land use plan. The current proposal is consistent with the existing community facilities use of the property. Access to the open space and trails at Schwan Lake will continue to be available at the rear of the property and beach access is available at Twin Lakes State Beach.

5. That the project conforms to all other applicable standards of the certified LCP.

This finding can be made, in that the proposed addition is sited and designed to be visually compatible and integrated with the character of the surrounding facilities. Additionally, public recreation facilities uses are allowed uses in the PR (Parks, Recreation and Open Space) zone district, as well as the General Plan and Local Coastal Program land use designation.

6. If the project is located between the nearest through public road and the sea or the shoreline of any body of water located within the Coastal Zone, that the project conforms to the public access and public recreation policies of Chapter 3 of the Coastal Act.

This finding can be made, in that the project site is not located between the shoreline and the first public road. Access to the open space and trails at Schwan Lake will continue to be available at the rear of the property and beach access is available at Twin Lakes State Beach. Consequently, the addition to the existing public facility will not interfere with public access to the beach, ocean, or any nearby body of water.

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Owner: County of Santa Cruz

### **Development Permit Findings**

1. That the proposed location of the project and the conditions under which it would be operated or maintained will not be detrimental to the health, safety, or welfare of persons residing or working in the neighborhood or the general public, and will not result in inefficient or wasteful use of energy, and will not be materially injurious to properties or improvements in the vicinity.

This finding can be made, in that the project is located in an area designated for recreation and public facilities uses. Construction will comply with prevailing building technology, the California Building Code, and the County Building ordinance to ensure the optimum in safety and the conservation of energy and resources.

2. That the proposed location of the project and the conditions under which it would be operated or maintained will be consistent with all pertinent County ordinances and the purpose of the zone district in which the site is located.

This finding can be made, in that the proposed addition of a library annex to the existing swim center facility and the conditions under which it would be operated or maintained will be consistent with all pertinent County ordinances and the purpose of the PR (Parks, Recreation and Open Space) zone district. Community centers and public facilities, such as the proposed library annex, are allowed uses within the PR zone district, and the primary use of the property will continue to be a public recreation facility.

This proposal is consistent with County Code section 13.10.355 in regard to the requirement for a Master Site Plan approval. The prior approvals for the Simpkins Swim Center included a Master Site Plan approval and the current proposal is an amendment to the prior Master Site Plan for the subject property. The existing and proposed uses will be compatible, the design of the proposed addition is consistent with the architectural style of the existing building, and adequate access and public services are available to serve the facility.

3. That the proposed use is consistent with all elements of the County General Plan and with any specific plan which has been adopted for the area.

This finding can be made, in that the existing public recreation facility use is consistent with the use and density requirements specified for the O-R (Parks, Recreation and Open Space) land use designation in the County General Plan.

The proposed project is consistent with General Plan Policy 7.3.4, in that the proposed library annex creates the opportunity for educational and cultural programs to be combined with existing public recreation facilities as part of a community complex located at the Simpkins Swim Center.

The subject property is listed as a priority acquisition site in the General Plan (Policy 2.23.2 and Figure 2.5) which reserves the property for a swim center and access to the adjacent trails and open space. The current proposal is consistent with the existing swim center and community facilities use of the property. Access to the open space and trails at Schwan Lake will continue to be available at the rear of the property.

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A specific plan has not been adopted for this portion of the County.

4. That the proposed use will not overload utilities, and will not generate more than the acceptable level of traffic on the streets in the vicinity.

This finding can be made, in that the proposed addition will be part of an existing public facility with adequate vehicular access. The expected level of traffic generated by the proposed project is anticipated to be approximately 92 additional vehicle trips per day, such an increase will not adversely impact existing roads or intersections in the surrounding area. All utilities are available to serve the proposed project.

5. That the proposed project will complement and harmonize with the existing and proposed land uses in the vicinity and will be compatible with the physical design aspects, land use intensities, and dwelling unit densities of the neighborhood.

This finding can be made, in that the proposed addition is sited and designed to be visually compatible and integrated with the character of the surrounding facilities, and the existing swim center facility is consistent with the land use intensity and uses in the surrounding neighborhood.

6. The proposed development project is consistent with the Design Standards and Guidelines (sections 13.11.070 through 13.11.076), and any other applicable requirements of this chapter.

This finding can be made, in that the proposed project is designed in a manner to match the existing architectural style of the swim center building. The project design will also be compatible with the architecture of surrounding public and community facilities, including the adjacent Boys and Girls Club and the Shoreline Middle School.

### **Conditions of Approval**

Exhibit D: Project plans, prepared by Noll and Tam Architects, dated 1/22/21.

- I. This permit authorizes the construction of an addition to the Simpkins Swim Center, for the Live Oak Library Annex and associated activities, as indicated on the approved Exhibit "D" for this permit as an amendment to the Master Site Plan. This permit is an amendment to Coastal Development Permit and Master Site Plan approvals 93-0602, 94-0450 & 95-0384 and all required conditions of approval for those permits are hereby incorporated into these conditions of approval by reference. Prior to exercising any rights granted by this permit including, without limitation, any construction or site disturbance, the applicant/owner shall:
  - A. Sign, date, and return to the Planning Department one copy of the approval to indicate acceptance and agreement with the conditions thereof.
  - B. Obtain a Building Permit from the Santa Cruz County Building Official.
    - 1. Any outstanding balance due to the Planning Department must be paid prior to making a Building Permit application. Applications for Building Permits will not be accepted or processed while there is an outstanding balance due.
  - C. Obtain a Grading Permit from the Santa Cruz County Building Official.
- II. Prior to issuance of a Building Permit the applicant/owner shall:
  - A. Submit final architectural plans for review and approval by the Planning Department. The final plans shall be in substantial compliance with the plans marked Exhibit "D" on file with the Planning Department. Any changes from the approved Exhibit "D" for this development permit on the plans submitted for the Building Permit must be clearly called out and labeled by standard architectural methods to indicate such changes. Any changes that are not properly called out and labeled will not be authorized by any Building Permit that is issued for the proposed development. The final plans shall include the following additional information:
    - 1. A copy of the text of these conditions of approval incorporated into the full size sheets of the architectural plan set.
    - 2. One elevation shall indicate materials and colors as they were approved by this Discretionary Application. If specific materials and colors have not been approved with this Discretionary Application, in addition to showing the materials and colors on the elevation, the applicant shall supply a color and material sheet in 8 1/2" x 11" format for Planning Department review and approval.
    - 3. Grading, drainage, and erosion control plans.
    - 4. Details showing compliance with fire department requirements.

- B. Meet all requirements of and pay Zone 5 drainage fees to the County Department of Public Works, Stormwater Management. Drainage fees will be assessed on the net increase in impervious area.
- C. Meet all requirements of the Santa Cruz County Sanitation District.
- D. Meet all requirements of the Environmental Planning section of the Planning Department.
- E. Meet all requirements and pay any applicable plan check fee of the Central Fire Protection District.
- F. Submit 3 copies of plan review letters prepared and stamped by the project Geotechnical Engineer.
- G. Pay the current fees for Roadside and Transportation improvements for 92 additional daily trips. Currently, these fees are, respectively, \$300 and \$300 per additional daily trip.
- III. All construction shall be performed according to the approved plans for the Building Permit. Prior to final building inspection, the applicant/owner must meet the following conditions:
  - A. All site improvements shown on the final approved Building Permit plans shall be installed.
  - B. All inspections required by the building permit shall be completed to the satisfaction of the County Building Official.
  - C. The project must comply with all recommendations of the approved soils reports.
  - D. Pursuant to Sections 16.40.040 and 16.42.080 of the County Code, if at any time during site preparation, excavation, or other ground disturbance associated with this development, any artifact or other evidence of an historic archaeological resource or a Native American cultural site is discovered, the responsible persons shall immediately cease and desist from all further site excavation and notify the Sheriff-Coroner if the discovery contains human remains, or the Planning Director if the discovery contains no human remains. The procedures established in Sections 16.40.040 and 16.42.080, shall be observed.

### IV. Operational Conditions

- A. Master Site Plan: The proposed library annex and associated uses are authorized as an amendment to the Master Site Plan approved for the Simpkins Swim Center.
  - 1. The review of the design and construction of the childcare area proposed in the second phase of this project may be processed ministerially as a

Building Permit. The architectural style and design of the childcare area shall be consistent with the design and style of the Simpkins Swim Center building.

- 2. Future site and facility development permits, when applied for pursuant to the approved master site plan, may be processed as a Level IV review.
- B. In the event that future County inspections of the subject property disclose noncompliance with any Conditions of this approval or any violation of the County Code, the owner shall pay to the County the full cost of such County inspections, including any follow-up inspections and/or necessary enforcement actions, up to and including permit revocation.

### V. Indemnification

The applicant/owner shall indemnify, defend with counsel approved by the COUNTY, and hold harmless the COUNTY, its officers, employees, and agents from and against any claim (including reasonable attorney's fees, expert fees, and all other costs and fees of litigation), against the COUNTY, its officers, employees, and agents arising out of or in connection to this development approval or any subsequent amendment of this development approval which is requested by the applicant/owner, regardless of the COUNTY's passive negligence, but excepting such loss or damage which is caused by the sole active negligence or willful misconduct of the COUNTY. Should the COUNTY in its sole discretion find the applicant's/owner's legal counsel unacceptable, then the applicant/owner shall reimburse the COUNTY its costs of defense, including without limitation reasonable attorney's fees, expert fees, and all other costs and fees of litigation. The applicant/owner shall promptly pay any final judgment rendered against the COUNTY (and its officers, employees, and agents) covered by this indemnity obligation. It is expressly understood and agreed that the foregoing provisions are intended to be as broad and inclusive as is permitted by the law of the State of California and will survive termination of this development approval.

- A. The COUNTY shall promptly notify the applicant/owner of any claim, action, or proceeding against which the COUNTY seeks to be defended, indemnified, or held harmless. The COUNTY shall cooperate fully in such defense.
- B. Nothing contained herein shall prohibit the COUNTY from participating in the defense of any claim, action, or proceeding if both of the following occur:
  - 1. COUNTY bears its own attorney's fees and costs; and
  - 2. COUNTY defends the action in good faith.
- C. <u>Settlement</u>. The applicant/owner shall not be required to pay or perform any settlement unless such applicant/owner has approved the settlement. When representing the COUNTY, the applicant/owner shall not enter into any stipulation or settlement modifying or affecting the interpretation or validity of any of the terms or conditions of the development approval without the prior written consent of the COUNTY.

D. <u>Successors Bound</u>. The "applicant/owner" shall include the applicant and/or the owner and the successor'(s) in interest, transferee(s), and assign(s) of the applicant and/or the owner.

Minor variations to this permit which do not affect the overall concept or density may be approved by the Planning Director at the request of the applicant or staff in accordance with Chapter 18.10 of the County Code.

Please note: This permit expires three years from the effective date listed below unless a building permit is obtained for the first phase of the project consisting of one of the primary structures described in the development permit (does not include demolition, temporary power pole or other site preparation permits, or accessory structures unless these are the primary subject of the development permit). Failure to exercise the building permit and to complete all of the construction under the building permit, resulting in the expiration of the building permit, will void the development permit, unless there are special circumstances as determined by the Planning Director.

Approval Date:	
Effective Date:	
Expiration Date:	

Appeals: Any property owner, or other person aggrieved, or any other person whose interests are adversely affected by any act or determination of the Planning Commission, may appeal the act or determination to the Board of Supervisors in accordance with chapter 18.10 of the Santa Cruz County Code.

### SHEET INDEX

GENERAL G0.00 COVER SHEET G1.32 PLUMBING COUNT

ARCHITECTURE A0.01 ABBREVIATIONS/SYMBOLS A1.01 SITE DEMOLITION/REMOVAL

DIMENSI ELOOR PLAN SECOND FLOOR PLAN SECOND FLOOR PLAN SECOND FLOOR

GRADING PLAN: BUILDING AND PARKING SITE CIVIL NOTES, LEGEND AND ABBREVIATIONS EXISTING CONDITIONS PLAN
DEMOLITION PLAN
HORIZONTAL CONTROL AND C1.00 25 52 52 8 8 8 8

STORMWATER DETAILS CONSTRUCTION DETAILS EROSION CONTROL PLAN TY PLAN RMWATER CONTROL

**APN 02724** 

LANDSCAPE ENLARGEMENT

L3.01 PLANTING LIST AND IMAGES LANDSCAPE MATERIALS

201354

# Live Oak Library

# Annex

NOHODAHSNOO

II. WAR


729 Heinz Avenue Berkeley, CA 94710 tel 510.542.2200 fax 510.542.2201

**ARCHITECTS** 

979 17th Avenue, Santa Cruz, CA 95062

Santa Cruz Public Libraries DEVELOPMENT PERMIT RESUBMITTAL - 1/22/2021

**APPROVALS** 

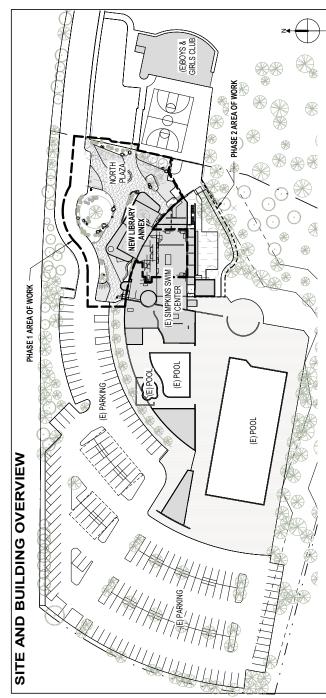

# PROJECT SUMMARY PHASE 1

**LOCAL STREET MAP** 

Annex

**Live Oak Library** 

Santa Cruz Public

Libraries

THE PROJECT IS AN NEW LIBRARY ANNEX BUILDING (APPROX. 2,000 SF) AND AN INTERIOR RENOVATION OF THE EXSTING SIMPKINS SWIM AND COMMUNITY CENTER BUILDING FOR A NEW LOBBY, RECEPTION, AND CHILDREN'S SMEA OF THE ANNIEX. THE EXISTING COMMUNITY ROOM ALSO RECEVES LIMITED NITERIOR IMPROVEMENTS. THE WORK ALSO INCLUDES NEW SITE IMPROVEMENTS AND REMOVAL OF EXISTING PARKING SPACES FOR NEW OUTDOOR SPACES.

THE PROJECT SCOPE INCLUDES, BUT IS NOT LIMITED TO, MODIFICATIONS TO: EXTERIOR AND INTERIOR WALLS, EXTERIOR CUSTOM SHADING DEVICES, DOORS, INTERIOR GLAZING, CELLINGS, AND FINISHES, COMPLIANCE WITH CURRENT LIFE SAFETY CODES, AND MODIFICATION TO BUILDING SYSTEMS (HVAC, ELECTRICAL, LIGHTING, TELECOMMUNICATIONS, AUDION/ISUAL, AND PLUMBING).

FIRE SPRINKLER AT LIBRARY ANNEX SHALL BE DESIGNIBUILD. THE EXISTING BUILDING IS FIRE SPRINKLERED.

APN 02724106

**DEVELOPMENT PERMIT** 

RESUBMITTAL

DESCRIPTION

#\ DATE

979 17th Avenue, Santa Cruz, CA 95062

CONTRACTOR WILL BE RESPONSIBLE FOR PREPPING ALL AREAS FOR NEW SCOPE OF WORK INCLUDING PATCHING AND REPAIRING EXISTING CONDITIONS WHERE AFFECTED BY ANY AND ALL DEMOLITION WORK.

THE WORK TO BE PERFORMED UNDER THIS CONTRACT INCLUDES THE FURNISHING OF ALL LABOR, MATERIALS, EQUIPMENT, TRANSPORTATION, SERVICES, PTRANPORARY CONTROLS AND CONSTUCTION ACQUIRED AND CONTROLS AND CONTROLS AND CONTROLS. SEISMIC REQUIREMENTS, SENSER, REQUIREMENTS, SAND INCIDENTALS, REQUIRED TO COMPLETE THE WORK ON THE PROJECT IN ITS ENTIRETY AS DESCRIBED IN THE CONTRACT DOCUMENTS.

# PROJECT SUMMARY PHASE 2

THE PROJECT IS THE ADDITION OF A NEW CHILDCARE SPACE (APPROX.550 SF) AND THE DEVELOPMENT OF ASSOCIATED EXTERIOR SPACES TO THE SOUTH OF THE EXISTING SWIM CENTER.

DRAWN BY Author CHECKED BY Checker SHEET TITLE

**COVER SHEET** 

Pacific Crest Engineering, Inc. 444 Airport Blvd, Suite 106 Watsonville, CA 95076 Tel: 831-722-9446 Geotechnical

111 Pine Street Suite 1315 San Francisco CA 94112 Tel: (415) 981-9430 TBD Consultants Inc.

Cost Estimator

Syska Hennessy Group 425 California St. Ste. 400 San Francisco CA 94104 Tel: (415) 288-9060

Landscape IDA Structural Engineers Inc. 1630 Telegraph Avenue Suite 300 Oakland CA 94612-2114 Tel: (510) 834-1629 Structural

Joni L. Janecki & Associates 515 Swift St. Santa Cruz, CA 95060 Tel: (831) 423-6041

**BKF Engineers**255 Shoreline Drive Suite 200
Redwood City CA 94065
Tel: (650) 482-6300

Architect

729 Heinz Ave Berkeley, CA 94710 Tel: 510.542.2200 Fax: 510.542.2201

Noll & Tam Architects

Client
County of Santa Cruz - Dept of
Public Works
701 Ocean St, 4th Fir
Santa Cruz, CA 95050
Tel: 831,454,2393

00.05 SHEET NUMBER

PLUMBING OCCUPANCY TYPE

729 Heinz Avenue Berkeley, CA 94710 tel 510.542.2200 fax 510.542.2201



WOLLOW CONSTRUCTION CONSTRUCTIO

TABLE A GCUPANCY LOAD GROUP         OCCUPANT OCCUPAN	ARE4	AREA SCHEDULE - PLUMBING CALCULATIONS FOR SHEET	G CALCU	LATIONS FOR SHE	ET
4990   30   EDUCATION - DAYCARE   461   50   5451	TABLE A OCCUPANCY GROUP	_	Area	OCCUPANT LOAD FACTOR	OCCUPANT S
4990   30   100					
EDUCATION - DAYCARE   461   50   1   1   1   1   1   1   1   1   1	A-3		4990	30	168
5451	ш	EDUCATION - DAYCARE	461	90	10
	Grand total		5451		178

MEN: 90 WOMEN: 90

PER TABLE 422.1 MINIMUM PLUMBING FACILITIES
WATER CLOSETS: 1 MALE, 3 FEMALE RECDC < 1 MALE, 4 FEMALE PROVIDED (EXISTING)
LAVATORIES: 1 MALE, 1 FEMALE RECDC < 2 MALE, 2 FEMALE PROVIDED (EXISTING)
URINALS: 1 RECDC < 3 PROVIDED (EXISTING)
DRINKING FOUNTAIN: 1 RECDC = 1 PROVIDED (EXISTING)

NO CHANGE TO USE, AREA OR OCCUPANCY AT SECOND LEVEL. EXISTING BATHROOMS SERVING UPPER FLOOR TO REMAIN.

Santa Cruz Public Libraries Live Oak Library Annex

PROJECT TITLE

**APPROVALS** 

DEVELOPMENT PERMIT
RESUBMITTAL
ISSUE DATE 11222021
NRT JOB NUMBER 21894


DESCRIPTION

REVISIONS

| DATE |

APN 02724106

979 17th Avenue, Santa Cruz, CA 95062

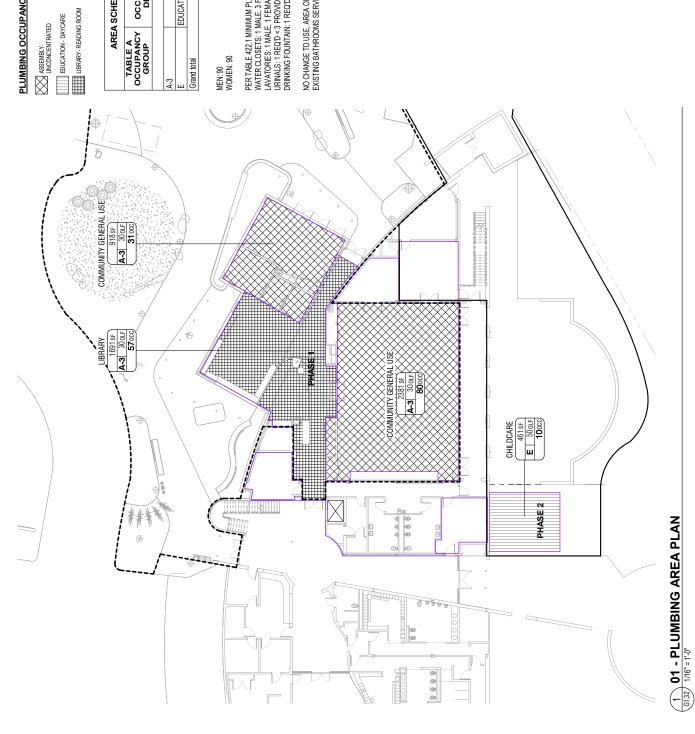

729 Heinz Avenue Berkeley, CA 94710 tel 510.542.2200 fax 510.542.2201

il Ward 4: 4" 3: 3 5/8" 2: 1 5/8" --: Match (E)

		APPROVALS		
CASEWORK TAG — NUMBER (WOOD INSTITUTE # OR OTHER)	— Material / Finish — Depth — Height	— МППН	CURB TAG	— TYPE IDENTIFICATION

PROJECT TITLE

**EQUIPMENT TAG** 

=

DIRECTION OF SHEET NORTH

WORK POINT (PLAN)

**+** ELEVATION

DATUM LEVEL

NORTH ARROW

DIRECTION OF TRUE NORTH

PROPERTY LINE

Santa Cruz Public

Annex **Live Oak Library** Libraries

979 17th Avenue, Santa Cruz, CA 95062

UNLESS OTHERWISE NOTED

URINAL

TOW TOW TYP UON UR VCT VCT VERT VEST

SIMILAR SEE LANDSCAPE DRAWINGS SEE MECHANICAL DRAWINGS

TOP OF STEEL TOP OF WALL TUBE STEEL

SPRAY-APPLIED FIRE RESISTIVE MATERIAL

PORTLAND CEMENT PLASTER

90

LOCKER

GENERAL CONTRACTOR GROUND FAULT INTERRUPT

GRAB BAR

ELEVATION/ELEVATOR ENLARGED

EDGE OF SLAB ELECTRICAL PANEL

EQUAL EQUIPMENT

GALVANIZED IRON GLASS/GLAZING GLUE LAMINATED

**ABBREVIATIONS** 

PLATE PLASTIC LAMINATE

SINGLEHUNG

SHEATHING

VINYL COMPOSITION TILE
VENTILATION
VERTICAL
VESTIBULE

VERIFY IN FIELD WEST / WIDTH / WIDE

SANDWICH PANEL ASSEMBLY SEE PLUMBING DRAWINGS

POLYVINYLCHLORIDE QUANTITY RISER

SLAB ON GRADE

POINT/PRESSURE TREATED

PAINTED

GALVANIZED SHEET METAL GYPSUM WALL BOARD

ELECTRIC WATER COOLER EXHAUST

HIGH / HEIGHT HOSE BIB HOLLOW CORE

GYPSUM

EXPANSION
EXTERIOR
FIRE ALARM
FLOOR DRAIN

CONCRETE MASONRY UNIT
COUNTER
CLEAN OUT
COCUÚN
COCUCÍN
CONORETE
CONNECTO
CONTRUCUS
CONTRUCUS
CONTRUCUS

PROJECT/PROJECTOR

PLYWOOD

PLASTIC

WITHOUT WATER CLOSET

0//

APN 02724106

**DEVELOPMENT PERMIT** 

21804 RESUBMITTAL N&T JOB NUMBER ISSUE DATE

DESCRIPTION REVISIONS

WOOD
WATER HEATER
WINDOW
WHERE OCCURS
WORK POINT
WATER RESISTANT

SEE TELECOM DRAWINGS

STRUCTURAL SUSPENDED SYSTEM

RAIN WATER LEADER

SOUTH

ROUGH OPENING

REVISION

HEATING VENTILATION & AIR CONDITIONING

HEIGHT

보 보 A

FLOORING FIXTURE

DEPTH
DOUBLE
DEMOLITION
DEPARTMENT
DOUGAS FREDRINKING
FOUNTAIN
DOUBLE HUNG
DIAMETER
DIMENSION

HARDWOOD HOLLOW METAL HORIZONTAL

FINISH FLOOR

ABOVE FINISHED FLOOR
AGGREGATE
ALTERNATE
ALUMINUM
ANODIZED
APPROXIMATE
AUDIO VISUAL

AFF
AGG
ALT
ALUM
AUUM
ANOD
APPROX

HARDWARE

HEADER

FIRE EXTINGUISHER FIRE EXTINGUISHER CABINET FIRE HOSE CABINET

-OUNDATION

ARCHITECTURAL EXPOSED STRUCTURAL STEEL

ACOUSTICAL ACOUSTIC CEIILING TILE AREA DRAIN ADDITIONAL ADJACENT/ADJUSTABLE

ANCHOR BOLT ASPHALTIC CONCRETE

INSIDE DIAMETER

FLUORESCENT
FACE OF CONCRETE
FACE OF FINISH
FACE OF STUD
FIRE RESISTANT/FIRE
RETARDANT

BOARD BUILDING BLOCK BLOCKING BEAM BOTTOM OF BUILT UP ROOF CABINET

INSIDE FACE
INCANDESCENT
INCLUDE/INCLUDING
INSULATION
INTERIOR
JANITOR

JUNCTION BOX

IF INC INSUL JAN JST JST JST LAW LAW LAW

FIRE RETARDANT TREATED FIBERGLASS SANDWICH PANEL FOOT/FEET

FIBERGLASS REINFORCED PANEL

STORAGE

STL STOR STRUC SUSP SYS

STAINLESS STEEL STANDARD

SERVICE SINK

RADIUS
ROOF DRAIN
REFREEWGE
REFREGRATOR
REGISTER
REINFORCEREINFORCING
REQUIRED
REQUIREMENTS
RESULENT

SEE STRUCTURAL DRAWINGS SEE SIGNAGE DRAWINGS

STAINLESS STEEL

SQUARE

SPECIFICATION

DRAWN BY Author CHECKED BY Checker SHEET TITLE ABBREVIATIONS / SYMBOLS

SHEET NUMBER

TOP OF CONCRETE/CURB TOP OF PAVING

SECTION SEE ELECTRICAL DRAWINGS SUPPLY FAN

SOLID CORE
SEE CIVIL DRAWINGS
SCHEDULE
STRUCTURAL ENGINEER

OPP OPP HD PA PARTN

Laminate Lavatory Lag Bolt Linear Feet

FIXED GAUGE GALVANIZED

FOOTING FURNITURE

CEMENT/CEMENTITIOUS CARRIAGE BOLT CIVIL ENGINEER

TONGUE & GROOVE
TO BE DETERMINED
TELEPHONE
TEMPERED
THICKTHICKNESS
THRESHOLD
TRUSS JOIST

T T&G TBD TEL TEMP THK

SELF ADHERING SHEET MEMBRANE SELF ADHERING SHEET FLASHING

_ ×	LIGHT	P. P. AM
ATL S	MATERIAL	PLAS
ΑX	MAXIMUM	ΡĽΥ
В	MACHINE BOLT	æ
ECH	MECHANICAL	PROJ
ы	METAL	Ы
Œ	MANUFACTURER	PTD
Ŧ	MANHOLE	PVC
Z	MINIMUM	QTY
ISC	MISCELLANEOUS	<u>~</u>
₽	MOUNTED	RAD
≓	METAL	8
⊣	MULLION	REF
	NORTH	REFR
⋖	NOT APPLICABLE	REG
೦	NOT IN CONTRACT	REINF
0	NUMBER	REQD
MO	NOMINAL	REQT
TS	NOT TO SCALE	RES
∢	OVERALL	REV
ပ	ON CENTER	RM
8	OCCUPANT	8
_	OUTSIDE DIAMETER/OVERFLOW	RWL
	DRAIN	S
ш	OUTSIDE FACE	SASF
짇	OWNER FURNISHED	
6	CONTRACTOR INSTALLED	SASM
2	OVERFLOW DRAIN	
£	OFFICE	သွ
<u>а</u>	OPERABLE	SCD
PNG	OPENING	SCHED
Ь	OPPOSITE	띯
HH	OPPOSITE HAND	SEC
_	PUBLIC ADDRESS	SED
ARTN	PARTITION	R

15

SITE DEMOLITION /
REMOVAL PLAN

SHEET NUMBER

DRAWN BY Author CHECKED BY Checker SHEET TITLE

REVISIONS

A DATE

DEVELOPMENT PERMIT
RESUBMITTAL
ISSUE DATE 11222021
NRT JOB NUMBER 21894

APN 02724106

979 17th Avenue, Santa Cruz, CA 95062

Santa Cruz Public Libraries Live Oak Library Annex

PROJECT TITLE

**APPROVALS** 

NOLL

TAM

ARCHITECTS

729 Heinz Avenue Berkeley, CA 94710 tel 510.542.2200 fax 510.542.2201

II. WARD


RECONFIGURATION OF EXISTING TRAFFIC CIRCLE
REMOVE PORTION OF EXISTING WALL, AS INDICATED KEYNOTE LEGEND

Key Value

02-02

Nortonatisnos BOYS & GIRLS CLUB TO 17TH AVE. SIMPKINS SWIM CENTER (E) POOL (E) POOL (E) POOL (E) PARKING (E) LOCKERS

(1) 00 - SITE PLAN (DEMO)

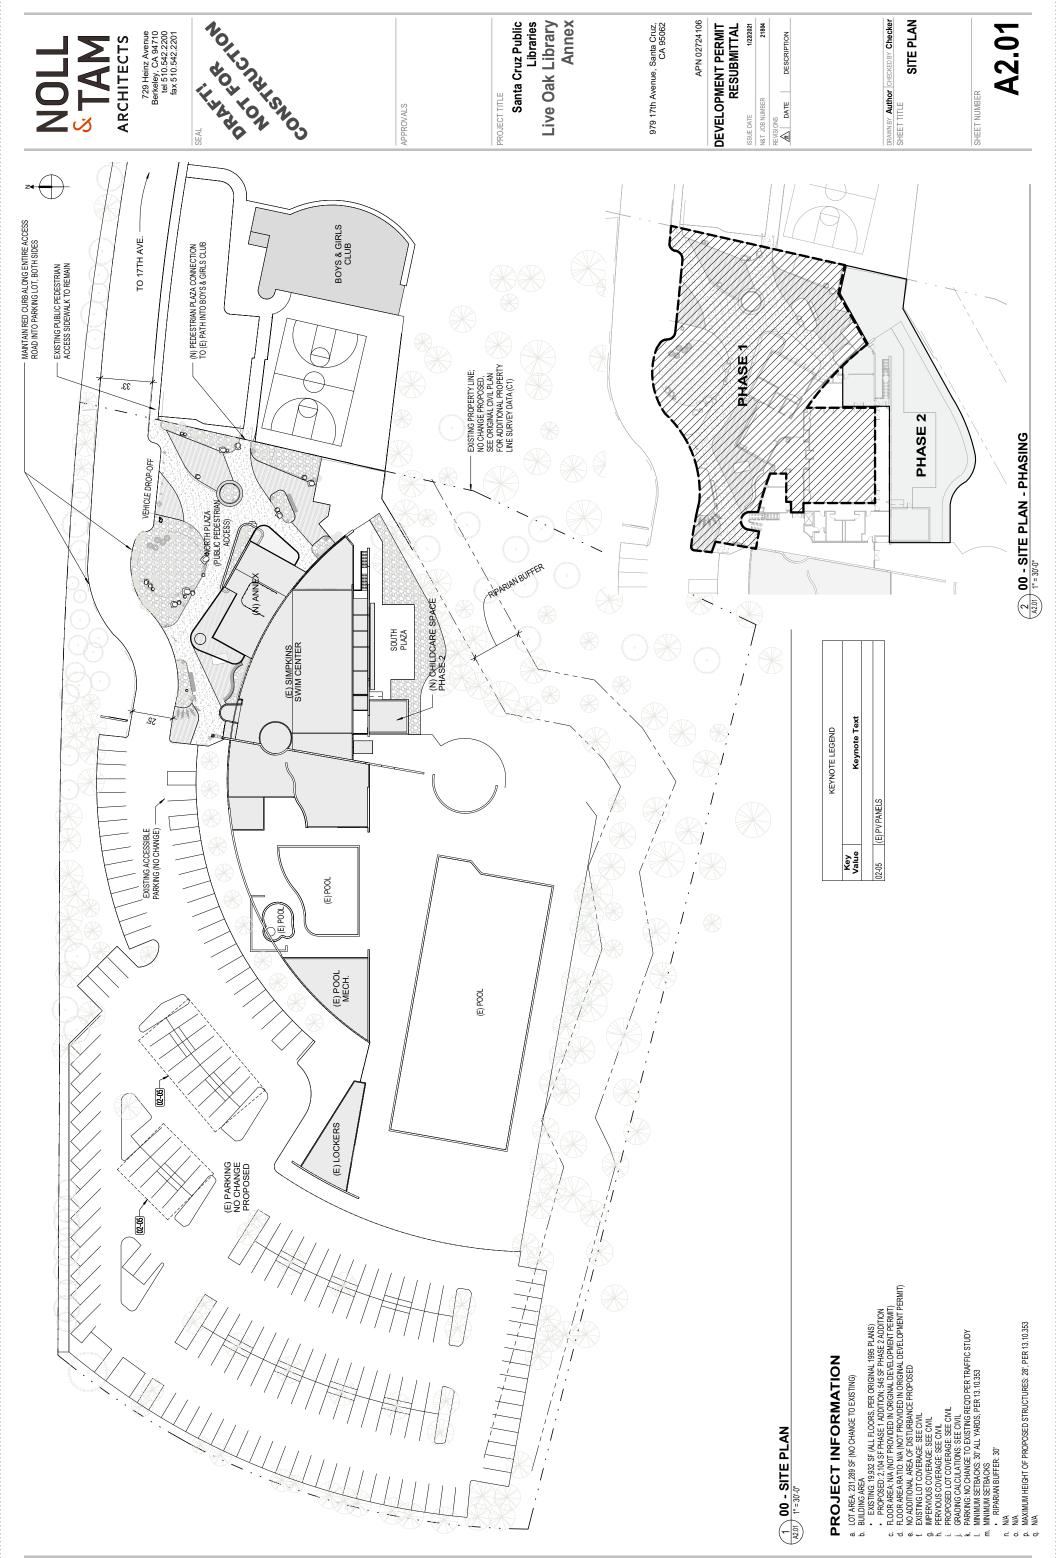

Santa Cruz Public Libraries Live Oak Library Annex 979 17th Avenue, Santa Cruz, CA 95062 APN 02724106

DEVELOPMENT PERMIT
RESUBMITTAL
ISSUE DATE 11222021
NRT JOB NUMBER 21894


DESCRIPTION REVISIONS

| DATE |

DRAWN BY Author CHECKED BY Checker SHEET TITLE

PROPOSED STRUCTURES

SHEET NUMBER

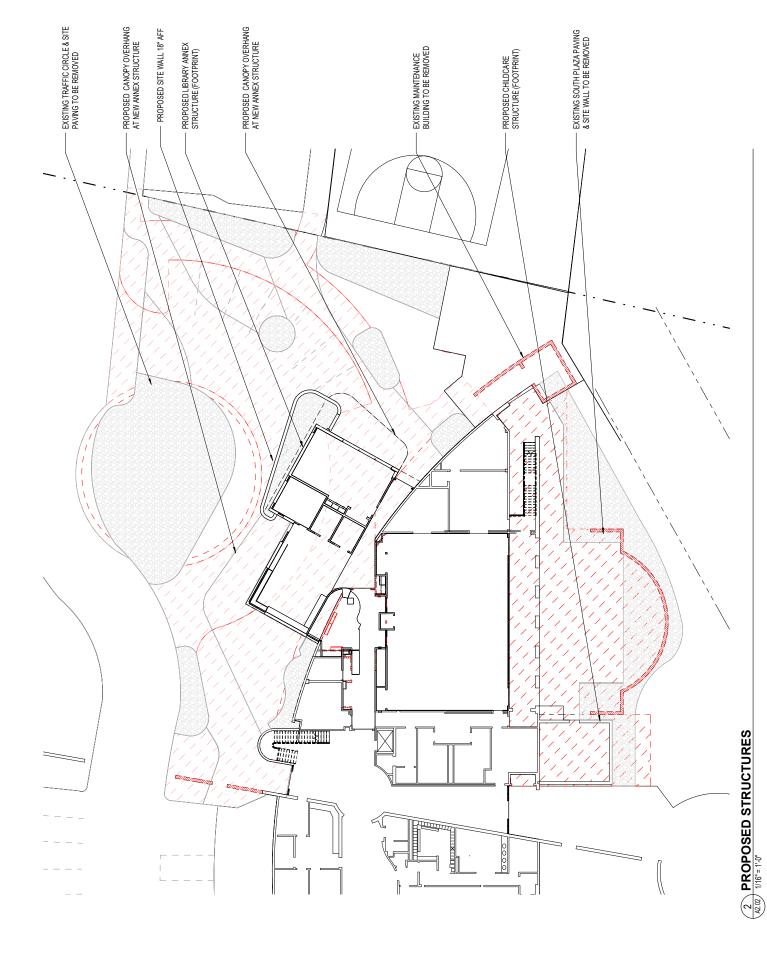

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ALL EXISTING CONDITIONS REMAIN UNLESS OTHERWISE NOTED.
PAINT NEW WALLS, AND EXISTING WALLS WHERE AFFECTED BY NEW
WORK. TOUGH UP PAINT AT EXISTING WALLS THROUGHOUT AS

FLOOR PLAN - GENERAL NOTES

**D** 

D

SEAL SEAL		24,01	No.							
	KEYNOTE LEGEND	Keynote Text	EXTERIOR WALL ASSEMBLY B - METAL SIDING PANELS INSTALLED AS RAINSCREEN OVER 2.5" RIGID INSULATION & SLIGER PARDN	W/FULL-LITE & SIDELITE	ALUMINUM STOREFRONT	EXTERIOR WALL ASSEMBLY A (TYP UON) - CEMENT PLASTER INSTALLED AS RAINSCREEN OVER 2.5" RIGID INSULATION & SURE-BOARD	GALLERY WALL HANGING SYSTEM	MONITOR, OFOI	(N) HIGH/LOW DRINKING FOUNTAIN	
		Key Value	7-03	3-02	3-03	3-02	5	-02	5-01	8


0FFICE 102 125 SF

STORAGE 105 67 SF

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RECEPTION 101 256 SF

(m) (v)

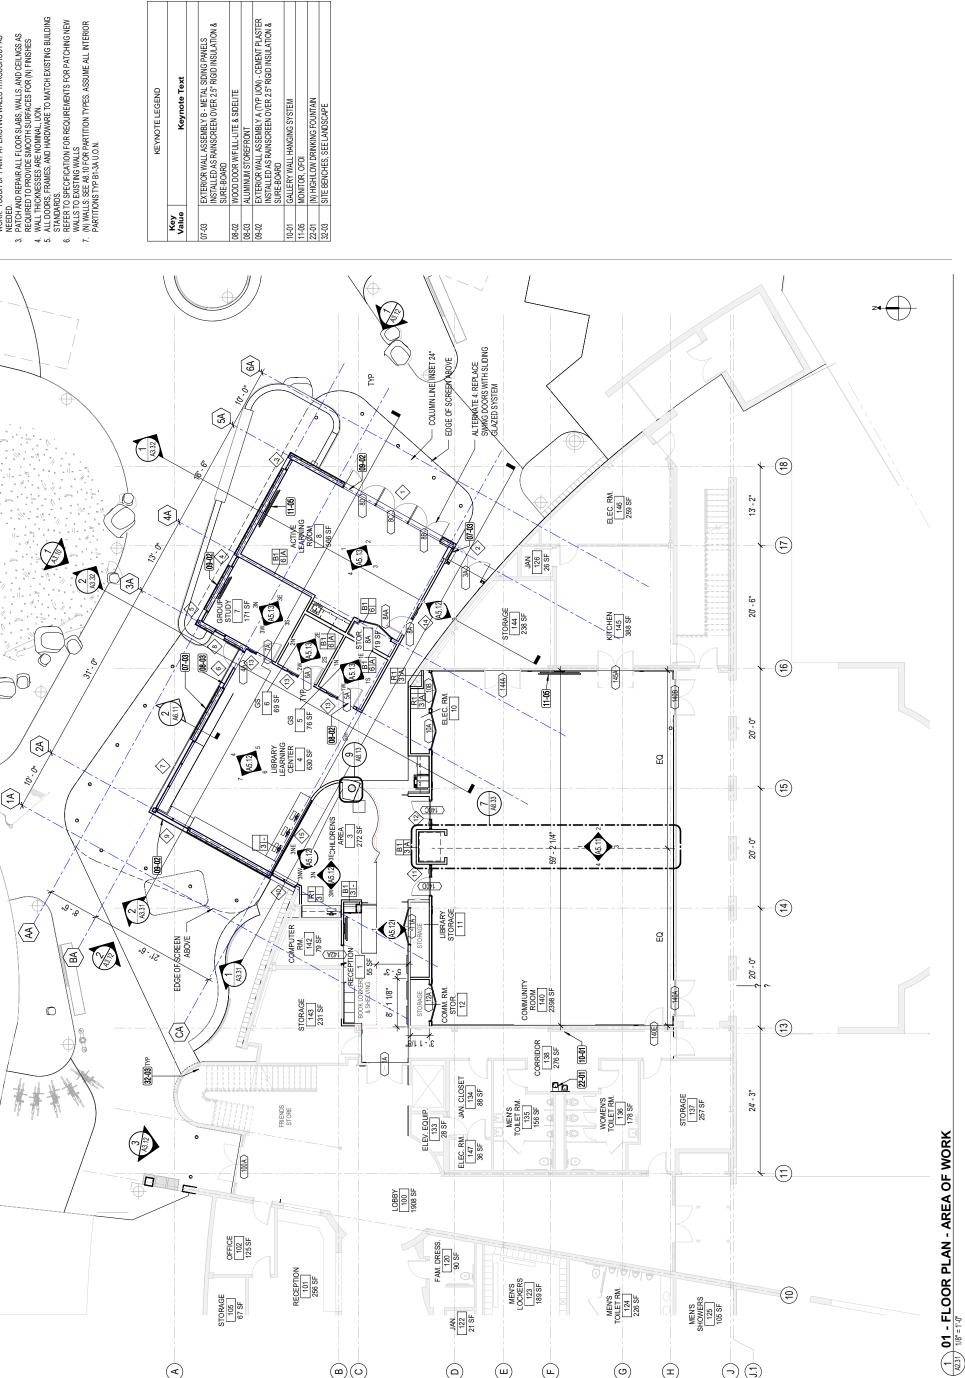

Annex

APN 02724106

DEVELOPMENT PERMIT RESUBMITTAL

21804

N&T JOB NUMBER

ISSUE DATE

DESCRIPTION

979 17th Avenue, Santa Cruz, CA 95062

**Live Oak Library** 

Santa Cruz Public Libraries

PROJECT TITLE

**APPROVALS** 

(5)

MEN'S SHOWERS 125 105 SF

FLOOR PLAN- 1ST FLOOR

SHEET NUMBER

DRAWN BY Author CHECKED BY Checker SHEET TITLE

FAM. DRESS.

JAN. 122 21 SF

MEN'S LOCKERS 123 189 SF

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**FLOOR PLAN - GENERAL NOTES** 


**ARCHITECTS** 

729 Heinz Avenue Berkeley, CA 94710 tel 510.542.2200 fax 510.542.2201

1. ALL EXISTING CONDITIONS REMAIN UNLESS OTHERWISE NOTED.
2. PAINT NEW WALLS, AND EXISTING WALLS WHERE AFFECTED BY NEW WORK. TOUCH UP PAINT AT EXISTING WALLS THROUGHOUT AS NEEDED.
3. PATCH AND REPARR ALL FLOOR SLABS, WALLS, AND CELLNGS AS REQUIRED TO PROVIDE SMOOTH SURFACES FOR (N) FINISHES.
4. WALL THICKNESSES ARE WOMINAL, UON.
5. ALL DOORS, FRAMES, AND HARDWARETO MATCH EXISTING BUILDING STANDARDS.
6. REFER TO SPECIOATION FOR REQUIREMENTS FOR PATCHING NEW WALLS TO EXISTING WALLS.
7. (N) WALLS: SEE AS 10 FOR PARTITION TYPES, ASSUME ALL INTERIOR PARTITIONS TYP B1-3A U.O.N.

	KEYNOTE LEGEND
Key ⁄alue	Keynote Text
24	ALTERNATE 1: 2ND FLOOR CONFERENCE ROOM SCOPE, SEE BID ALTERNATES ON G0.01
02	POWDER-COATED 1/8" ALUMINUM PANELS WITH CUSTOM PERFORATION PATTERN
01	PVC MEMBRANE ROOF WITH METAL EDGE TRIM
03	ALUMINUM STOREFRONT

tel 510.542.2200 fax 510.542.2201	SEAL	16	(V)			4	Ó	>
7. (N) WALLS: SEE A8.10 FOR PARTITION TYPES. ASSUME ALL INTERIOR PARTITIONS TYP B1-34 U.O.N.	KEYNOTE LEGEND	Keynote Text	ALTERNATE 1: 2ND FLOOR CONFERENCE ROOM SCOPE, SEE BID	POWDER-COATED 1/8" ALUMINUM PANELS WITH CUSTOM	PERFORATION PATTERN	PVC MEMBRANE ROOF WITH METAL EDGE TRIM	ALUMINUM STORE FRONT	
7. (N) WAL PARTITI		Key Value	02-24	05-02		07-01	08-03	

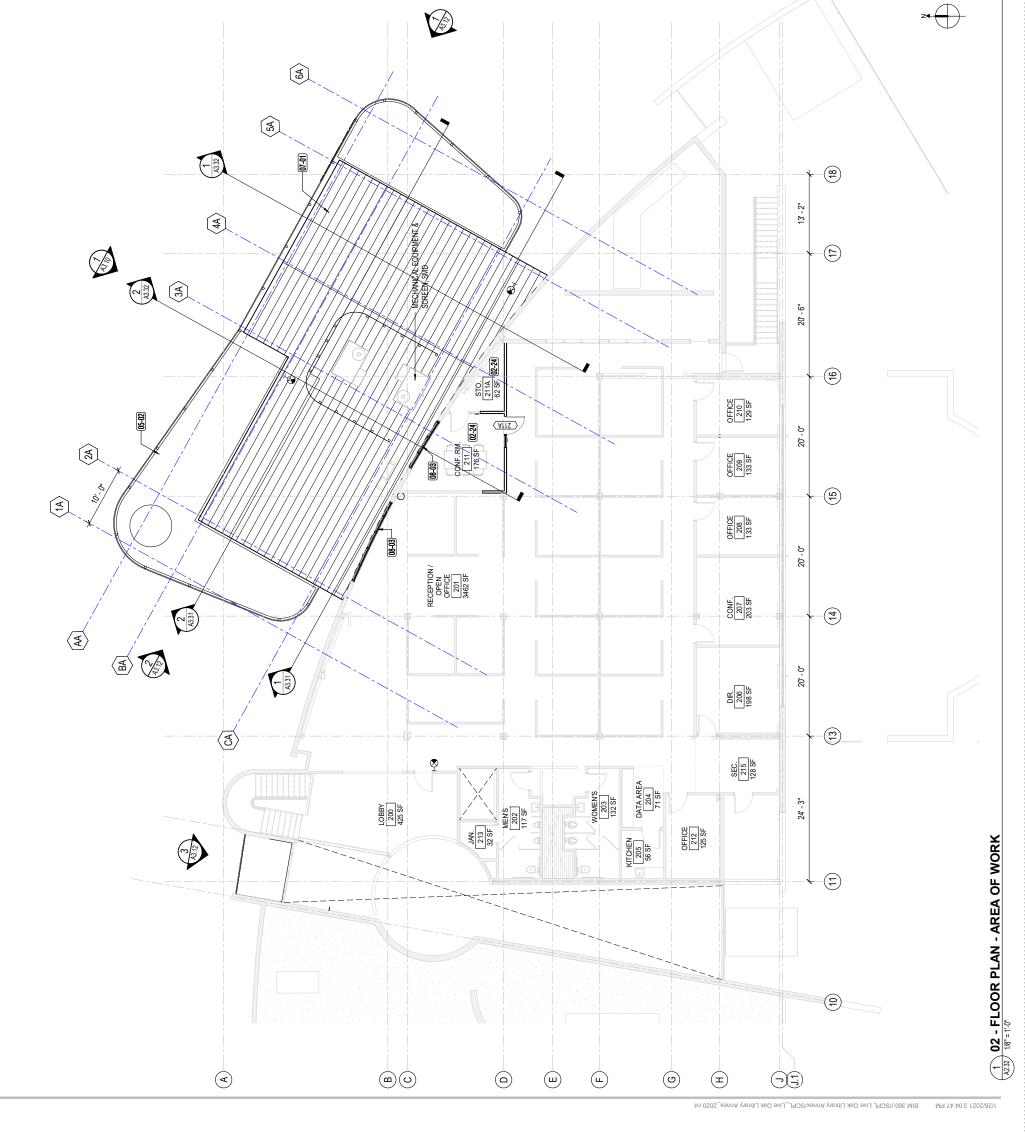

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**APPROVALS** 

FLOOR PLAN- 2ND FLOOR

SHEET NUMBER

DRAWN BY Author CHECKED BY Checker SHEET TITLE

DEVELOPMENT PERMIT
RESUBMITTAL
ISSUE DATE 11222021
NRT JOB NUMBER 21804

DESCRIPTION

REVISIONS

| DATE |

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**ROOF PLAN - GENERAL NOTES** 

1. ALL EXISTING CONDITIONS REMAIN UNLESS OTHERWISE NOTED.

729 Heinz Avenue Berkeley, CA 94710 tel 510.542.2200 fax 510.542.2201

AS 510.542.

APPROVALS

PROJECT TITLE

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979 17th Avenue, Santa Cruz, CA 95062

APN 02724106


DEVELOPMENT PERMIT
RESUBMITTAL
ISSUE DATE 11222021
NR T JOB NUMBER 21894

DESCRIPTION REVISIONS

ROOF / PENTHOUSE PLAN

SHEET NUMBER

POWDER-COATED 1/8" ALUMINUM PANELS WITH CUSTOM PERFORATION PATTERN ROOFTOP SCREEN PVC MEMBRANE ROOF WITH METAL EDGE TRIM (N) MECHANICAL EQUIPMENT, SMD Keynote Text KEYNOTE LEGEND Key Value

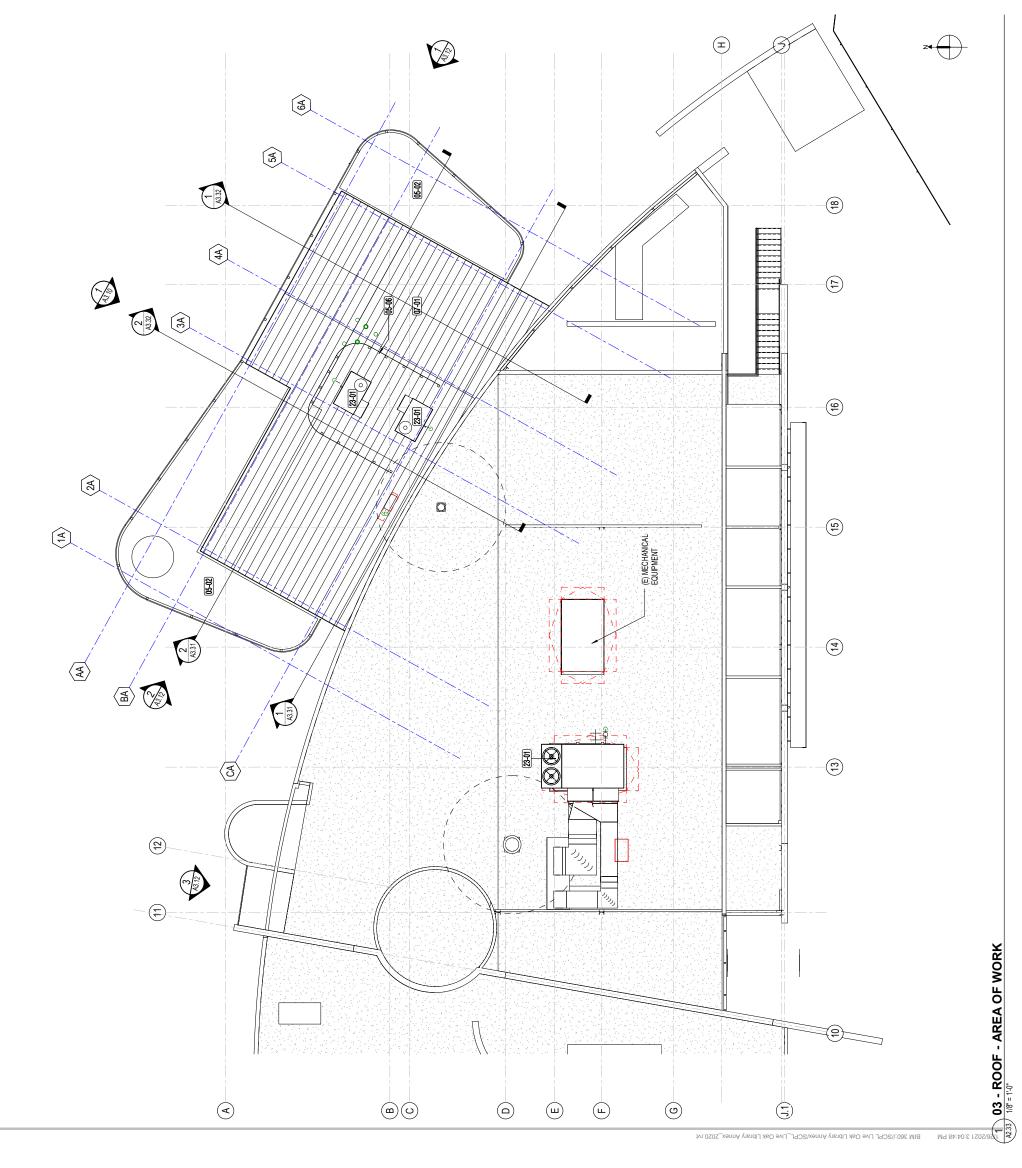

REVISIONS

| DATE |

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**APPROVALS** 

**KEY PLAN - SITE** 

otto.

dax 510.54.

dax 510.54.

NOLL 

TAM

ARCHITECTS

729 Heinz Avenue Berkeley, CA 94710 tel 510.542.2200 fax 510.542.2201

22

1 - VIEW FROM LIVE OAK TREE (FRONT OF ADDITION)

DEVELOPMENT PERMIT
RESUBMITTAL
ISSUE DATE 11222021
NRT JOB NUMBER 21894

3 - VIEW FROM MAIN (EXISTING) ENTRY

DRAWN BY Author | CHECKED BY Checker SHEET TITLE PERSPECTIVE VIEWS

SHEET NUMBER

1 - VIEW FROM PLAZA ENTRY

BIM 360://SCPL Live Oak Library Annex/SCPL\_Live Oak Library Annex\_2020.rvt

729 Heinz Avenue Berkeley, CA 94710 tel 510.542.2200 fax 510.542.2201 **ARCHITECTS APPROVALS** 

SOURCE: SHEET A3.2, 1995 ORIGINAL BUILDING PERMIT DRAWINGS

Live Oak Library
Annex Santa Cruz Public Libraries 979 17th Avenue, Santa Cruz, CA 95062 PROJECT TITLE NO CHANGE TO OTHER PORTIONS OF SWIM CENTER EXTERIOR REPLACE (E) ENTRY CANOPY AT MAIN ENTRY (N) WINDOWS IN EXISTING BLDG - (N) ADDITION PROPOSED NORTH ELEVATION (A3.10) 1/16"=1'-0"

DEVELOPMENT PERMIT
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ISSUE DATE 11222021
NRT JOB NUMBER 21894

DESCRIPTION

REVISIONS

| DATE |

APN 02724106

DRAWN BY Author | CHECKED BY Checker SHEET TITLE OVERALL ELEVATIONS

SHEET NUMBER

NOHORHSNOS HAN TON I

CEMENT PLASTEK ©
AND FRY PCS 75-50

PANELIZED PENCE GATES WITH MTL. TURNSTILES

CEMENT PLASTER (C)
(FRY PCS-75-50)
FILLED WISSENTY)

PLASTER (B)

CEMENT PLASTER (S)

GLASS / ALUM. STOREFRONT

CASTER (S)

SEMENT FLASTER


VERT VINE

VERT. VINE CABLE-TYR.

APPROXIMATE LOCATION OF ANNEX ADDITION

EXISTING NORTH ELEVATION

BIM 360://SCPL Live Oak Library Annex/SCPL\_Live Oak Library Annex\_2020.rvt

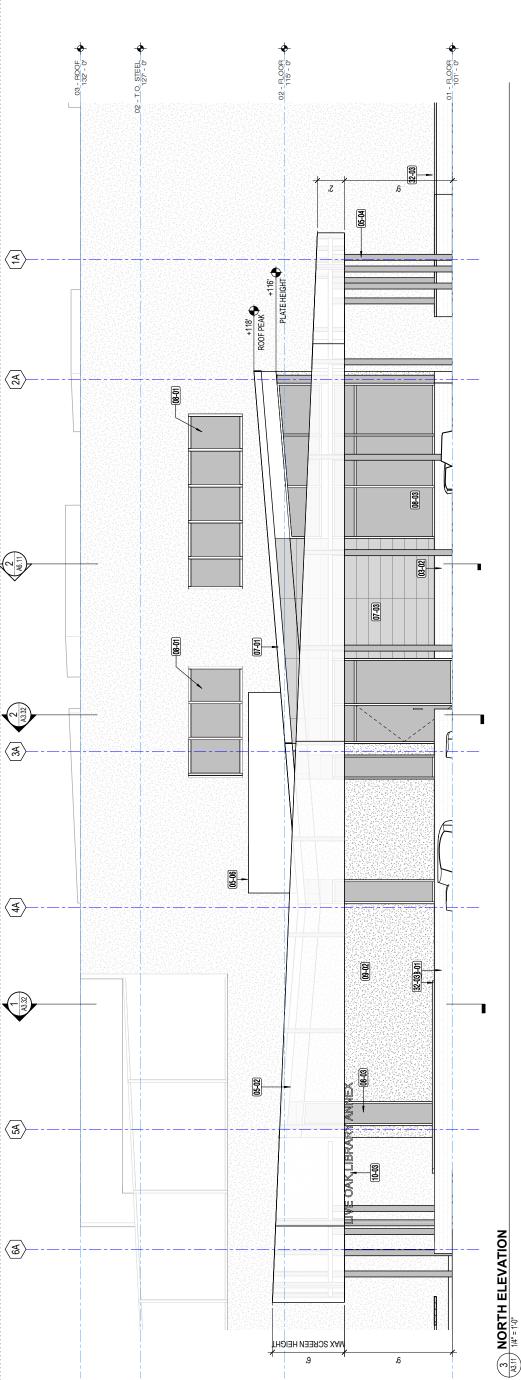

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ANODIZED FINISH - CLEAR

Building stem walls, site walls, bench base walls

CAST-IN-PLACE CONCRETE

 $\langle \S \rangle$ 

**⟨**₹⟩

**ARCHITECTS** 

729 Heinz Avenue Berkeley, CA 94710 tel 510.542.2200 fax 510.542.2201

HANDON .

**APPROVALS** 

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Live Oak Library Libraries

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DEVELOPMENT PERMIT RESUBMITTAL

ISSUE DATE

MAIN ENTRY ELEVATION
(A3.12) 1/4"=1'-0"

METAL SIDING PANELS CENTRIA 806 SLATE SILVER

2 WEST ELEVATION
(2) 1/4" = 1·0"

01 - FLOOR 101' - 0"


21804


DESCRIPTION N&T JOB NUMBER

**EXTERIOR ELEVATIONS** DRAWN BY Author CHECKED BY Checker

SHEET NUMBER

MEMBRANE ROOFING - WHITE

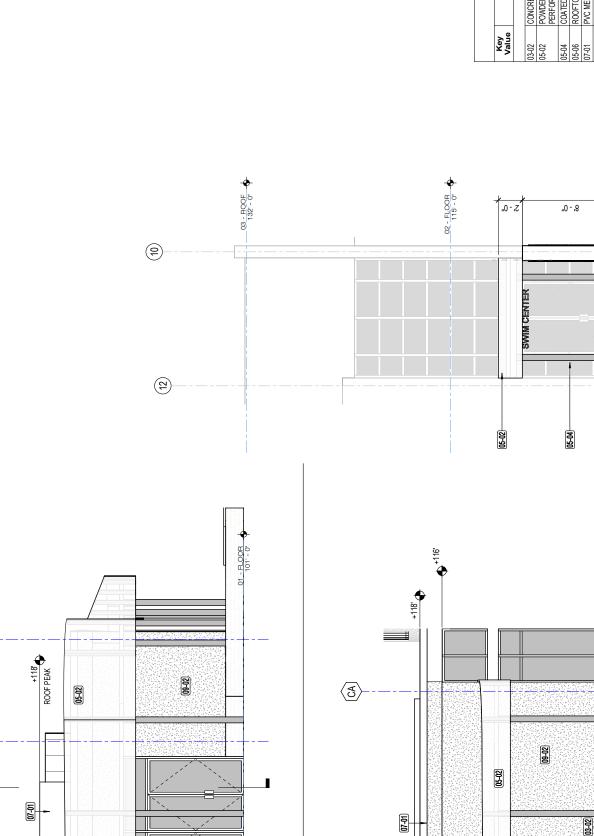

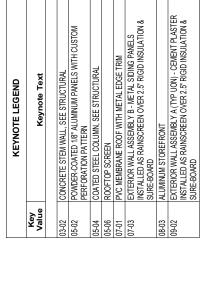












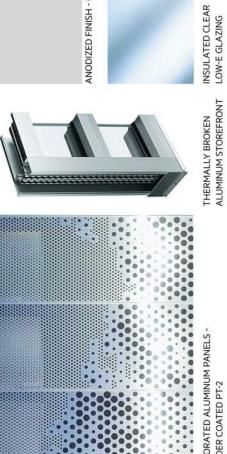



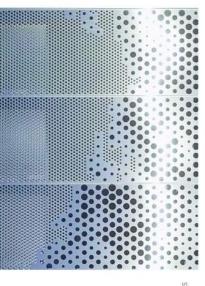

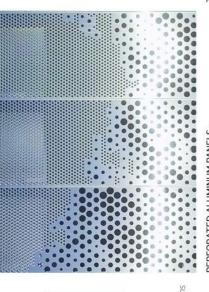



PAINT PT-2 -BENJAMIN MOORE WHITE

PAINT PT-1 BENJAMIN MOORE
NORTH SEA
Cement Plaster, Roof
rake & misc. metal

Perforated metal screen & canopy

Building stem walls, site walls, bench base walls

CAST-IN-PLACE CONCRETE


25

90-90

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(1) **EAST ELEVATION** (A3.12) 1/4" = 1·0"




NOLL

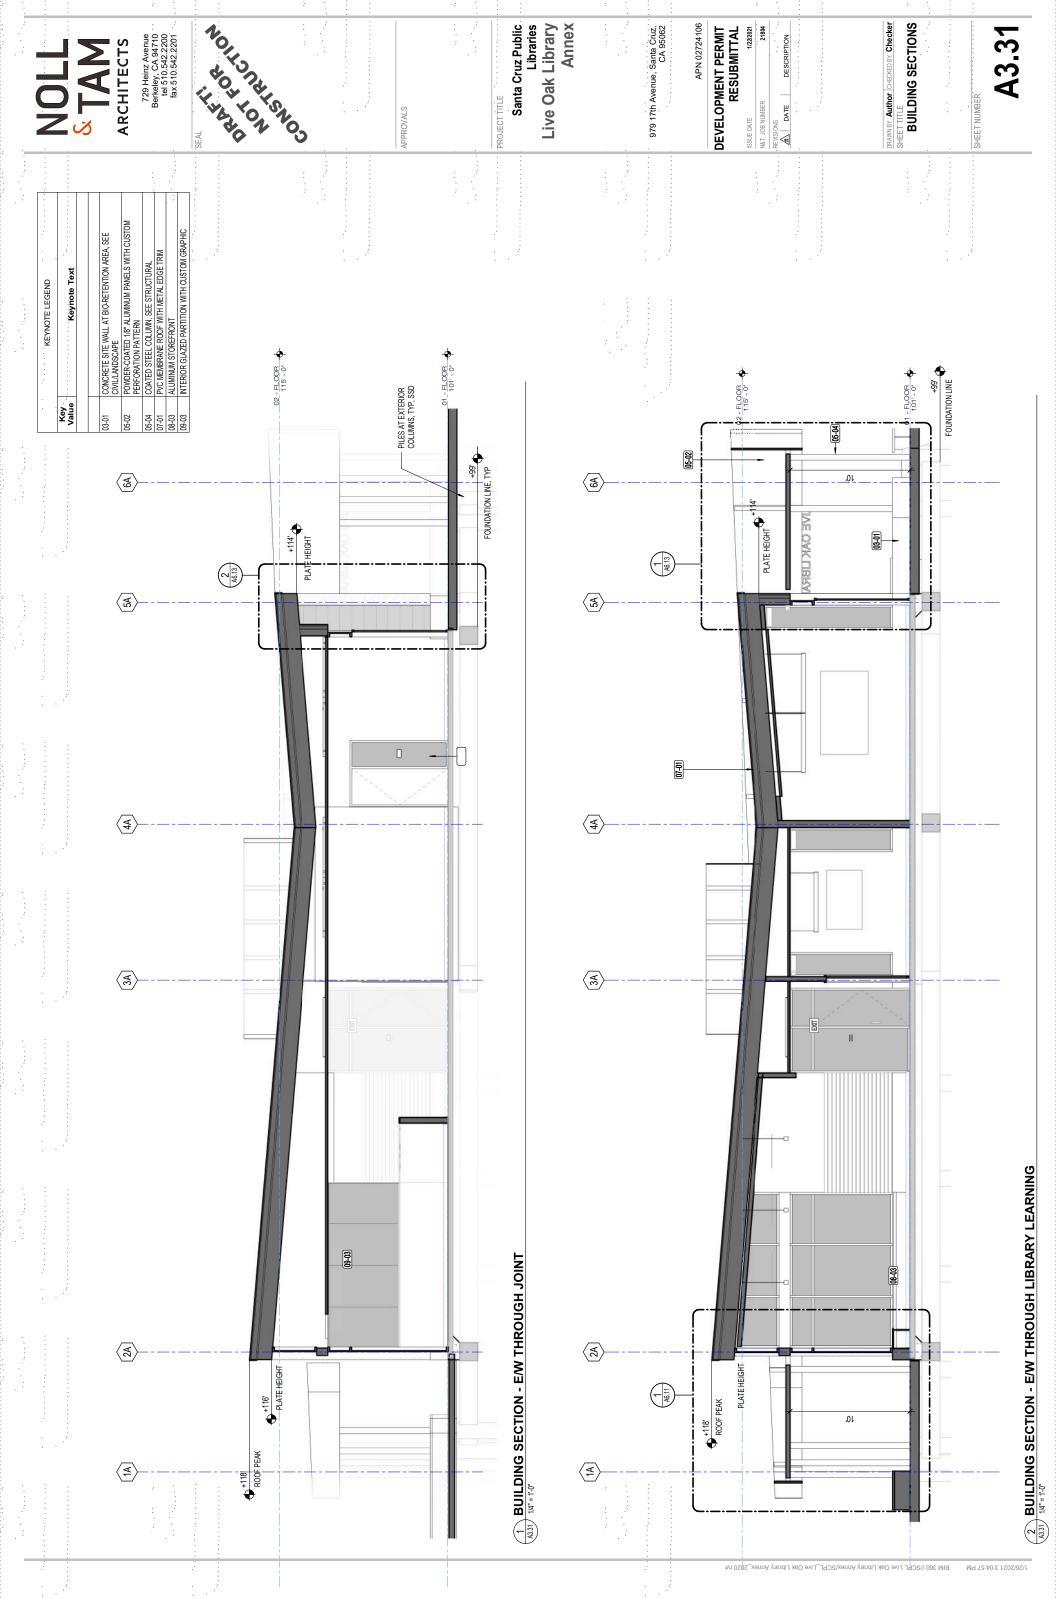STAM

ARCHITECTS

729 Heinz Avenue
Berkeley, CA 94710
tel 510.542.2201
fax 510.542.2201
SEAL

	KEYNOTE LEGEND
Key Value	Keynote Text
03-01	CONCRETE SITE WALL AT BIO-RETENTION AREA, SEE CIVILLANDSCAPE
05-02	POWDER-COATED 1/8" ALUMINUM PANELS WITH CUSTOM PERFORATION PATTERN
90-90	ROOFTOP SCREEN
07-01	PVC MEMBRANE ROOF WITH METAL EDGE TRIM
07-03	EXTERIOR WALL ASSEMBLY B - METAL SIDING PANELS
	INSTALLED AS RAINSCREEN OVER 2.5" RIGID INSULATION &
	SURE-BOARD.
08-02	WOOD DOOR WIFULL-LITE & SIDELITE
08-03	ALUMINUM STOREFRONT
09-02	EXTERIOR WALL ASSEMBLY A (TYP UON) - CEMENT PLASTER
	INSTALLED AS RAINSCREEN OVER 2.5" RIGID INSULATION &
	SURE-BOARD
32-30	STORMWATER BIO-RETENTION AREA WITH SEATWALL SURROUND

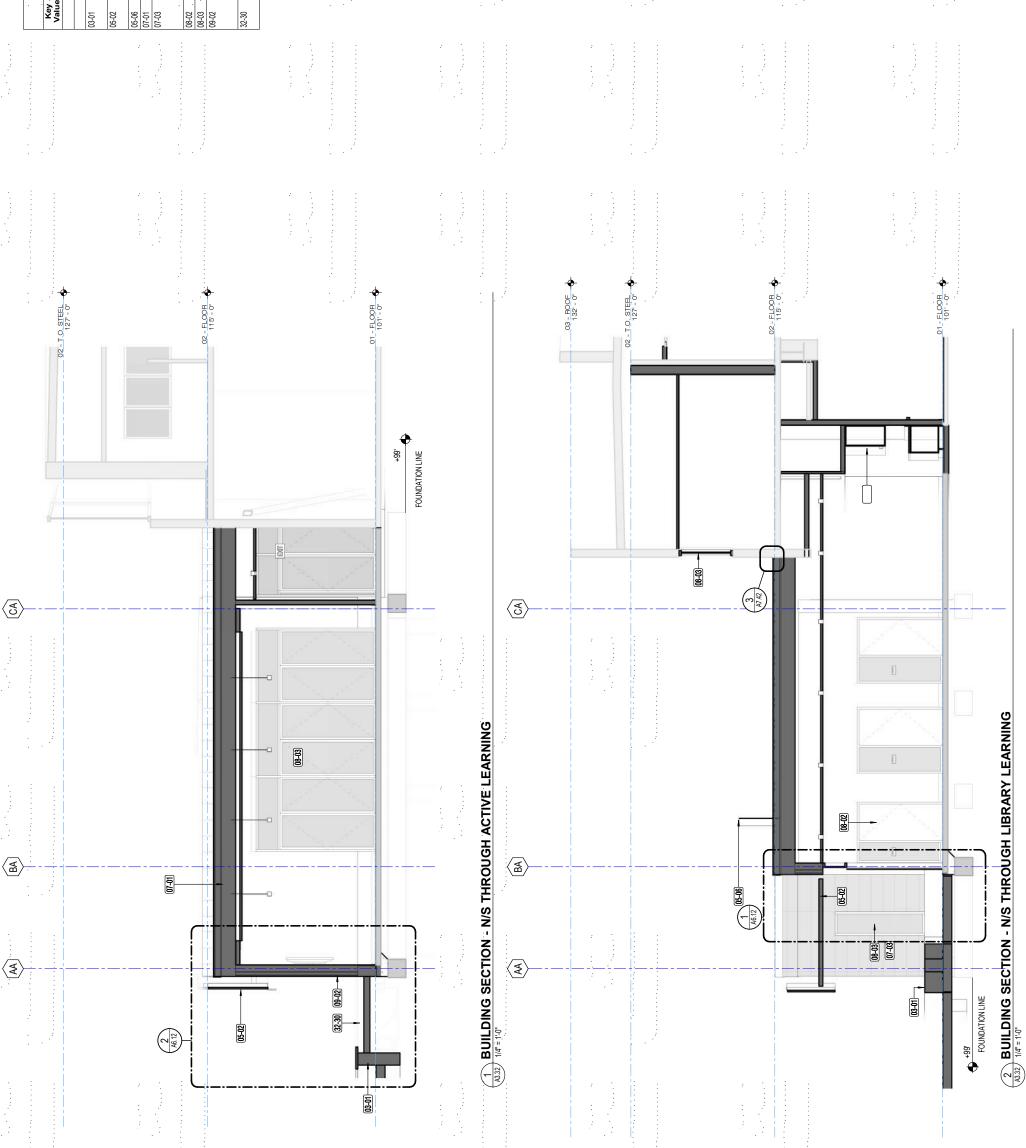

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NR T JOB NUMBER 21894

DESCRIPTION


REVISIONS


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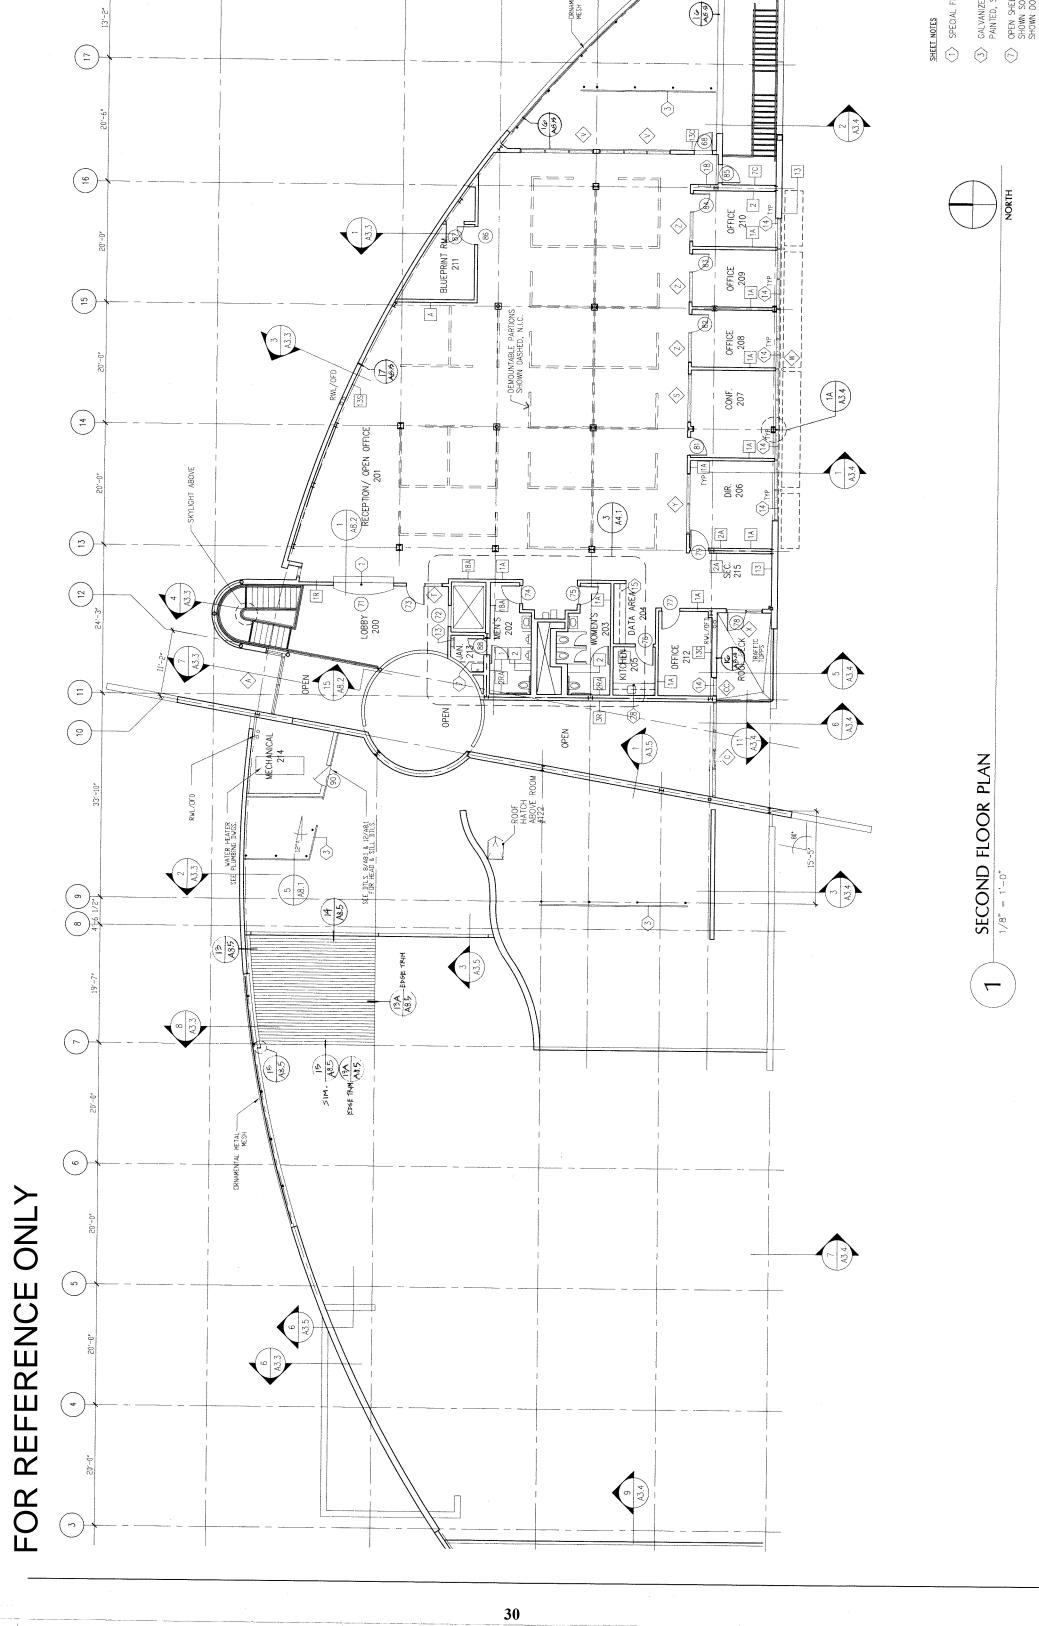
APN 02724106


DRAWN BY Author CHECKED BY Checker
SHEET TITLE
BUILDING SECTIONS


SHEET NUMBER



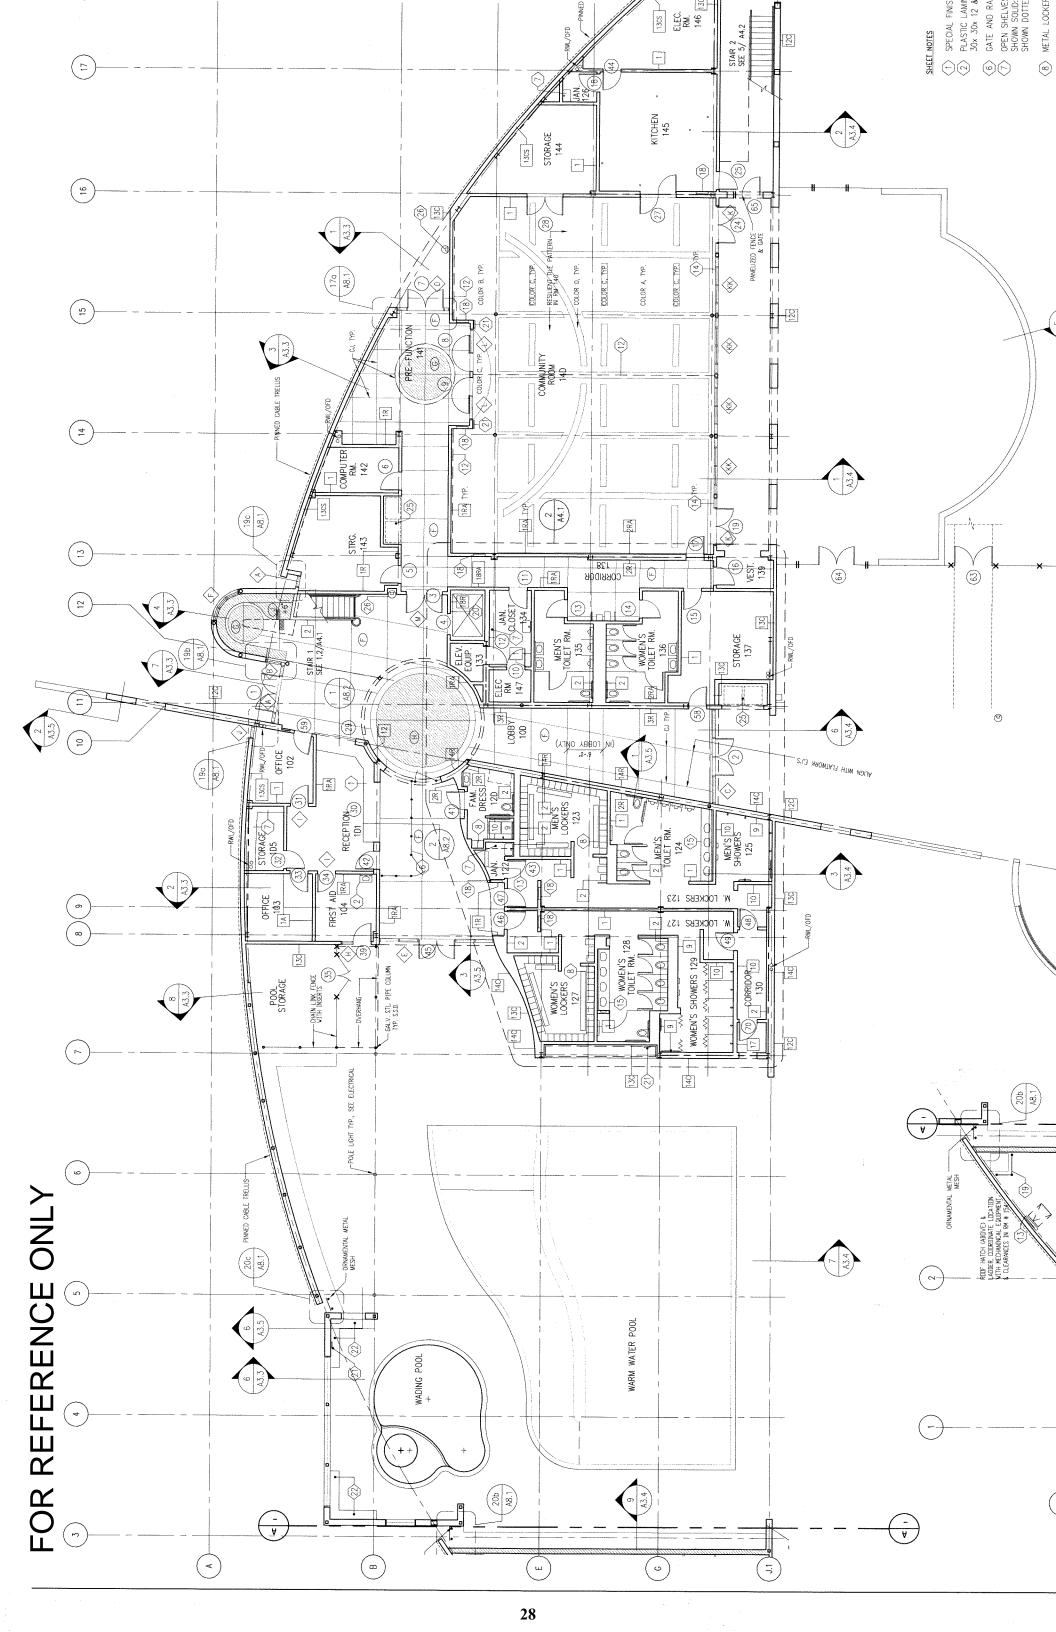

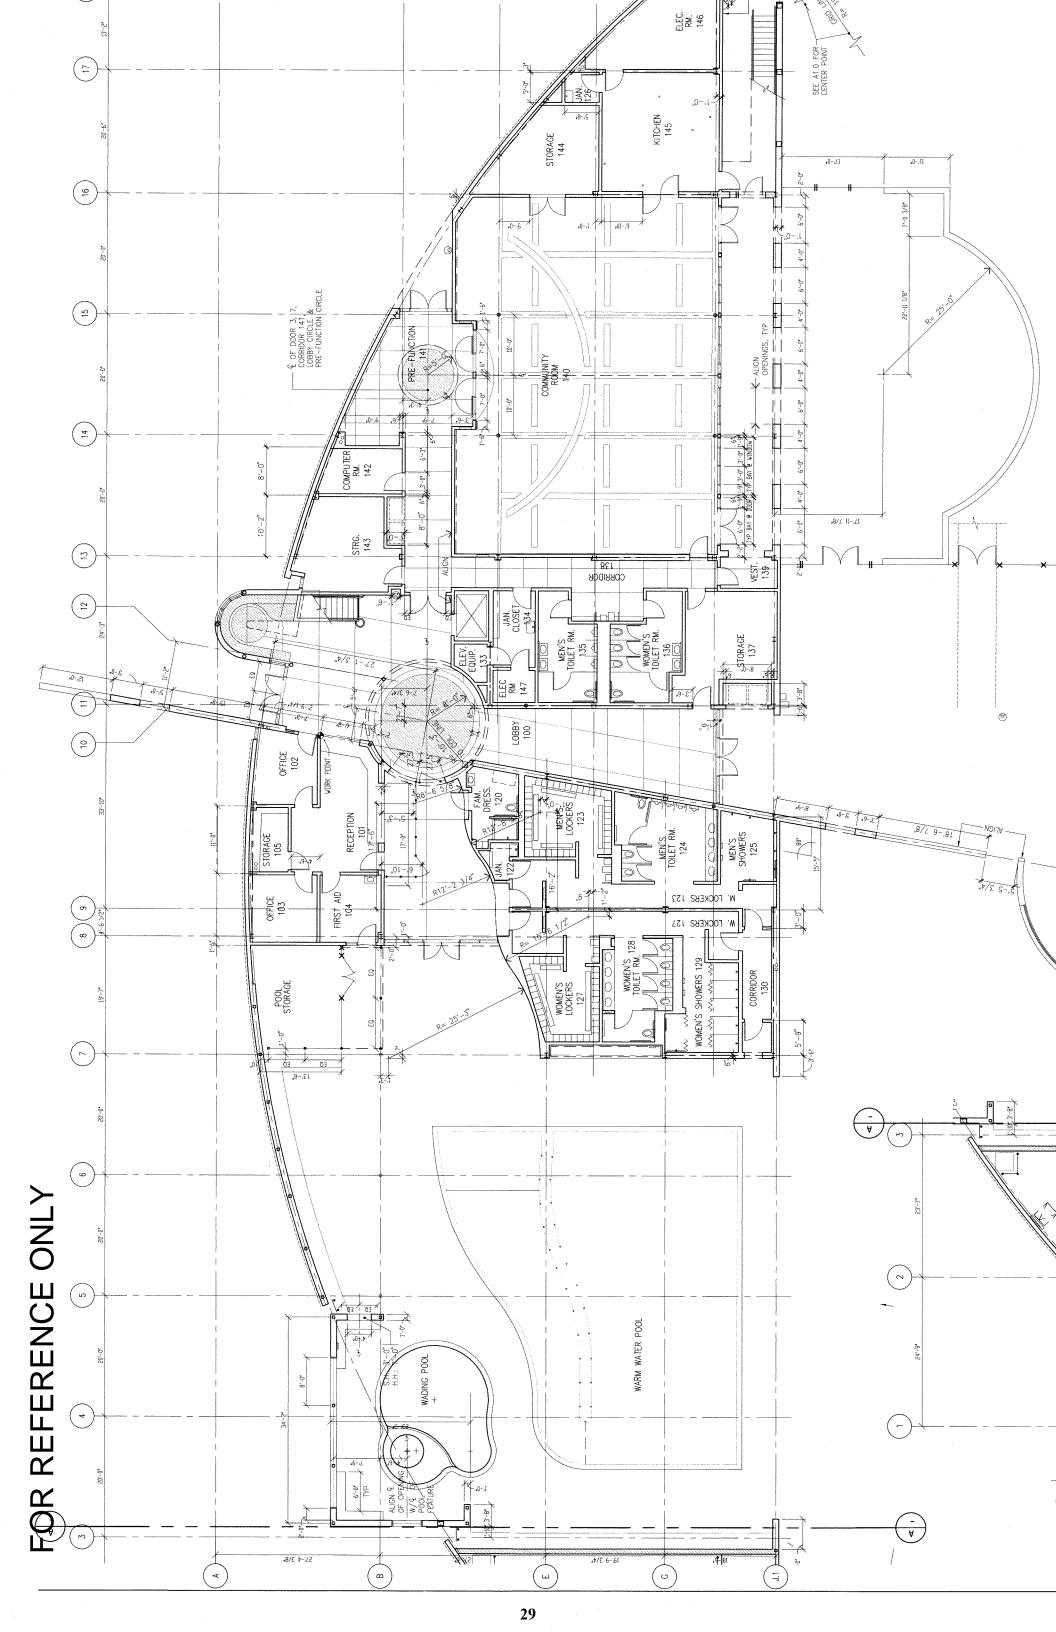

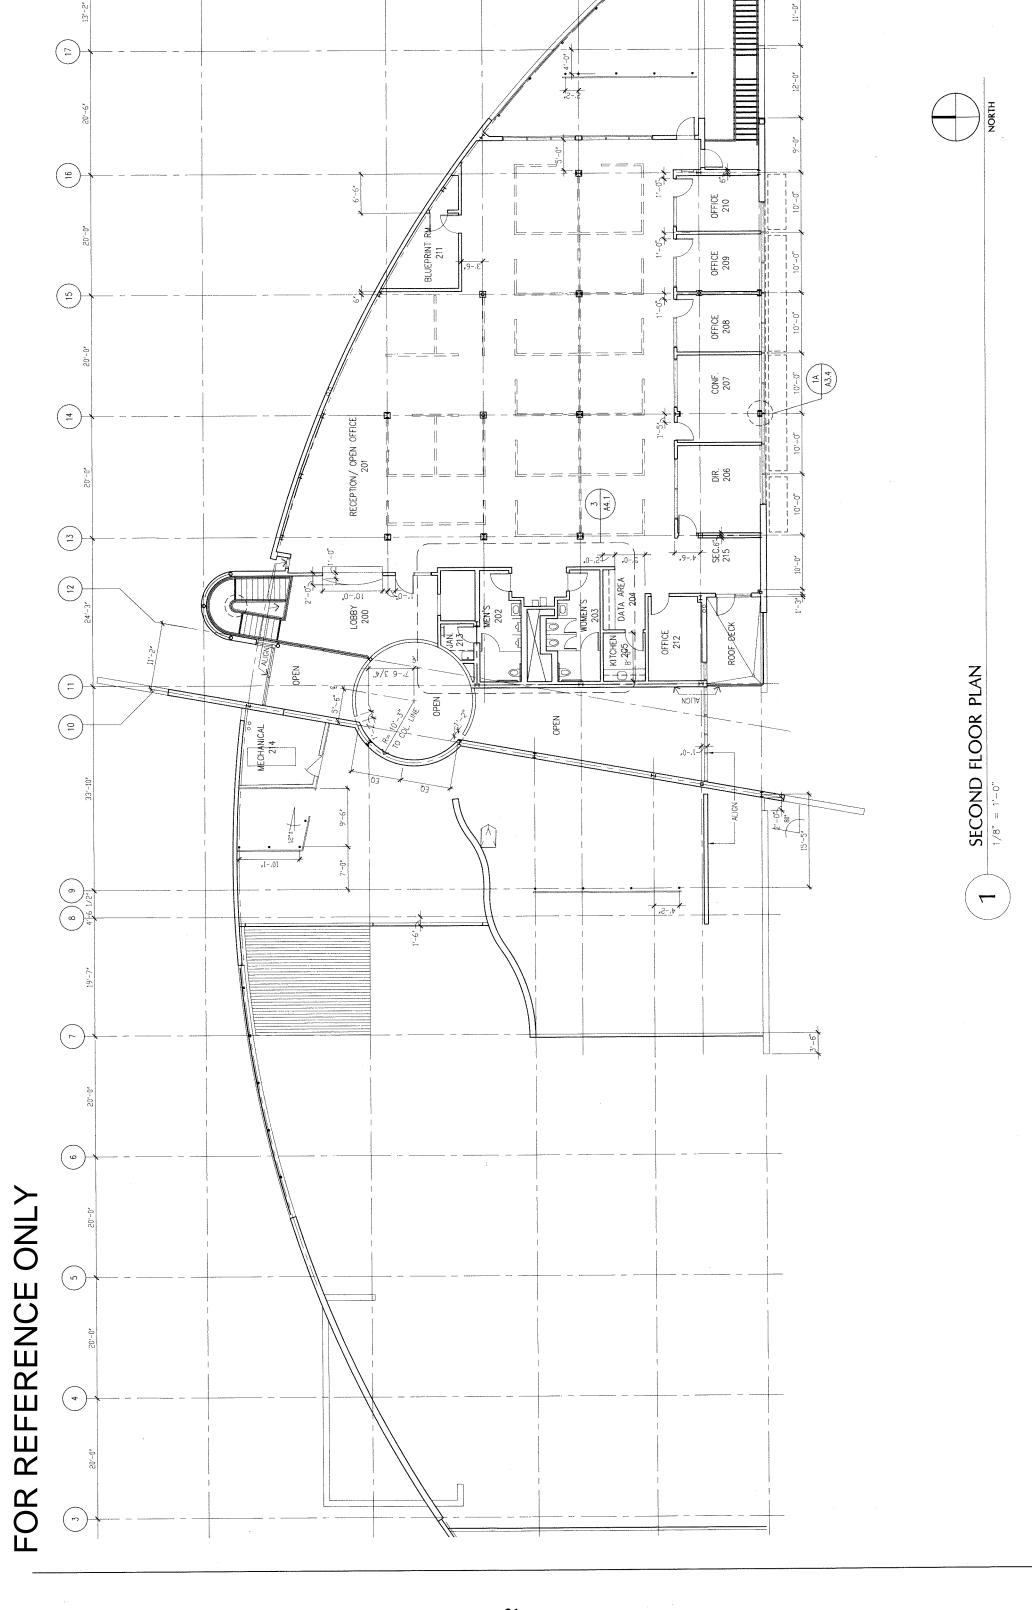

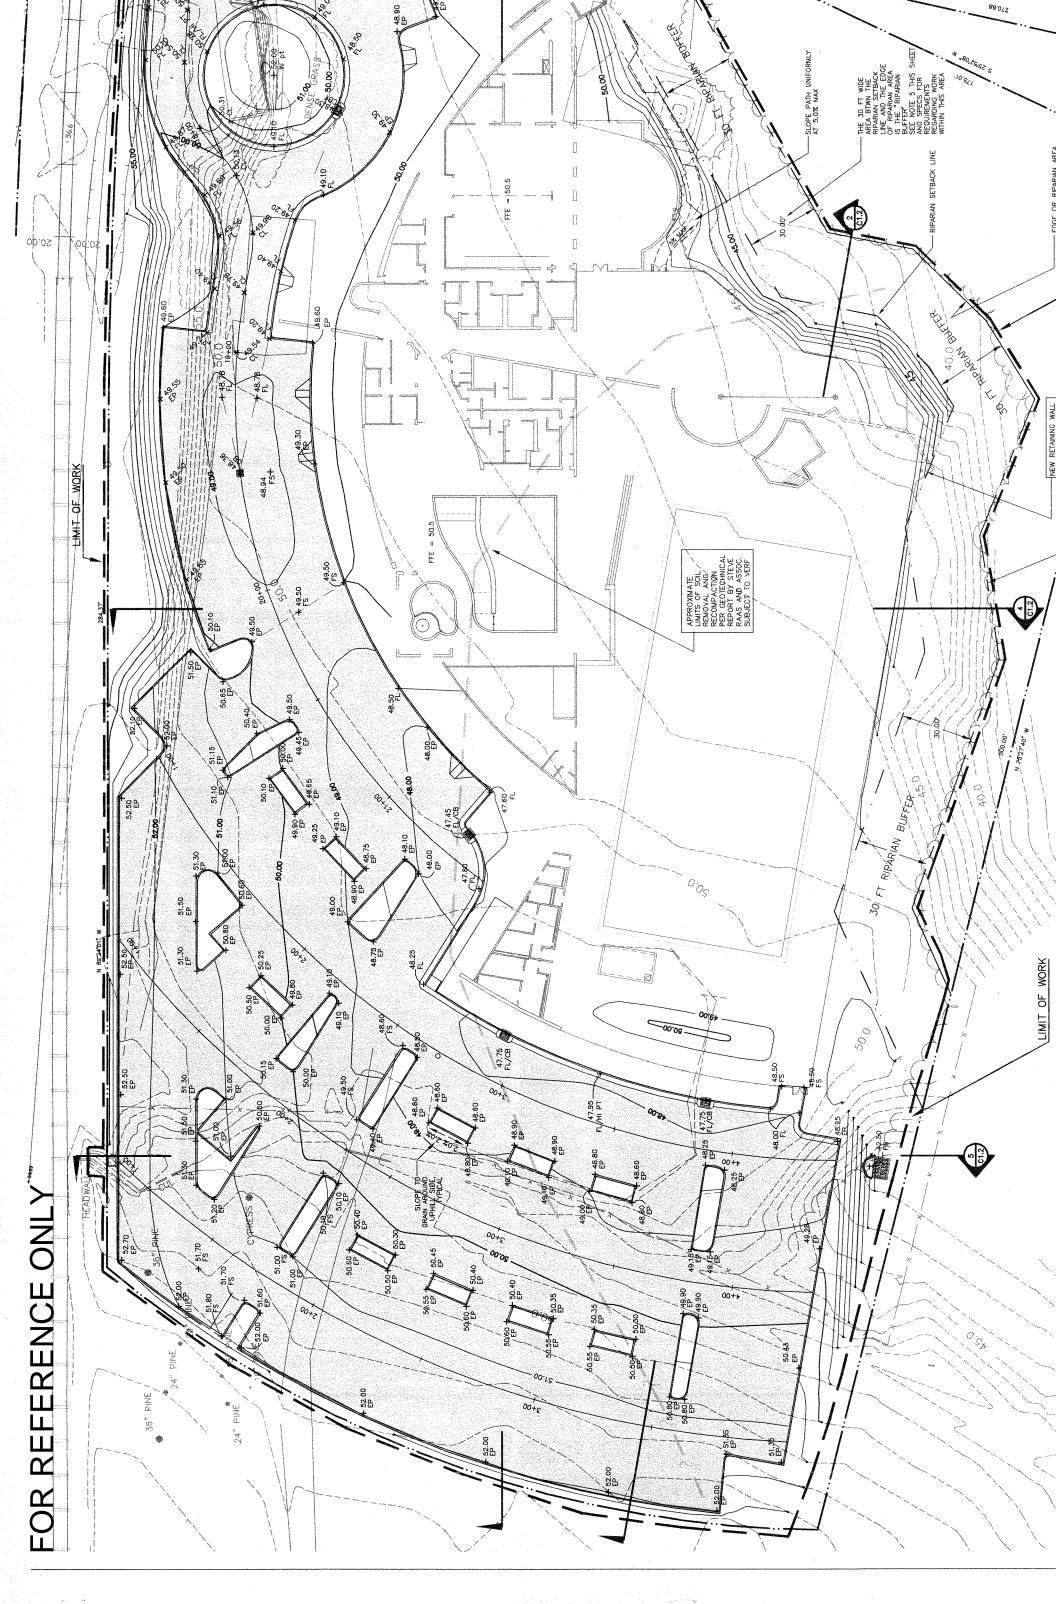

### GENERAL NOTES

- EXISTING TOPOGRAPHIC INFORMATION SHOWN ON THESE PLANS IS BASED ON TOPOGRAPHIC SURVEY PERFORMED BY BKF ENGINEERS ON APRIL 13, 2020. CONTRACTOR SHALL REVIEW THE PLANS AND SPECIFICATIONS AND CONDUCT FIELD INVESTIGATIONS AS REQUIRED TO VERIFY EXISTING CONDITIONS AT THE PROJECT SITE.
- CONTRACTOR PRIOR TO START OF DAYS PRIOR TO EXCAVATION. ELEVATIONS AND LOCATIONS OF ALL EXISTING UTILITY CROSSINGS SHALL BE VERIFIED BY THE CONSTRUCTION AFFECTING SAID LINES. CONTACT USA AT (800) 642-2444 AT LEAST TWO WORKING 7
- FIRE AND WORKS, AMBULANCE, POLICE, Y OF THE JOB SITE. CONTRACTOR SHALL POST EMERGENCY TELEPHONE NUMBERS AT THE JOB SITE FOR PUBLIC DEPARTMENTS, AND THOSE AGENCIES RESPONSIBLE FOR MAINTENANCE OF UTLITIES IN THE VICINITY
- AND COUNTY OF SANTA CRUZ STANDARD ALL APPLICABLE WORK AND WATERIALS SHALL BE DONE IN ACCORDANCE WITH THE CITY , TECHNICAL SPECIFICATIONS AND DETAILS.

FIRE WATER LINE ELECTRICAL LINE TELEPHONE LINE

WATER LINE

 ${\sf AN} \\$ 

- INFORMATION REGARDING EXISTING SUBSURFACE IMPROVEMENTS AND UTILITIES SHOWN ON THESE PLANS WAS TAKEN FROM RECORD DATA MONINTO THE LEGISLAND REGISTRY OF EXALLION CONTINUORS SHALL CONDITIONS. THE LOCATION AND ELEVATION OF ALL EXISTING SUBSURFACE IMPROVEMENTS AND UTILITIES THE LOCATION AND INTEREST PLANS OR WOUT) PRIOR TO THE COMMENCEMENT OF WORK. CONTRACTOR SHALL NOTIFY THE CONSTRUCTION MANAGER WHO SHALL NOTIFY THE DESIGN ENGINEER IMMEDIATELY UPON DISCOVERY OF DISCREPANCIES BETWEEN EXISTING CONDITIONS IN THE FILED AND INFORMATION SHOWN ON THESE PLANS.
- ER OF ANY DIFFERENCES IN LOCATIONS OF G CONSTRUCTION, BEFORE CONTINUING WITH IT SHALL BE THE CONTRACTOR'S RESPONSIBILITY TO NOTIFY THE OWNER AND THE CIVIL ENGINE EXISTING UTILITIES SHOWN, OR ANY CONFLICTS WITH THE DESIGN THAT BECOME APPARENT DURIN WORK IN THAT AREA. ø.
- 崖 IF ANY DAMAGE TO EXISTING UTILITIES OCCURS, THE CONTRACTOR SHALL NOTIFY THE ENGINEER AND OWNER AND SHALL REPAIR DAMAGE AS DIRECTED BY THE ENGINEER AND OWNER AT NO ADDITIONAL COMPENSATION.
- THE CONTRACTOR SHALL RESTORE/REPLACE ALL DAMAGED, REMOVED, OR OTHERWISE DISTURBED WALLS, FENCES, SERVICES, UTILITIES, IMPROVEMENTS OR FEATURES OF WHATEVER NATURE THAT ARE NEW OR EXISTING—TO—REMAIN, DUE TO CONTRACTOR'S WORK.

SPOT ELEVATION WATER VALVE TIRE HYDRANT

AC CURB

AREA DRAIN

CLEANOUT

MANHOLE

- THE CONTRACTOR SHALL COORDINATE HIS WORK WITH THE INSTALLATION OF FACILITES BY PC&E, PACIFIC BELL, AT&T, AND CABLE TY INSTALLATION. VALVE BOXES, MANHOLES, AND STRUCTURES TO BE SET TO GRADE IN FINISHED SURFACE AFTER PAVING. 6
- UTILITY CONNECTIONS AND DISCONNECTIONS NECESSARY TO COMPLETE THE WORK WILL BE PERFORMED IN A MANNER TO MINIMIZE UTILITY SERVICE INFERCIPONIS TO THE FACILITY DEFENDING STALL PROVIDE FOR TEMPORARY BYPASS SERVICES IN ORDER TO MAINTAIN THE FACILITY'S OPERATIONS, AT NO ADDITIONAL COST TO THE OWNER. THE OWNER'S FIELD REPRESENTATIVE SHALL COORDINATE ALL UTILITY INTERRUPTIONS DURING ALL PHASES OF CONSTRUCTION. CONTRACTOR SHALL COORDINATE ALL "DOWN TIME" WITH THE OWNER. 6.
- ALL STREET MONUMENTS AND OTHER PERMANENT MONUMENTS DISTURBED DURING THE PROCESS OF CONSTRUCTION SHALL BE REPLACED BEFORE ACCEPTANCE OF THE IMPROVEMENTS BY THE CITY ENGINEER. Ë
- ¥¥ THE CONTRACTOR SHALL NOT DISTURB OR DESTROY ANY PERMANENT SURVEY POINTS WITHOUT CONSENT OF THE CITY ENGINEER. PERMANENT MONUMENTS OR POINTS DISTURBED OR DESTROYED SHALL BE REPLACED BY A LICENSED ENCINEER OR SURVEYOR AT CONTRACTOR'S EXPENSE. 12.
  - THE CONTRACTOR SHALL GIVE THE CITY ENGINEER TWO WORKING DAYS ADVANCE NOTICE FOR INSPECTION. 13.
- SHOULD IT APPEAR THAT THE WORK TO BE DONE, OR ANY MATTER RELATIVE THERETO, IS NOT SUFFICIENTLY DETAILED OR EXPLAINED ON THESE PLANS, THE CONTRACTOR SHALL CONTACT BKF ENGINEERS FOR SUCH FURTHER EXPLAINATIONS AS MAY BE NECESSARY.

CIVIL NOTES, LEGEND, AND ABBREVIATIONS EXISTING CONDITIONS PLAN DEMOLITION PLAN HORIZONTAL CONTROL AND PAVING PLAN GRADING PLAN STORMMATER CONTROL PLAN STORMMATER DETAILS CONSTRUCTION DETAILS EROSION CONTROL PLAN

8888888888 25.5.3. 26.0. 27.0. 28.0. 29.0.

DESCRIPTION

SHEET NO

SHEET INDEX

- THE CONTRACTOR SHALL COMPLY WITH THE RULES AND REGULATIONS OF THE STATE CONSTRUCTION SAFETY ORDER
- THE CONTRACTOR'S ATTENTION IS DIRECTED TO THE REQUIREMENTS OF THE DIVISION OF INDUSTRIAL SAFETY PERTAINING TO "CONFINED SPACES". ANY MANHOLE, CULVERT, DROP INLET, OR TRENCH (WHICH COULD CONTAIN AIR), THAT IS NOT READILY VENTILATED, MAY BE CONSIDERED A "CONFINED SPACE". 16.
- CONTRACTOR SHALL PROVIDE BARRICADES TO PROTECT THE GENERAL PUBLIC AND TO PREVENT UNCONTROLLED ACCESS TO THE SITE AT ALL TIMES.
- ASPHALT AS REQUIRED TO PROTECT OPEN NO TRENOHES OR HOLES SHALL BE LEFT OPEN OVERNIGHT; USE STEEL PLATING OR HOT-MIX TRENOHES OVERNIGHT. 19

PEDESTRIAN, PUBLIC AND WHEELCHAIR ACCESSES SHALL BE MAINTAINED/SUBSTITUTED DURING THE CONSTRUCTION TO THE SATISFACTION OF THE CITY ENGINEER.

<u>8</u>

- CONTRACTOR SHALL MAINTAIN GOOD HOUSEKEEPING PRACTICES AT THE JOB SITE. EXCESS BUILDING MATERIALS AND DEBRIS SHALL REMOVED PROMPILY FROM THE JOB SITE AND DISPOSED OF AT AN APPROVED DUMP SITE. THE JOB SITE SHALL BE LEFT "BROOM CLEAN" THE END OF EACH WORKDAY. 20.
- THE CONTRACTOR SHALL CONTROL DUST AT ALL TIMES AND SWEEP STREETS AS OFTEN AS NECESSARY DURING CONSTRUCTION. 7
- CONTRACTOR SHALL PROVIDE FOR DEWAITERING OPERATION DURING CONSTRUCTION PER GEOTECHNICAL REPORT RECOMMENDATIONS GOVERNING AGENCIES REQUIREMENTS FOR DISPOSAL OF GROUND WAITER. 22.
- ALL PERMITS FOR WORK ASSOCIATED WITH THESE PLANS, INCLUDING ENCROACHMENT PERMITS REQUIRED FOR WORK WITHIN EXISTING PUBLIC RIGHTS OF WAY, SHALL BE OBTAINED BY THE CONTRACTOR. 23.

  - IT IS THE CONTRACTOR'S RESPONSIBILITY TO IDENTIFY ALL NECESSARY PERMITS INCLUDING ENVIRONMENTAL REQUIREMENTS FOR REMOVAL AND DISPOSAL OF DEBRIS. 24.
- ALL WORK SHALL BE PERFORMED IN CONFORMANCE WITH REQUIREMENTS OF THE PROJECT GEOTECHNICAL ENGINEER. 25.
- SHOULD THE CONTRACTOR UNCOVER HUMAN REMAINS ON SITE DURING CONSTRUCTION, CONTRACTOR SHALL CONTACT OWNER AND IN ACCORDANCE WITH PUBLIC RESOURCE CODE, NO FORFHER EXCAVATION OR DISTURBANCE OF THE SITE OR ANY NEARBY AREA REASONABLY SUSPECTED TO OVERLIE ADJACENT HUMAN REMAINS SHALL BE DISTURBED UNTIL MITIGATION MEASURES HAVE BEEN IMPLEMENTED. 26.
- ALL UTILITIES OUTSIDE OF PROPERTY LINE SHALL BE LEFT IN PLACE

MA 04:49:40 MA 04:40

## LEGEND

### EXISTING 1 X 101 - FW $\circ$ -UGE-000 S SS CAS PROPOSED SS GAS STORM DRAIN PERFORATED PIPE UNDERGROND ELECTRICAL LINE BOUNDARY/RIGHT-OF-WAY STORM DRAIN DROP INLET SANITARY SEWER LINE STORM DRAIN LINE

GAS LINE

# **ABBREVIATIONS**

NOLL TAM

ΜM ASPHALT CONCRETE 

9	AREA DRAIN	NTS
<b>&gt;</b>	BOUNDARY	동
	BOTTOM OF SLOPE	Ρ⁄L
	COMPACT	5 2
980	CURB AND GUTTER	Poc
	CAICH BASIN	Į.
TWE	CHILLED/HOT WATER RETURN	PR/PROP
S	CHILLED/HOT WATER SUPPLY	PVC
ኒ. የ	CENTER LINE, CONTROL LINE	P.CP
	CLEAR	κ⁄*
	COMMUNICATIONS	RW
	CORRUGATED METAL PIPE	S
	CLEANOUT	S
ONC.	CONCRETE DOI 19 F. CHECK DETECTOR ASSEMBLY	EWOS O
r.	DROP IN FT	SSMH
<u> </u>	DUCTIF IRON PIPE	W/S
	EXISTING GRADE	2
0	ELECTRICAL	TELECOMM
EXIST	EXISTING	F
	FACE OF CURB	5
	FINISH FLOOR	MOT
	FINISH GRADE	¥
	FIRE HYDRANT	NGE
	FLOW LINE	VCP
	FIRE WATER	W, WD
	GAS	OM:
	GRADE BREAK	W :
D.F.	HIGH DENSITY POLYETHYLENE	WW
OWIT OW	TOT WATER SEND ARTHRON	M SE
NW LI - CW	NOT WATER SEND/RETORN	>
	IRRIGATION	
	JOINT TRENCH	
	JOINT POLE	
	LINEAR FEET	

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OVERHEAD
PROPERTY LINE
PORTLAND CEMENT CONCRETE
POINT OF CONNECTION
PAVEMENT

NON-POTABLE WATER NOT TO SCALE OVERHEAD

**ARCHITECTS** 

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PROPOSED POLYMNYL CHLORIDE PIPE REINFORED CONCRETE PIPE	RIGHT OF WATE RECLAIMED WATER SLOPE, SOUTH STIORM DRAIN	STORM DRAIN MANHOLE SANITARY SEWER SANITARY SEWER MANHOLE SIDEWALK	TOP OF CURB TELECOMMUNICATION TRAFFIC INDEX TOP OF GRATE	TOP OF WALL TYPICAL UNDER GROUND ELECTRIC VITRIFIED CLAY PIPE WATTR WEST	CHILLED WATER WATER LINE WATER METER WATER SUBFACE FLEVATION		

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DEVELOPMENT PERMIT **1&T JOB NUMBER** SSUEDATE No. C43971

> IHESE IMPROVEMENT PLANS HAVE BEEN PREPARED UNDER MY DIRECTION ENGINEER'S STATEMENT

DETAIL NO 1 ON SHEET C7.00

(7.00

SECTION A ON SHEET C5.01

DESCRIPTION

SYMBOL

SYMBOLS

DATE

ROLAND N.V. HAGA R.C.E NO. 43971 BKF ENGINEERS

# ENGINEER OF WORK

I HEREBY DECLARE THAT I AM THE CYNL ENGNEER OF WORK FOR THIS PROJECT AND THAT I HAVE EXERGISD RESPONSIBLE CHARGE OVER THE DESIGN OF THIS PROJECT AS DETNED IN SECTION 6703 OF THE STATE OF CALIFORNIA, BUSINESS & PROFESSIONAL CODES, AND THAT THE DESIGN IS CONSISTENT WITH CURRENT STANDARDS.




JONATHAN TANG P.E. NO. 67726 BKF ENGINEERS

Know what's **below. Call before you dig** 


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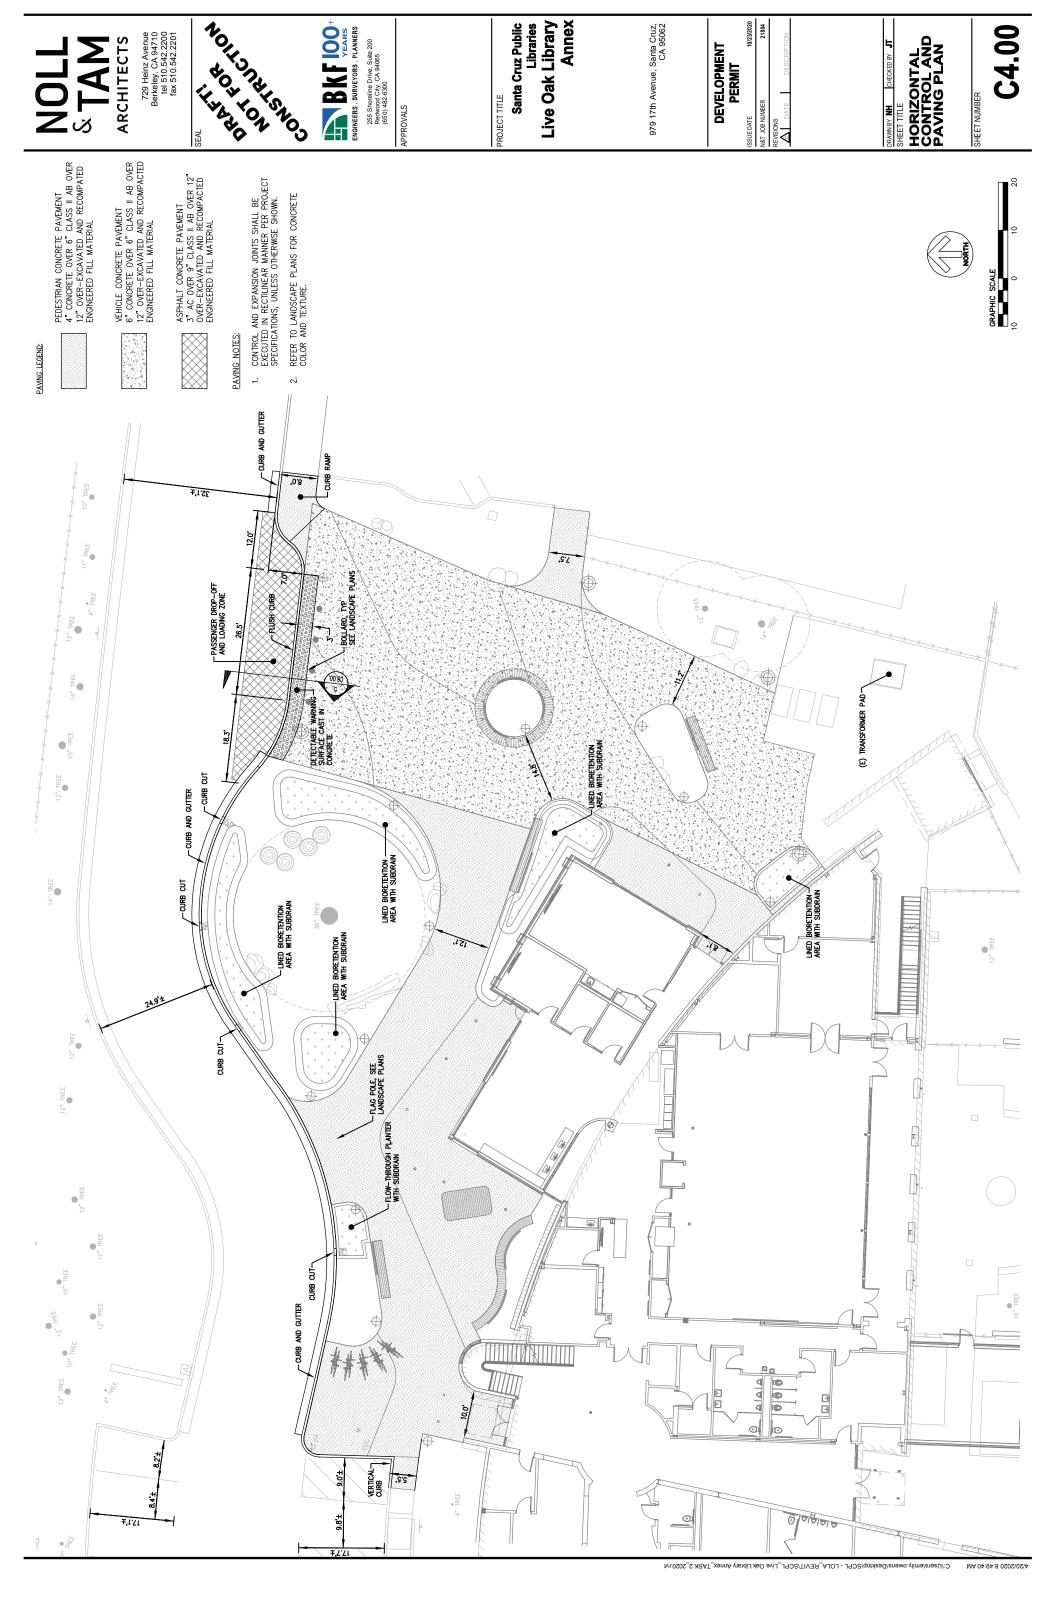
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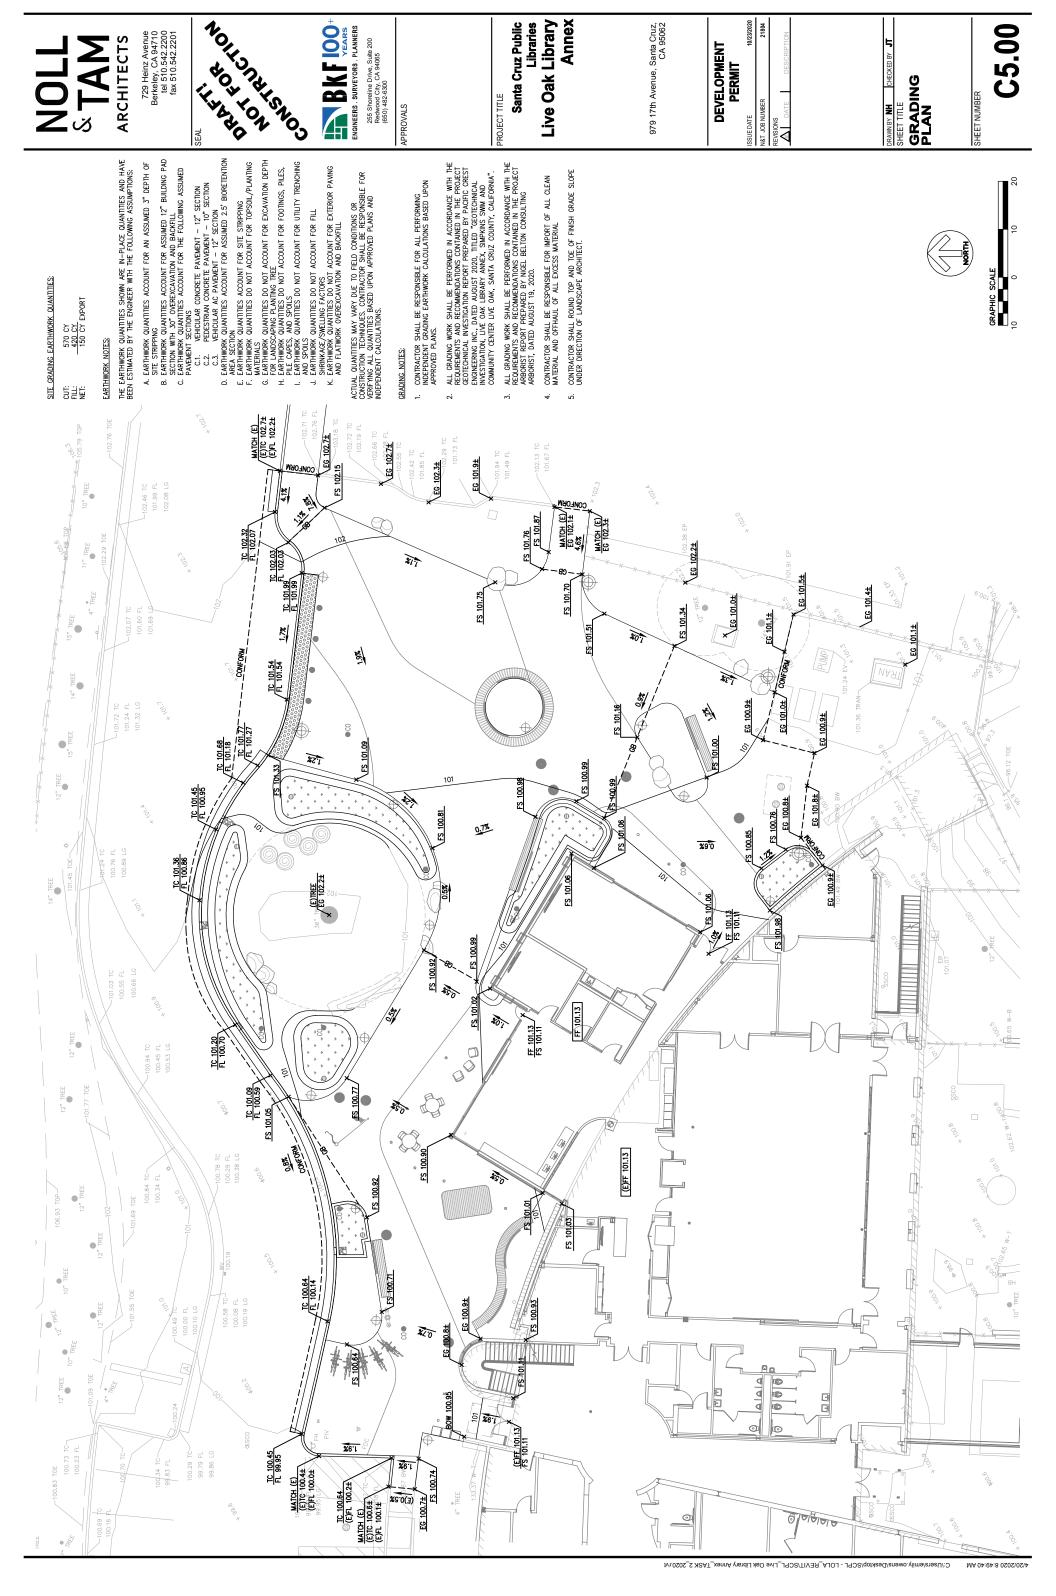
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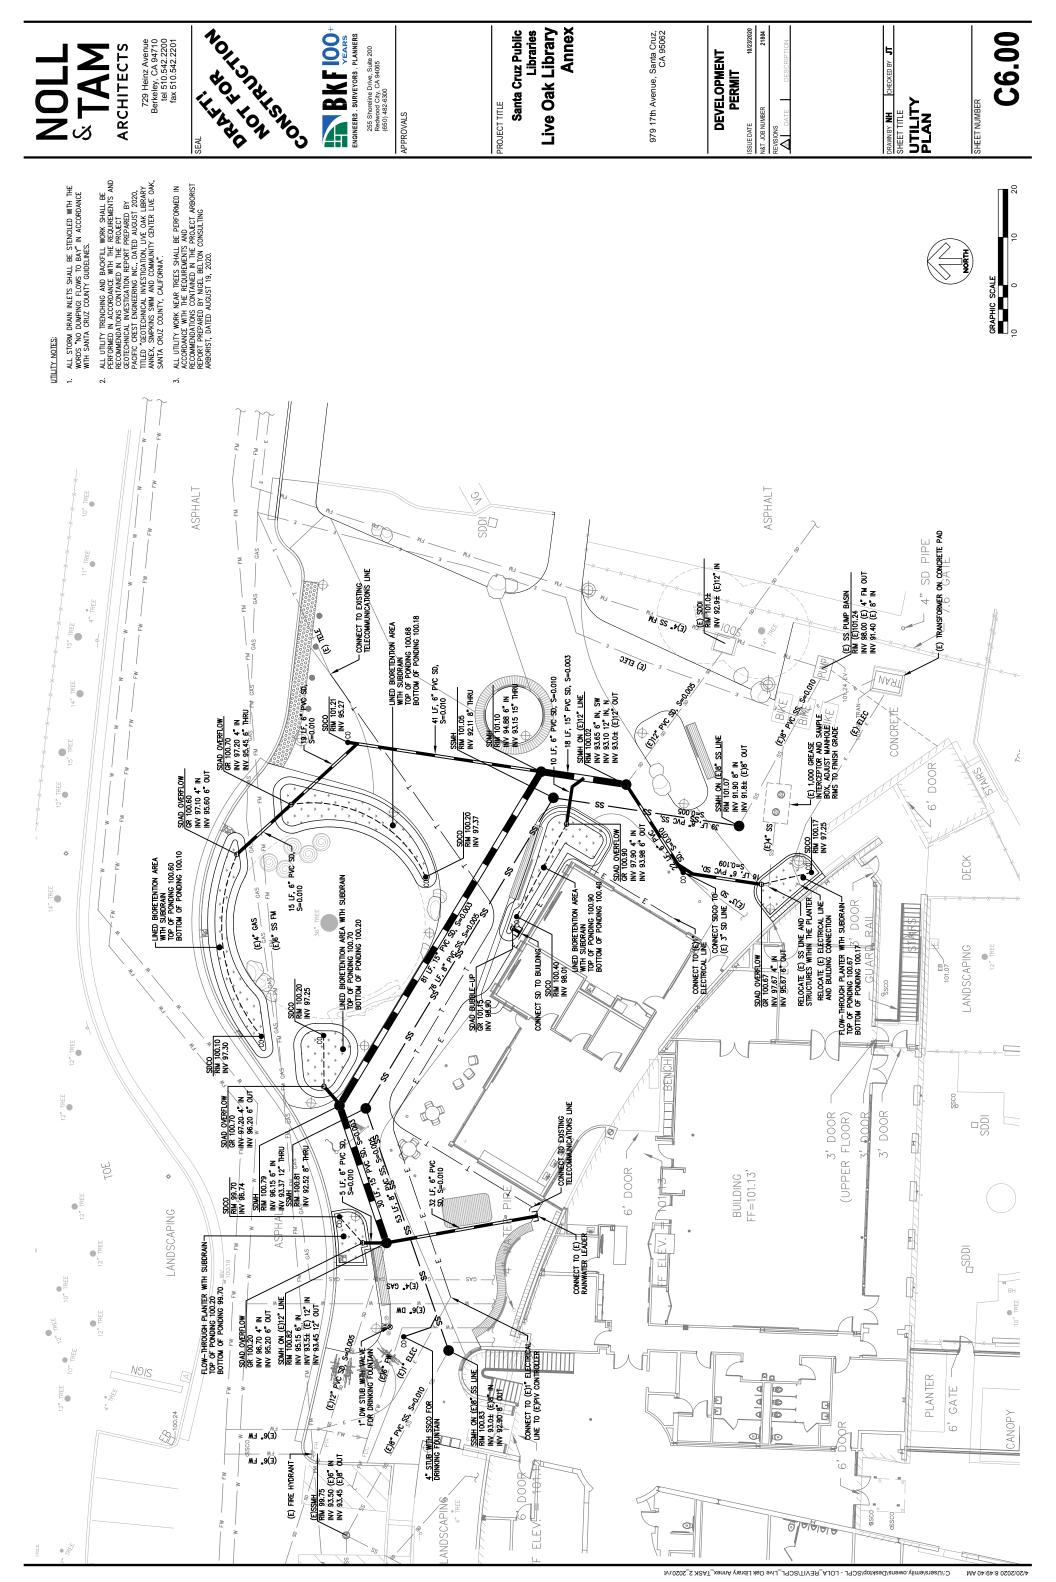
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DEVELOPMENT PERMIT

N&T JOB NUMBER

DRAWNBY NH CHECKED BY JT SHEET TITLE
STORMWATER
CONTROL PLAN

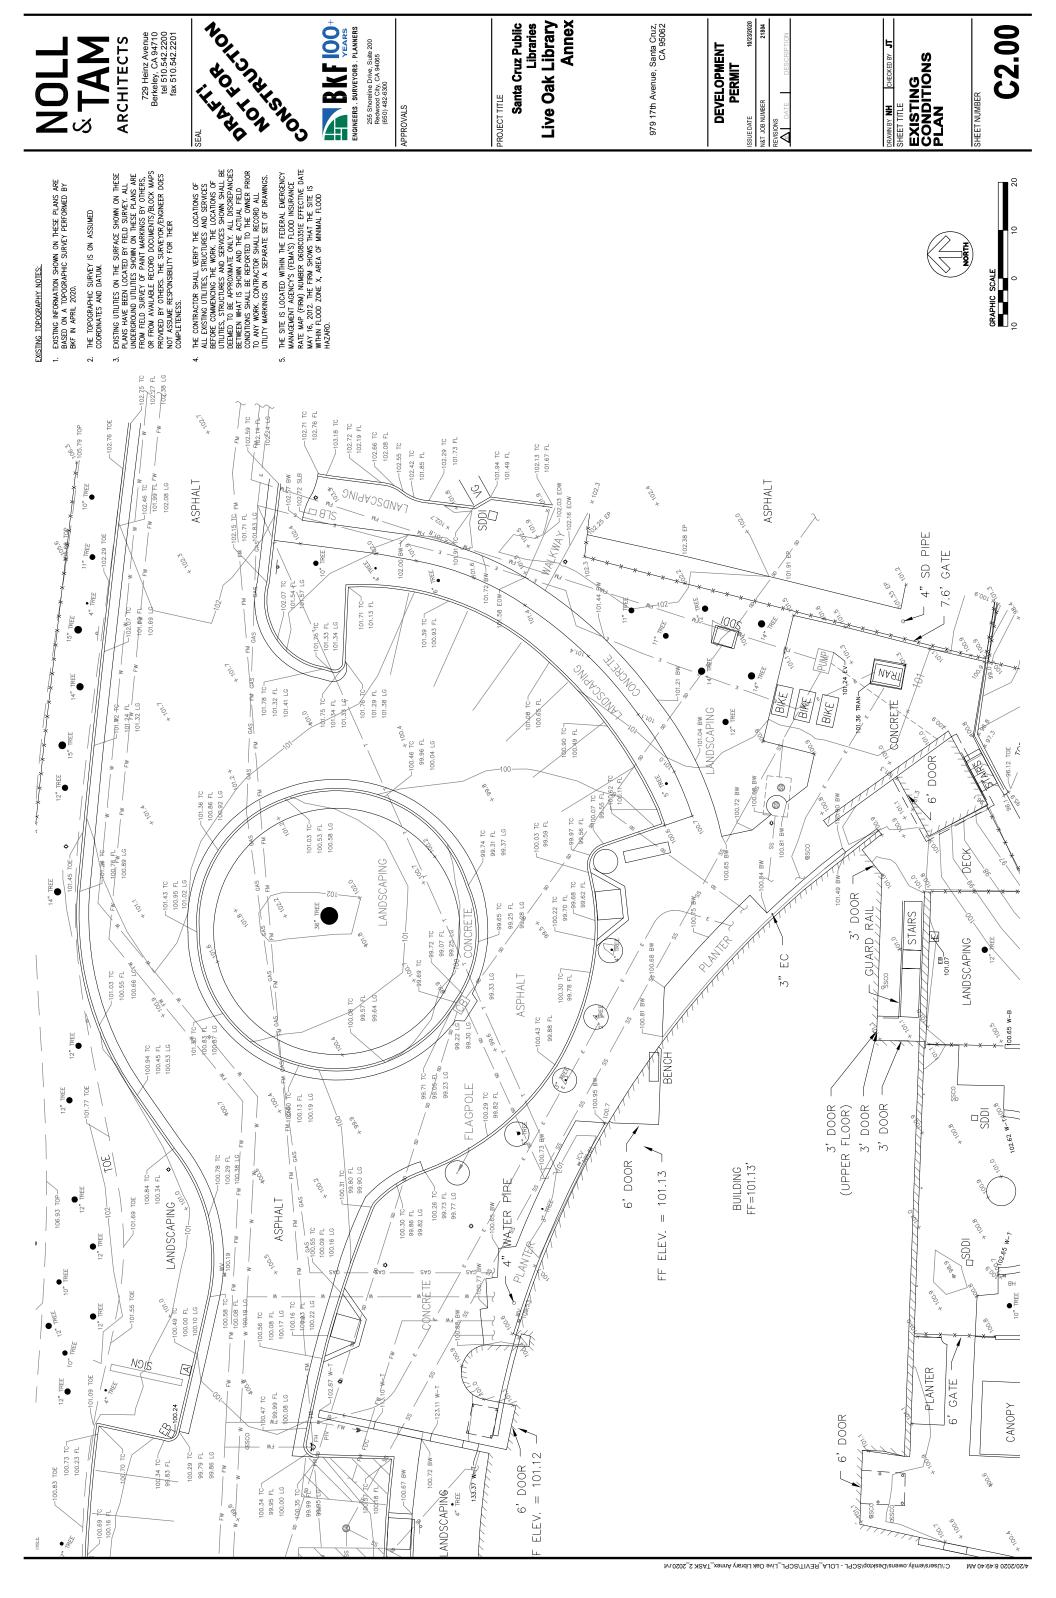SHEET NUMBER

# AREA OF WORK SUMMARY

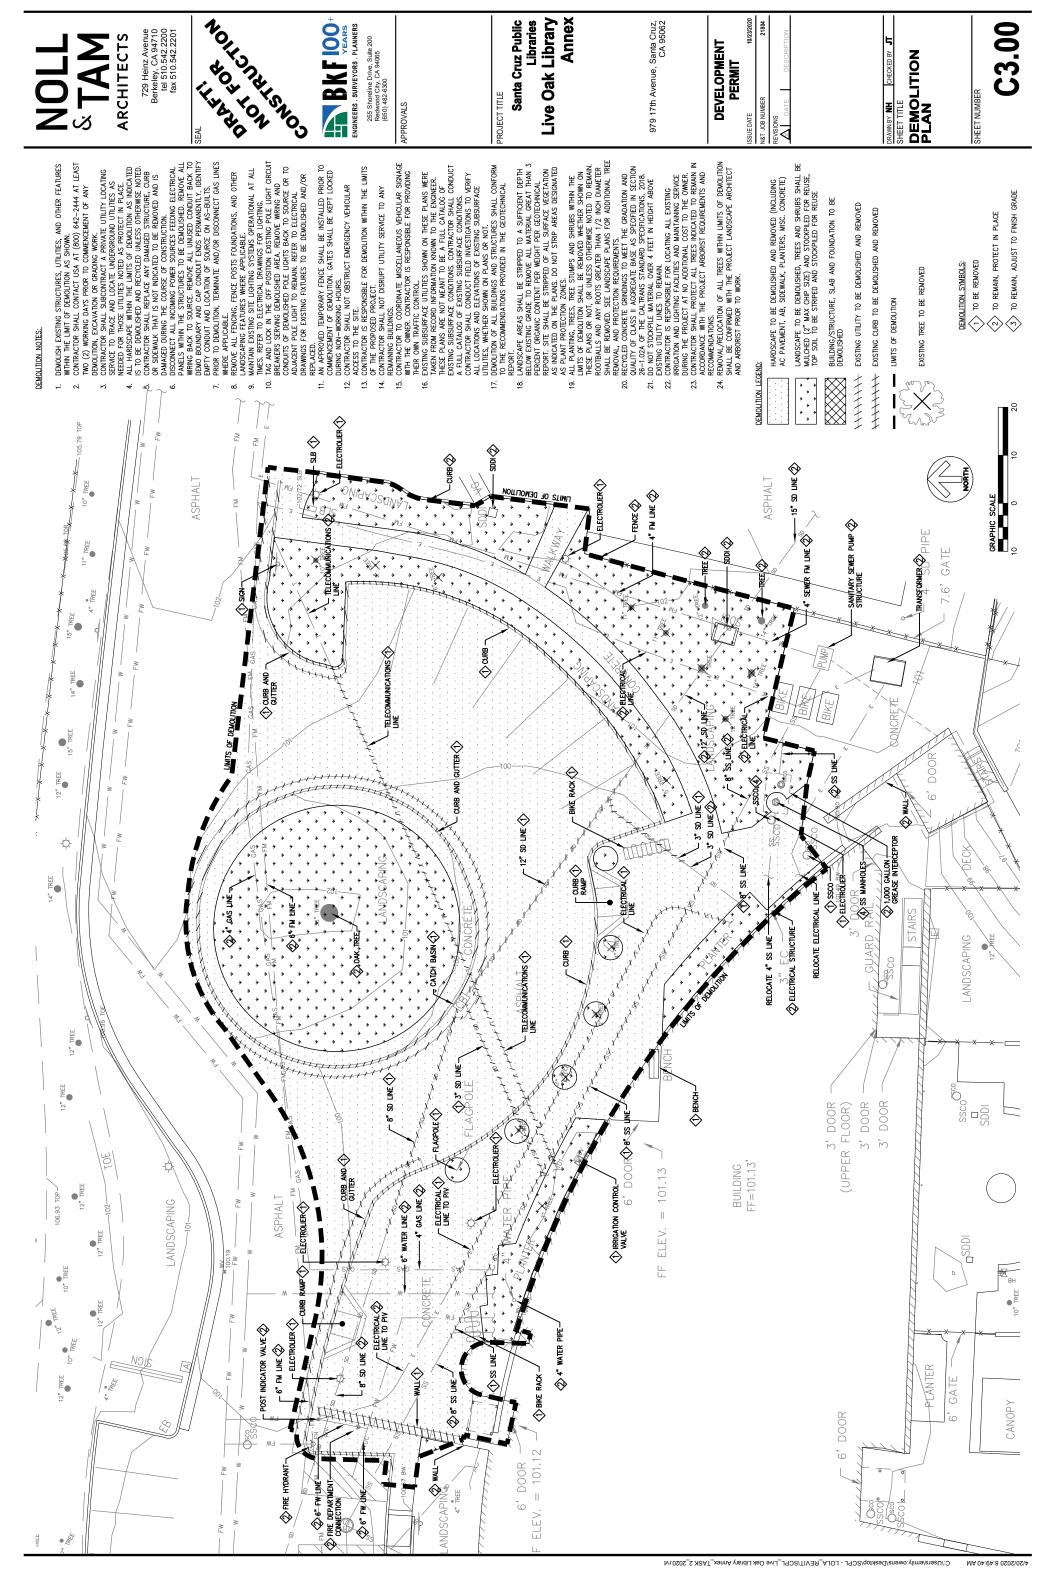1. ALL STORM DRAIN INLETS SHALL BE STENCILED WITH THE WORDS "NO DUMPING! FLOWS TO BAY" IN ACCORDANCE WITH SANTA CRUZ COUNTY GUIDELINES.

UTILITY NOTES:

	PERVIOUS AREA	IMPERVIOUS AREA	TOTAL AREA
PHASE 1 EXISTING CONDITIONS	5,649	11,217	16,866
PHASE 1 PROPOSED CONDITIONS	4,824	12,042	16,866
PHASE 2 EXISTING CONDITIONS	4,008	4,491	8,449
PHASE 2 PROPOSED CONDITIONS	4,397	4,102	8,449

SUMMARY	
TREATMENT	
STORMWATER	

PHASE 1

-LINED BIORETENTION AREA 2 WITH SUBDRAIN (C6.0)

12" TREE 14" TREE 15"

14" TREE

PROVIDED TREATMENT AREA	299	175
MPERVIOUS AREA REQUIRED TREATMENT (SF) AREA (SF)	482	165
IMPERVIOUS AREA (SF)	12,042	4,102
	PHASE 1 AREA OF WORK	PHASE 2 AREA OF WORK

# NOTES:

VED BIORETENTION 2
REA WITH SUBDRAIN (C6.01)

- 60° /

(E) 12 S

FLOW-THROUGH PLANTER-WITH SUBRDRAIN

LINED BIORETENTION AREA (2.01)

WAT LYMEY OR

**39** 

SELOW—THROUGH PI (G.01) WITH SUBRDRAIN

CHILD

(E) BUILDING

<sup>1.</sup> CALCULATIONS ARE BASED ON SANTA CRUZ COUNTY DESIGN CRITERIA FOR VOLUME BASED APPROACH.



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2"-5" DIAMETER RIVER ROCK, GROUT IN PLACE, COLOR TO BE DETERMINED BY LANDSCAPE ARCHITECT

FINISH GRADE-

PLANTING PER LANDSCAPE PLANS

SDAD BUBBLE—UP, —— REFER TO UTILITY PLAN FOR LOCATIONS

SITE RUNOFF, SEE

NOHONAHSNOO il de la constantina della con

ENGINEERS SURVEYORS PLANNERS

-WATERPROOF LINER (VISQUEEN UDG, OR APPROVED EQUAL) ALONG SIDES, INSTALL PER MANUFACTURER'S RECOMMENDATIONS, TYP.

4" PERFORATED PVC SUBDRAIN, SLOPE 0.50% MIN, WITH PERFORATIONS DOWN. PLACE SUBDRAIN AT BOTTOM OF CLASS II PERMEABLE ROCK LAYER.

1. STORM DRAIN BUBBLE-UP BOX SHALL BE CENTRAL PRECAST OR APPROVED EQUAL.

NOTES:

CROSS SECTION AT BUBBLE -UP STRUCTURE

WATERPROOF LINER (VISQUEEN UDG, OR APPROVED EQUAL) ALONG BOTTOM, INSTALL PER MANUFACTURER'S RECOMMENDATIONS

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L PIPE TO SITE STORM DRAIN SYSTEM, SEE UTILITY PLAN

L4" PERFORATED PVC SUBDRAIN, SLOPE 0.50% MIN, WITH PERFORATIONS DOWN, PLACE SUBDRAIN AT BOTTOM OF CLASS II PERMEABLE ROCK LAYER

WATERPROOF LINER (VISQUEEN UDG, OR APPROVED EQUAL) ALONG BOTTOM, INSTALL PER MANUFACTURER'S RECOMMENDATIONS

STORMWATER DETAILS DRAWN BY NH SHEET TIT! "


**C7.01** SHEET NUMBER

DEVELOPMENT 4&T JOB NUMBER ISSUE DATE

424" MIN BIORETENTION PLANTING MEDIUM, MINIMUM 5" INCHES PER HOUR INFILTRATION RATE 12" MIN CLASS II PERMEABLE ROCK 6" PONDING DEPTH SDAD OVERFLOW, REFER TO UTILITY PLAN FOR LOCATIONS BUBBLE-UP STRUCTURE AT LINED BIORETENTION AREA AND LINED FLOW-THROUGH PLANTER SUBDRAIN CLEANOUT WITH THREADED CAP, SET RIM AT BOTTOM OF PONDING ELEVATION PLANTING PER LANDSCAPE PLANS 1 MAX WATERPROOF LINER (VISQUEEN UDG, OR APPROVED EQUAL) ALONG SIDES, INSTALL PER MANUFACTURER'S RECOMMENDATIONS, TYP. 2"-5" DIAMETER RIVER ROCK, GROUT IN PLACE, COLOR TO BE DETERMINED BY LANDSCAPE ARCHITECT

CURB AND GUTTER, TWHERE OCCURS FINISH GRADE



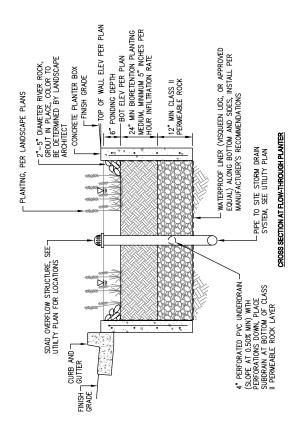

3 LINED FLOW-THROUGH PLANTER

- N.T.S.

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SHEET TIT

SHEET NUMBER

CONSTRUCTION DETAILS

979 17th Avenue, Santa Cruz, CA 95062 DEVELOPMENT PERMIT N&T JOB NUMBER ISSUE DATE REVISIONS

UPPER 12" OF SUBGRADE SOIL SHALL BE MOISTURE CONDITIONED TO ONE TO THREE PERCENT ABOVE OPTIMUM MOISTURE AND RECOMPACIED TO A MINIMUM OF 95% RELATIVE COMPACITION BASED ON ASTIM TEST METHOD D1557. PRIOR TIO FINAL CONSTRUCTION, SUBGRADE SURFACE SHALL BE PROOF ROLLED TO PROVIDE SMOOTH, FIRM SUPPORT. . #4 x 18" SMOOTH DOWEL WITH PAPER SLEEVES AND CORK AT ONE END ◎ 24" O.C. FOR PEDESTRIAN . <sub>4</sub> 1/4" ¼" RADIUS, TYPICAL — ALL EDGES #4 REBAR AT 18" O.C. BOTH WAYS. X。EXPANSION MATERIAL— AND JOINT SEALANT TO BE FLUSH WITH FINISH SURFACE, TYP

OF PAVEMENT
ABOVE LIP
-FULL DEPTH AC/-EXISTING AC

EDGE 1/4

-R=1/2" (TYP)

1.25"

SAWCUT

1" BATTER —

#4 X 12" SLIP DOWELS @ — EXPANSION JOINTS TO BE 40' O.C. (TYP) CENTER AT JOINT

18,

EXISTING AB

CLASS II AB

NIW

6" CL II AB 95% RELATIVE COMPACTION

4" CONCRETE

# EXPANSION JOINT (EJ)

NOTES:

1. CONCRETE CURBS SHALL BE EMBEDDED AT LEAST FOUR INCHES BELOW SOIL SUBGRADE

1. CELLOW THE BOTTOM OF THE ACCRECATE BASE SECTION) IN ANY AREAS WHERE IRRICATED


LANDSCAPE AREAS ARE ADJACENT TO AC PAVEMENTS.

2. CURB AND GUTTER SHALL BE IN ACCORDANCE WITH THE COUNTY OF SANTA CRUZ DESIGN

CRITERIA.

CURB & GUTTER

ကြ

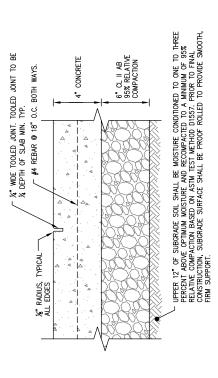

# SCORE JOINT ISJ

NOTES:

INTERRUPT REINFORCING STEEL AT EXPANSION JOINT.
LOCATE COLD JOINTS ONLY AT EXPANSION JOINT OR SCORE JOINT LOCATIONS AS
INDICATE ON LAYOUT PLAN. LOCATE COLD JOINTS AT EXPANSION JOINTS WHERE POSSBILE.
IF COLD JOINTS ARE LOCATED AT SCORE JOINT JOCATIONS AS SHOWN ON LAYOUT PLAN.
REBAR CAN BE EXTENDED THROUGH THE JOINT AND STEEL DOWELS CAN BE ELIMINATED.

CONCRETE CURBS SHALL BE EMBEDDED AT LEAST FOUR INCHES BELOW SOIL SUBGRADE (BELOW THE BOTTOM OF THE AGGREGATE BASE SECTION) IN ANY AREAS WHERE IRRIGATED LANDSCAPE AREAS ARE ADJACENT TO AC PAVEMENTS.

FLUSH CURB

**4** 1

CLASS II AB
C2 = #4 x 12" SLIP DOWELS
CEXPANSION JOINTS (TYP)

NIM


AC PAVING

TC GRADE SHOWN ON PLANS

~1/2" R





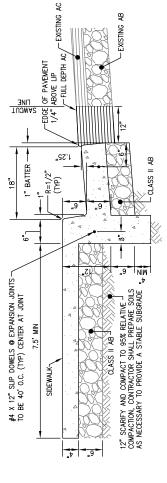

NOTES:

CURB, GUTTER, AND SIDEWALK SHALL BE IN ACCORDANCE WITH THE COUNTY OF SANTA CRUZ DESIGN CRITERIA.

CURB & GUTTER WITH SIDEWALK (N I)

-CONFORM TO (E) AC AFLUSH CURB VEHICULAR CONCRETE 3' DETECTABLE WARNING SURFACE

DROP-OFF CROSS SECTION (D)

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# STABILIZED CONSTRUCTION ENTRANCE/FENCE TEMPORARY CONSTRUCTION FENCE WITH SILT CAPTURE WOKEN GEOTEXTILE FARRIC ON BOTTOM OF FENCE, TPP. CONTRACTOR TO MAINTAIN AND ADJUST AS NEEDED.

0

œsco

- INLÉT PROTECTION, TYP. (4) 00

4" "REE

0

EROSION CONTROL NOTES:

ALL WORK SHALL BE DONE IN ACCORDANCE WITH THE PROJECT SPECIFICATIONS. EROSION CONTROL PLAN AND MEASURES TO MEET COUNTY OF SANTA, CRUZ REQUIREMENTS.

THE INTENT OF THESE PLANS IS TO PROVIDE THE INITIAL CONCEPT FOR INTERIM EROSION CONTROL. THE CONTRACTOR SHALL UPDATE THE PLANS TO REFLECT CHANGING STILE CONDITIONS. PLAN UPDATES SHALL BE BASED UPON GENERAL SIRKEY DATA, EROSION CONTROL EFFECTIVENESS SHALL ALSO BE MONTORED AND THE PLANS UPGRADED AS REQUIRED TO PREVENT SIGNIFICANT QUANTITIES OF SEDIMENT FROM ENTERING THE DOWNSTREAM DRAINGES SYSTEM. ALTHOUGH SPECIFIC LOCATIONS FOR SEDIMENT CONTROL FACILITIES ARE SHOWN ON THESE PLANS, IT IS INTENDED THIS EROSION CONTROL PLAN BE MODIFIED WHEN NECESSARY TO MEET FIELD CONDITIONS.

THIS PLAN MAY NOT COVER ALL THE SITUATIONS THAT ARISE DURING CONSTRUCTION DUE TO UNANTICIPATED FIELD CONDITIONS. IN GENERAL, THE CONTRACTOR IS RESPONSIBLE FOR KEEPING. THE STORGE WEN OF SEDIARY FROM LEAVING THES INFERS AND BASS, AND SILT FENCES SHALL BE USED BY THE CONTRACTOR ON AN AS NEEDED BASS TO INHIBIT SILT FROM LEAVING THE SITE AND ENTERING THE STORM DRAIN SYSTEM, ALL EXISTING, TEMPORARY, OR PERMANENT CATCH BASINS SHALL USE ONE OF THE SEDIMENT BARRIERS SHOWN.

THE CONTRACTOR WILL BE LIABLE FOR ANY AND ALL DAMAGES TO PUBLIC AND/OR PRIVATE OWNED AND MAINTAINED ROAD CAUSED BY THE CONTRACTOR'S PAINNG ACTIVITES, AND WILL BE RESPONSIBLE FOR THE CLEANUP OF ANY MATERIAL SPILLED ON ANY PUBLIC ROAD ON THE HAUI ROUTE. ADJACENT PUBLIC ROADS SHALL BE CLEANED AT THE END OF EACH WORKING DAY.

BEST MANAGEMENT PRACTICES SHALL BE OPERABLE YEAR AROUND.

DURING THE RAINY SEASON, ALL PAYED AREAS ARE TO BE KEPT CLEAR OF EARTH MATERIAL AND DEBRIS. THE SITE IS TO BE MAINTAINED SO AS TO MINIMIZE SEDIMENT-LADEN RUNGFF TO ANY STORM DRAIN SYSTEM.

ALL EROSION CONTROL FACILITES MUST BE INSPECTED AND REPAIRED DAILY DURING THE RAINY SEASON. ALL SLOPES SHALL BE REPAIRED SOON AS POSSIBLE WHEN DAMAGED.

WATER ALL ACTIVE CONSTRUCTION AREAS AT LEAST TWICE DAILY.

COVER ALL TRUCKS HAULING SOIL, SAND, AND OTHER LOOSE MATERIALS OR REQUIRE ALL TRUCKS TO MAINTAIN AT LEAST TWO FEET OF FREEDOARD.

APPLY WATER AS NEEDED, OR AS DIRECTED BY ENGINEER, OR APPLY NON-TOXIC SOIL STABILIZERS ON ALL UNPAVED ACCESS ROADS, PARKING AREAS, AND STAGING AREAS AT THE CONSTRUCTION STE.

SWEEP (WITH WATER SWEEPERS) AS NEEDED, OR AS DIRECTED BY ENGINEER, ALL PAVED ACCESS ROADS, PARKING AREAS, AND STAGING AREAS AT THE CONSTRUCTION SITES. 15.

SWEEP PUBLIC STREETS ADJACENT TO CONSTRUCTION SITES DAILY (WITH WATER SWEEPERS) IF VISIBLE SOIL MATERIAL IS CARRIED ONTO THE STREETS.

LIMIT TRAFFIC SPEEDS ON UNPAVED ROADS TO 15 MILES PER HOUR.

13.

Pulled

FIBER ROLL, TYP (1)

(E)FENCE

INSTALL SANDBAGS OR OTHER EROSION CONTROL MEASURES TO PREVENT SILT RUNOFF TO PUBLIC ROADWAYS.

INSTALL WHEEL WASHERS FOR ALL EXTING TRUCKS OR WASH OFF THE TIRES OR TRACKS OF ALL TRUCKS AND EQUIPMENT LEAVING THE CONSTRUCTION SITE AS NEEDED, OR AS DRECTED BY ENGINEER.

INSTALL WIND BREAKS AT THE WINDWARD SIDES OF THE CONSTRUCTION AREAS.

MANTAN EROSION CONTROL WEASURES, CONTINUOUSIX YEAR ROUND DIGNIC CONSTRUCTION ACTIVITES, STABLIZING SHALL INCLUDE BOTH PROACTIVE MEASURES, SUCH AS THE PLACEMENT OF STRAW BALES OF ORD NETTING, AND PASSIVE MEASURES, SUCH AS MINIMIZING VEGETATION FRANCHAL AND REVEGETATION DIVIDED AREAS WIN VEGETATION THAT IS COMPATIBLE WITH THE SURROUNDING ENVIRONMENT.

STORE, HANDLE, AND DISPOSE OF CONSTRUCTION MATERIALS AND WASTES PROPERLY, SO AS TO PREVENT THEIR CONTACT WITH STORMWATER.

MATCH EXISTING GRAD

CONTROL AND PREVENT THE DISCHARGE OF ALL POTENTIAL POLLUTANTS, INCLUDING PAKENENT CUTTING WASTES, PAINTS, CONOREIE, PETROLEUM PRODUCTS, CHEMICALS, WASH WATER OR SEDIMENTS, AND NON-STORMWATER DISCHARGES TO STORM DRAINS AND WATERCOURSES.

USE SEDIMENT CONTROLS OR FILTRATION TO REMOVE SEDIMENT WHEN DEWATERING SITE AND OBTAINING ALL NECESSARY PERMITS.

AVOID CLEANING, FUELING, OR MAINTAINING VEHICLES ON—SITE, EXCEPT IN A DESIGNATED AREA WHERE WASH WATER IS CONTAINED AND TREATED. 23. PROTECT ADJACENT PROPERTIES AND UNDISTURBED AREAS FROM CONSTRUCTION IMPACTS USING VEGETATIVE BUFFER STRIPS, SEDIMENT BARRIERS OR FILTERS, DIKES, MULCHING, OR OTHER MEASURES AS APPROPRIATE. 25.

PERFORM CLEARING AND EARTH-MOVING ACTIVITIES ONLY DURING DRY WEATHER.

FIBER ROLLS TIGHTLY WRAPPED

SEDIMENT TRAP TRENCH

DRAIN — GRATE

STABILIZED CONSTRUCTION ENTRANCE/EXIT WITH WASHOUT AREA, PER DETAIL 2

FIBER ROLL, PER DETAIL 1

TIRE/TRUCK TEMPORARY WASHOUT PIT, PER DETAIL 3

INLET PROTECTION, PER DETAILS 4

 $\mathbb{C}$ 

TEMPORARY CONSTRUCTION FENCING WITH SILT CAPTURE WOVEN GEOTEXTILE FABRIC ON BOTTOM, CONTRACTOR TO MAINTAIN DURING DURATION OF CONSTRUCTION.

SLOPE (2.5:1)-

LIMIT AND TIME APPLICATIONS OF PESTICIDES AND FERTILIZERS TO PREVENT POLLUTED RUNOFF.

LIMIT CONSTRUCTION ACCESS ROUTES AND STABILIZE DESIGNATED ACCESS POINTS.

IF NO WORK HAS PROCRESSED FOR A PERIOD OF 6-WEEKS, FINAL DRAINAGE AND EROSION CONTROL IMPROVEMENTS SHALL BE INSTALLED IN ACCORDANCE WITH AN APPROVED WINTERIZATION PLAN.

HAUL ROADS ARE CURRENTLY NOT SHOWN ON THE PLANS. EROSION CONTROL MEASURES SHALL BE TAKEN TO MINIMIZE EROSION RELATED TO HAUL ROADS.

THE NAME, ADDRESS, AND 24 HOUR TELEPHONE NUMBER OF THE PERSON RESPONSBLE FOR IMPLEMENTATION OF EROSION AND SEDIMENTATION CONTROL PLAN SHALL BE PROVIDED TO THE CITY.

SHOULD IT APPEAR THAT THE EROSION CONTROL PLAN, OR ANY OTHER WATTER THERETO, IS NOT SUFFICIENTLY DETAILED OR EXPLAINED ON THESE PLANS, THE CONTRACTOR SHALL CONTRACT THE ENCINEER FOR SUCH FURTHER EXPLANATIONS AS MAY BE NECESSARY.

-EMBED FIBER ROLL 3"-5" INTO SOIL. (SEE FIBER ROLL DETAIL E4)

PONDING HEIGHT

PLAN VIEW

- FIBER ROLLS

WOOD STAKES OR METAL REBAR.

PROVIDE 1' WIDE BY 6" DEEP SEDIMENT TRAP TRENCH AROUND INLET

ISSIL FILTER<sup>1</sup>

SLOPE (2.5:

SECTION A - A

NOTES:

-MAX. WATER LEVEL. PUMP OUT WHEN IT REACHES THIS LEVEL. WATERPROOF PLASTIC MEMBRANE MIRAFI, MCF1212, OR APPROVED EQUAL. TIRE/TRUCK TEMPORARY WASHOUT PIT

SECTION A-A

1. PLACE FIBER ROLLS AROUND THE INLET CONSISTENT WITH BASIN SEDIMENT BARRIER DETAIL ON THIS SHEET. FIBER ROLLS ARE TUBES MADE FROM STRAW BOUND W/ PLASTIC NETTING. THEY ARE APPROXIMATETY 8" DIA. AND 20 – 30 FT. LONG.

2. FIBER ROLL INSTALLATION REQUIRES THE PLACEMENT AND SECURE STAKING OF THE FIBER ROLL IN A TRENDH, 3" – 5" DEEP, DUG ON CONTONE. RUNDET MUST NOT BE ALLOWED TO RUN UNDER OR AROUND FIBER ROLL.

3. THE TOP OF THE STRUCTURE (PONDIN HEIGHT) MUST BE WELL BELOW THE GROUND ELEVANDO DOWNSLOPE TO PREVENT RUNDEF REM BY "A TEMPORARY DIKE ON THE DOWNSLOPE OF THE STRUCTURE MAY BE NECESSARY.

4. FOSSIL FILTERS SHALL BE INCORPORATED IN ALL CATCH BASINS AND FIELD INLETS 24" AND LARGER AND SHALL BE INSTALLED PER WANUFACTURER SPECIFICATIONS. FOSSIL FILTERS TO BE SILT SACK OR APPROVED EQUIVALENT.

**INLET PROTECTION** 

4

1/20/2020 8:49:40 AM

# ENTRENCHMENT DETAIL IN FLAT AREA ENTRENCHMENT DETAIL IN SLOPE AREA

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**ARCHITECTS** 

REQUIRES THE PLACEMENT AND SECURE STAKING OF THE ROLL IN A TRENCH, 3" TO 4" DEEP.
RIN PARALLE TO THE CONTOUR.
2. INSTALL FIBER ROLL FROM THE BOTTOM OF THE SLOPE AND WORK UP. USE A STRAIGHT BAR
TO DRIVE HOLES THROUGH THE FIBER ROLL AND INTO THE SOLL FOR WOODEN STAKES. DRIVE
THE STAKE THROUGH THE PREPARED HOLE NITO THE SOLL.
3. LEAVE ONLY ONE OR TWO INCHES OF STAKE EXPOSED ABOVE FIBER ROLL.
5. ADJACENT FIBER ROLLS SHALL BE TIGHTY ABUT.
6. ADJACENT FIBER ROLLS SHALL BE TIGHTY ABUT.
7. INSTALL AT LOCATIONS SHOWN ON PAINS.
8. IN SLOPE AREAS SPACE FIBER ROLLS EVERY TO VERTICAL FEET ON SLOPE.

NOHONALSNOO -

IL WALL

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BKF 100

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**APPROVALS** 

3"-6" CRUSHED AGGREGATE MINIMUM 12" THICK 50' MINIMUM OR FOUR TIMES THE CIRCUMFERENCE OF THE LARGEST CONSTRUCTION VEHICLE TIRE, WHICHEVER IS GREATEI FIBER ROLL

SECTION A-A 3"-6" CRUSHED --AGGREGATE

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NOTES:

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DEVELOPMENT PERMIT

TOP DRESSNIG WITH ADDITIONAL STONE AS CONDITIONS DEMAND, AND REPAIR AND/OR CLEANOUT OF ANY MEASURES USE TO TRAP SEDIMENT, ALL SEDIMENT SPILLED, ROGPPED, WASHED, OR WELCOKED ONTO PUBLIC RIGHT-OF-WAYS SHALL BE REMOVED IMMEDIATELY.

WHELLS SHALL BE CLEAN PRORY TO ENTRANCE ONTO PUBLIC RIGHT-OF-WAYS. WHEN WASHING IS REQUIRED, IT SHALL BE DONE ON AN AREA STABILIZED WITH CRUSHED STONE THAT DRANKS INTO AN APPROVED SEDIMENT TRAP OR SEDIMENT BASIN. ALL SEDIMENT SHALL BE PREVENTED FROM BENTERING ANY STORMA PORTONE. THAT OR SEDIMENT SHALL BE PREVENTED FROM SENIENG ANY STORMA PORTONE. THE PROJECTION (E.G. SAND BAGS OR OTHER APPROVED METHODS).

MATERIAL FOR CONSTRUCTION OF THE PAD SHALL BE 3° TO 6° STONE. THICKNESS OF THE PAD SHALL NOT BE LESS THAN 12°. WIDTH OF THE PAD SHALL NOT BE LESS THAN THE FULL WOTH OF ALL POINTS OF INGRESS EGRESS. SAND BAGS OR OTHER APPROVED WETHODS).
THE MATERIAL FOR CONSTRUCTION OF THE PAD SHALL BETHE THICKNESS OF THE PAD SHALL NOT BE LESS THAN THE MOTH OF THE PAD SHALL NOT BE LESS THAN THE FOR ERESS.

THE LENGTH OF THE PAD SHALL NOT BE LESS THAN 56°.

STABILIZED CONSTRUCTION ENTRANCE/EXIT ์(ณ


ALL EROSION CONTROL MEASURES SHALL BE IN PLACE BY OCTOBER 15 AND MAINTAINED DURING ALL PHASES OF CONSTRUCTION.

EROSION CONTROL PLAN

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42

EROSION CONTROL LEGEND:

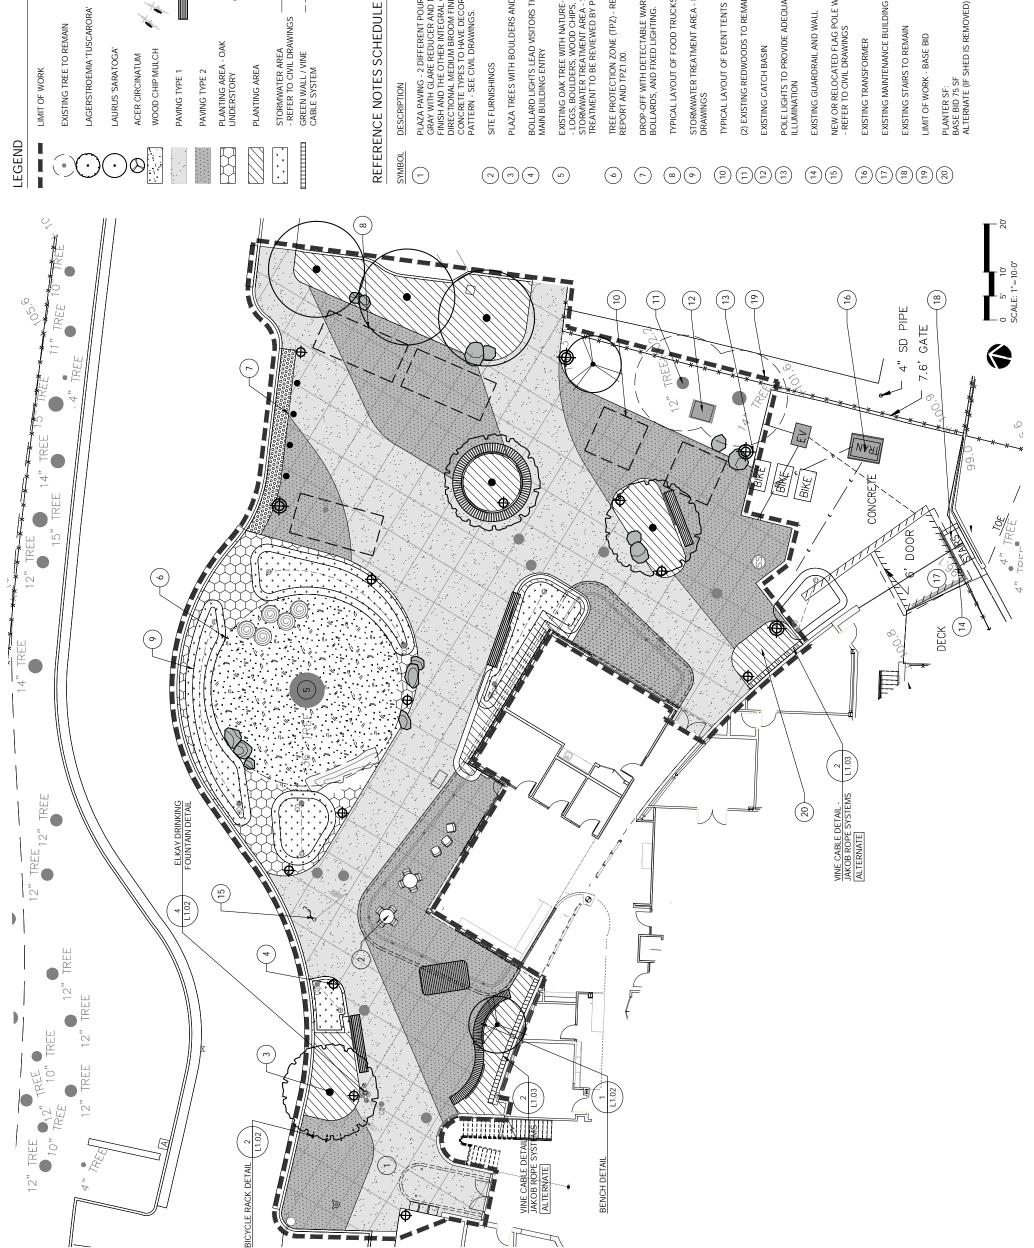

LAGERSTROEMIA 'TUSCARORA' **EXISTING TREE TO REMAIN** LIMIT OF WORK

BOLLARD LIGHT

 $\Phi$ 

POLE LIGHT BOULDER

LAURUS 'SARATOGA

WOOD CHIP MULCH ACER CIRCINATUM

729 Heinz Avenue Berkeley, CA 94710 tel 510.542.2200 fax 510.542.2201

**BICYCLE PARKING** 

**ARCHITECTS** 

PAVING TYPE 1

BENCH

000 PLANTING AREA - OAK UNDERSTORY PLANTING AREA

NOHOUSTENOOD

KAN TON

STUMPS FOR SEATING

**DRINKING FOUNTAIN** FLAG POLE - REFER TO CIVIL DRAWINGS **EXPANSION JOINT** SCORE JOINT STORMWATER AREA
- REFER TO CIVIL DRAWINGS
GREEN WALL / VINE
CABLE SYSTEM **APPROVALS** 

JONI L. JANECKI

PROJECT TITLE

Santa Cruz Public

PLAZA TREES WITH BOULDERS AND PLANTING BELOW

SITE FURNISHINGS

BOLLARD LIGHTS LEAD VISITORS THROUGH SITE TO MAIN BUILDING ENTRY

PLAZA PAVING - 2 DIFFERENT POURS. ONE NATURAL GRAY WITH GLARE REDUCER AND MEDIUM BROOM FINISH AND THE OTHER INTEGRAL COLOR WITH DIRECTIONAL MEDIUM BROOM FINISH. BOTH CONCRETE TYPES TO HAVE DECORATIVE JOINT PATTERN - SEE CIVIL DRAWINGS.

DESCRIPTION

Annex **Live Oak Library** Libraries

EXISTING OAK TREE WITH NATURE-INSPIRED PLAY AREA - LOGS, BOULDERS, WOOD CHIPS, PLANTING AND STORMWATER TREATMENT AREA - STORMWATER TREATMENT TO BE REVIEWED BY PROJECT ARBORIST

979 17th Avenue, Santa Cruz, CA 95062

DROP-OFF WITH DETECTABLE WARNING, COLLAPSIBLE BOLLARDS, AND FIXED LIGHTING.

TREE PROTECTION ZONE (TPZ) - REFER TO ARBORIST REPORT AND TPZ1.00.

CD PROGRESS

STORMWATER TREATMENT AREA - REFER TO CIVIL DRAWINGS

TYPICAL LAYOUT OF FOOD TRUCKS

10/16/2020 21804 DESCRIPTION JOB NUMBER ISSUE DATE

NEW OR RELOCATED FLAG POLE WITH UPLIGHTS - REFER TO CIVIL DRAWINGS

POLE LIGHTS TO PROVIDE ADEQUATE PLAZA ILLUMINATION

**EXISTING GUARDRAIL AND WALL** 

C:/Users/emily.owens/Desktop/SCPL - LOLA\_REVIT/SCPL\_Live Oak Library Annex\_TASK 2\_2020.rvt

TyPROJECTS/18-990.N8:T-Live Oak Library Annex/Drawings/Live Oak Library Annex Landscape:dwg. L1.00; 10/16/2020 3:23:09 PM; DWG To PDF. pc3, ANSI full bleed D (22:00 x 34:00 Inches): 1:1

(2) EXISTING REDWOODS TO REMAIN

**EXISTING CATCH BASIN** 

TYPICAL LAYOUT OF EVENT TENTS

**EXISTING MAINTENANCE BUILDING TO REMAIN** 

**EXISTING STAIRS TO REMAIN** LIMIT OF WORK - BASE BID PLANTER SF: BASE BID 75 SF ALTERNATE (IF SHED IS REMOVED): 83 SF

LANDSCAPE ENLARGEMENT PLAN DRAWN BY MM/MO CHECKED BY GL SHEET TITLE

MOHOWARTH CONSTRAINT C 729 Heinz Avenue Berkeley, CA 94710 tel 510.542.2200 fax 510.542.2201













BONLDERS

WATER WASH BOULDERS

риілач









VINE CABLE SYSTEMS: JAKOB

METAL INLAY OR SANDBLASTED/ETCHED DESIGN

GREEN WALL

METAL INLAY



BIKE BYCK







MANUFACTURER: FORMS AND SURFACES PRODUCT: APEX RECEPTACLE





REMOVABLE BOLLARD

MANUFACTURER: GROUND CONTROL PRODUCT: FIBERGLASS BIKE VAULT® BICYCLE LOCKER





Santa Cruz Public
Libraries
Live Oak Library
Annex



SANDED TREE STUMPS

MANUFACTURER: STREETLIFE PRODUCT: SOLID SERIF CHAISE LONGUE



979 17th Avenue, Santa Cruz, CA 95062

21804

JOB NUMBER ISSUE DATE

100% DESIGN DEVELOPMENT

DESCRIPTION






LANDSCAPE MATERIALS IMAGES

DRAWN BY OW CHECKED BY GL SHEET TITLE

MANUFACTURER: LANDSCAPE FORMS PRODUCT: TORRES PATH LIGHT

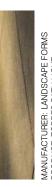























MANUFACTURER: FORMS + SURFACES PRODUCT: LIGHT COLUMN PEDESTRIAN LIGHTING AND BOLLARD

MANUFACTURER: LANDSCAPE FORMS PRODUCT: MOTIVE AREA LIGHT AND PATH LIGHT





MANUFACTURER: ELKAY PRODUCT: OUTDOOR BOTTLE FILLING STATION TRI-LEVEL PEDESTAL NUMBER: LK4430BF1U

**DRINKING FOUNTAIN** 

SOURCE: ANNIESANNUALS.COM

OAK UNDERSTORY

FESTUCA CALIFORNICA (CALIFORNIA FESCUE)



RIBES SANGUINEUM (RED FLOWERING CURRANT)



RIBES VIBURNIFOLIUM (EVERGREEN CURRANT)





RUDBECKIA FULGIDA (BLACK-EYED SUSAN) SOURCE: MONROVIA. COM













SALVIA CLEVELANDII 'ALAN CHICKERING' (SAGE)












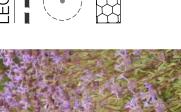







(ESCALLONIA) SOURCE: MONROVIA.COM

(LEMON DROPS FORTNIGHT LILY) SOURCE: BOETHINGTREELAND.COM DIETES HYBRIDA 'LEMON DROPS'

(AUSTRALIAN FUCHSIA) SOURCE: BOETHINGTREELAND.COM

CORREA IVORY BELLS'

(DEER GRASS)

(SAGELEAF ROCKROSE) SOURCE: H. ZELL

SOURCE: GARDENIA.NET

DUITNAJ9 AZAJ9

TUS SALVIIFOLUIUS

ESCALLONIA SPP.



GREVILLEA SPP. (GREVILLEA)



LAURUS 'SARATOGA' (SARATOGA BAY LAUREL)







LAGERSTROEMIA INDICA

'TUSCARORA' (CRAPE MYRTLE)

LAGERSTROEMIA INDICA 'NATCHEZ' (CRAPE MYRTLE)

CALAMAGROSTIS FOLIOSA (LEAFY REEDGRASS)

LOMANDRA LONGIFOLIA (DWARF MAT RUSH)

IDRON SPP.

(LEUCADENDRON) LEUCADEN

LEONOTIS LEONURUS (LION'S TAIL)

WHITE LIGHTNIN' (WHITE LANTANA) SOURCE: MONROVIA.COM

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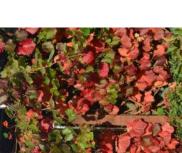
**ANTANA MONTEVIDENSIS** 

PLAZA PLANTING (CONTINUED)

PLAZA TREES



GRAPE) 15 GAL



VINES FOR GREENWALL





EXISTING TREE TO REMAIN

NOLL ©TAM



729 Heinz Avenue Berkeley, CA 94710 tel 510.542.2200 fax 510.542.2201

**ARCHITECTS** 

DIPLACUS AURANTIACUS (STICKY MONKEY FLOWER) 1 GAL RIBES SANGUINEUM (RED FLOWERING CURRANT) 5 GAL SALVIA CLEVELANDII 'ALAN CHICKERING' (SAGE) 1 GAL RIBES VIBURNIFOLIUM (EVERGREEN CURRANT) 1 GAL FESTUCA CALIFORNICA (CALIFORNIA FESCUE) 1 GAL RUDBECKIA FULGIDA (BLACK-EYED SUSAN) 1 GAL




NOLL'S TANGEN OS ILLEGATION OS CALAMAGROSTIS FOLIOSA (LEAFY REEDGRASS) 1 GAL CISTUS SALVIIFOLUIUS (SAGELEAF ROCKROSE) 1 GAL CORREA IVORY BELLS' (AUSTRALIAN FUCHSIA) 1 GAL ANIGOZANTHOS FLAVIDUS (KANGAROO PAW) 1 GAL DIETES HYBRIDA 'LEMON DROPS' (LEMON DROPS FORTNIGHT LILY) 1 GAL

ESCALLONIA SPP. (ESCALLONIA) 1 GAL GREVILLEA SPP. (GREVILLEA) 1 GAL LANTANA MONTEVIDENSIS 'WHITE LIGHTNIN' (WHITE

**APPROVALS** 

LOMANDRA LONGIFOLIA (DWARF MAT RUSH) 1 GAL LEUCADENDRON SPP. (LEUCADENDRON) 5 GAL MUHLENBERGIA RIGENS (DEER GRASS) 1 GAL LEONOTIS LEONURUS (LION'S TAIL) 5 GAL LANTANA) 1 GAL

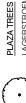

LAURUS NOBILIS 'SARATOGA" (LAURUS SARATOGA) 36" BOX LAGERSTROEMIA INDICA ' NATCHEZ' OR TUSCARORA' (CRAPE MYRTLE) 36"-BOX

Santa Cruz Public

PROJECT TITLE

**Live Oak Library** 



STORMWATER PLANTING AREAS

CALAMAGROSTIS NUTKAENSIS (PACIFIC REEDGRASS) 1 GAL CAREX TUMULICOLA (FOOTHILL SEDGE) 1 GAL CAREX PANSA (PACIFIC DUNE SEDGE) 1 GAL ELYMUS GLAUCUS (BLUE WILDRYE) 1 GAL

979 17th Avenue, Santa Cruz, CA 95062

PENSTEMON HETEROPHYLLUS (FOOTHILL PENSTEMON) 1

100% DESIGN DEVELOPMENT

WITIS CALIFORNICA 'ROGER'S RED" (ROGER'S CALIFORNICA VINES FOR GREENWALL

DESCRIPTION

JOB NUMBER

ISSUE DATE





DRAWN BY OW CHECKED BY GL SHEET TITLE

PLANTING LIST AND IMAGES

VITIS CALIFORNICA 'ROGER'S RED' (ROGER'S CALIFORNIA GRAPE)

PENSTEMON HETEROPHYLLUS (FOOTHILL PENSTEMON) SOURCE: CALPHOTOS.BERKELEY.EDU

(BLUE WILDRYE) SOURCE: DALLASPLANTTRIALS.ORG

ELYMUS GLAUCUS


UMULICOLA LL SEDGE)

CAREX PANSA (PACIFIC DUNE SEDGE)

CALAMAGROSTIS NUTKAENSIS (PACIFIC REEDGRASS)

MA 04:49:40 AM

STORMWATER PLANTING AREAS

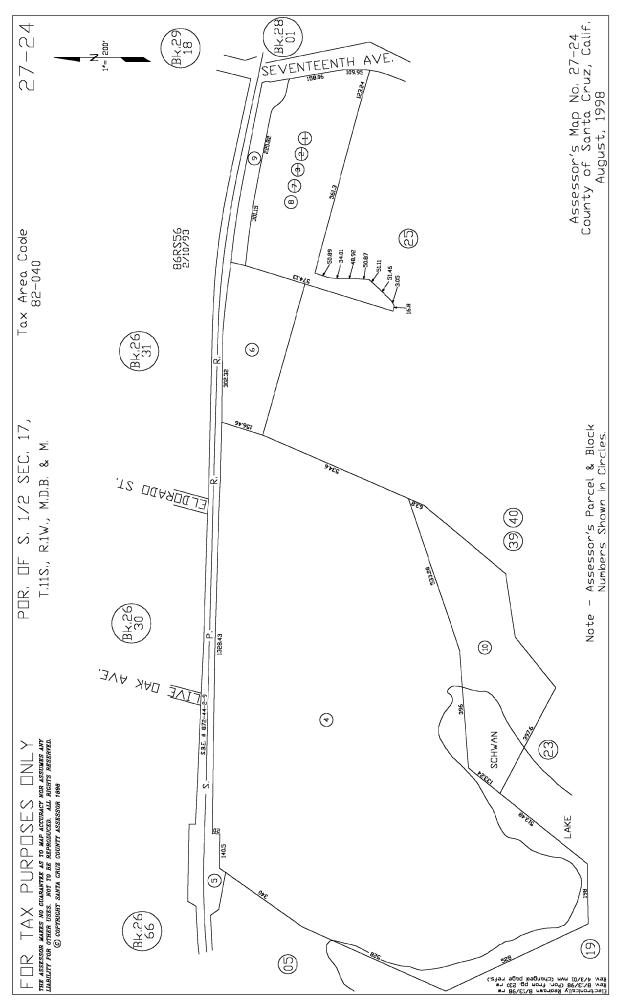



# SANTA CRUZ COUNTY PLANNING DEPARTMENT

# **Parcel Location Map**






Parcel: 02724106

Study Parcel

Assessor Parcel Boundary

Existing Park

Map printed: 26 May. 2021

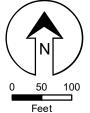



# SANTA CRUZ COUNTY PLANNING DEPARTMENT

# **Parcel General Plan Map**





R-UL Res. Urban Low Density

Public Facilities

O-R Parks, Recreation & Open Space



PF Public/Community Facilities

R-1 Single-Family Residential

PR Parks, Recreation, & Open Space

# SANTA CRUZ COUNTY PLANNING DEPARTMENT

# **Parcel Zoning Map**





Application #: 201354

APN: 027-241-06 & 027-251-12 Owner: County of Santa Cruz

## **Parcel Information**

## **Services Information**

Urban/Rural Services Line: X Inside Outside

Water Supply: City of Santa Cruz

Sewage Disposal: Santa Cruz County Sanitation District

Fire District: Central Fire Protection District
Drainage District: Zone 5 Flood Control District

## **Parcel Information**

Parcel Size: 4.5 acres (APNs 027-241-06 & 027-251-12) Existing Land Use - Parcel: Swim center and administrative offices

Existing Land Use - Surrounding: Shoreline Middle School, Schwan Lake, railroad tracks.

Project Access: Shared driveway from 17th Avenue

Planning Area: Live Oak

Land Use Designation: O-R (Parks, Recreation and Open Space)
Zone District: PR (Parks, Recreation and Open Space)

Coastal Zone: X Inside Outside
Appealable to Calif. Coastal X Yes No

Comm.

**Technical Reviews**: Soils Report Review (REV201127)

### **Environmental Information**

Geologic Hazards: Not mapped/no physical evidence on site

Fire Hazard: Not a mapped constraint

Slopes: 2-3%

Env. Sen. Habitat: Unnamed stream/drainage at rear of property, Schwan Lake (located

to the southwest)

Grading: 570 cubic yards (cut), 420 cubic yards (fill)

Tree Removal: 11 trees proposed to be removed

Scenic: Not a mapped resource

Archeology: Not mapped/no physical evidence on site

# COUNTY OF SANTA CRUZ DEPARTMENT OF PUBLIC WORKS

INTER-OFFICE CORRESPONDENCE

DATE: October 22, 2020

TO: Santa Cruz County Planning Department

FROM: Damon Adlao, Project Manager, Capital Project Division

SUBJECT: Live Oak Library Annex Project, Community Meeting Process Narrative

# Introduction:

The Department of Public Works (DPW) is currently managing a project to build an addition at the Simpkins Swim Center that will house the new Live Oak Library Annex. DPW is currently working with Noll & Tam Architects to design and develop construction documents for use in the entitlement process and bidding. The following is a narrative to describe the public engagement, community meeting process, and outreach that was utilized to inform scope and programming for the project.

# Background:

Following a series of initial meetings with stakeholders including Santa Cruz Public Libraries, Live Oak School District, Boys and Girls Club, and County Parks, a concept and location for a Live Oak Library Annex Project was approved by the Board of Supervisors on October 24, 2017. The concept for the Live Oak Library Annex project is to create a new learning center-library annex at the Simpkins Swim and Community Center. The Live Oak Library Annex will provide free learning facilities for all ages not otherwise available at the Live Oak Branch Library. The location presents the opportunity to enhance the community's access to library programming and services at a central location adjacent to other community facilities including the Live Oak Clubhouse of the Boys and Girls Club, Shoreline Middle School, the future rail-trail and Schwan Lake State Park.

Beginning in November 2016, Supervisor Leopold convened a working group including representatives from the Santa Cruz Public Libraries, Live Oak School District, Santa Cruz Boys and Girls Club, County Parks, the County Administrative Office, and DPW. The group discussed the need for new learning facilities and to create opportunities to partner together to provide a wide variety of learning programs, with an interest in identifying a central Live Oak location for a library annex.

During the feasibility and concept phase, Noll & Tam Architects led four total Community Meeting to solicit input from the community on facility programming, design concepts, and project scope. The following represents each Community Meeting's date and the information that was shared at each meeting.

- Community Meeting 1: September 27, 2018; Visioning and Needs Workshop; Meeting focus on Community ideas, Current and Proposed Library and Parks programs, Existing Building and Site assessment, and Project goals/21<sup>st</sup> Century Library
- 2. <u>Community Meeting 2:</u> October 22, 2018; Presentation of project concepts and benefits and constraints review; Concept options and Community survey
- 3. <u>Community Meeting 3:</u> December 4, 2018; Presentation of preferred concept plan, project overview, and schedule; Preferred Option and Planning the Project
- 4. Community Meeting 4: May 28, 2019; Presentation of final concept plan

# **Community Meeting Outreach:**

For each of the four community meetings mentioned above, an extensive outreach was conducted in order to create interest for the project and make the public aware of the opportunity to contribute in the meetings. Prior to Community Meeting 1, 12,800 postcards were sent out to the greater Live Oak community to addresses located to the east of 7<sup>th</sup> Avenue, west of 41<sup>st</sup> Avenue, south of Highway 1, and north of the Monterey Bay. In addition, each meeting was advertised on both the Santa Cruz Public Library and DPW websites and Facebook pages, distributed to local news publications including the Santa Cruz Sentinel and Aptos Times, and shared via email on numerous lists reaching several hundred Live Oak community members. Physical flyers were posted prior to each Community Meeting in businesses on the 17<sup>th</sup> Avenue business corridor, at local elementary schools including Live Oak Elementary, Green Acres, and Del Mar, and at Shoreline Middle School.



# TECHNICAL MEMORANDUM

FROM: Ben Huie, P.E., Kimley-Horn and Associates
Jacob Mirabella, Kimley-Horn and Associates

TO: Damon Adlao, Project Manager, Capitol Projects, County of Santa Cruz

DATE: August 21, 2020

RE: Live Oak Library Annex in Santa Cruz, CA – Traffic Study

# **Executive Summary**

This memorandum presents a transportation evaluation for the Live Oak Library Annex project (the "Project"), which proposes to construct a new 1,850-square foot library annex to the existing Simpkins Family Swim Center at 2380 Portola Drive in the County of Santa Cruz, California. In addition to the new library annex, modifications to the swim center including, renovation of the existing learning center, refresh of the community room, site and plaza improvements, and second floor modifications are proposed. The Project site is shown in Figure 1.

The objective of this memorandum is to evaluate the Project's potential net new trip generation and parking demand that could be impacted by the proposed project in terms of the California Environmental Quality Act (CEQA) and Santa Cruz County guidelines.

This memorandum is organized as follows:

- 1. Introduction
- 2. Trip Generation
- 3. Parking Demand
- 4. Vehicle Miles Traveled (VMT) Analysis
- 5. Appendix

Our findings are summarized as follows:

Trip Generation – based on the project description for the swim center and the library annex and past attendance data for the swim center, the following trip generation for the existing and proposed project is assumed:

- The existing Swim Center is expected to generate the following weekday trips:
  - Typical Non-Summer Day 696 daily trips, 17 AM peak hour trips (17 in/0 out), 141 PM peak hour trips (97 in/44 out)
  - Typical Summer Day 917 daily trips, 61 AM peak hour trips (51 in/10 out), 89 PM peak hour trips (61 in/28 out)
- The existing Swim Center with the proposed library annex is expected to generate the following weekday trips:
  - Typical Non-Summer Day 788 daily trips, 17 AM peak hour trips (17 in/0 out), 170 PM peak hour trips (114 in/56 out)



 Typical Summer Day – 1,009 daily trips, 61 AM peak hour trips (51 in/10 out), 118 PM peak hour trips (78 in/40 out)

Parking Demand – based on the project description for the swim center and the library annex and past attendance data for the swim center, the following provides the peak parking demand for the existing and proposed project:

- The existing Swim Center is expected to have the following peak parking demand:
  - Typical Non-Summer Day peak parking demand of 140 parking spaces occupied out of 183 available parking spaces (77 percent) occurs at 6:00 PM
  - Typical Summer Day peak parking demand of 93 parking spaces occupied out of 183 available parking spaces (51 percent) occurs at 12:00 PM and 1:00 PM
- The existing Swim Center with the proposed library annex is expected to have the following peak parking demand:
  - Typical Non-Summer Day peak parking demand of 157 parking spaces out of 183 available parking spaces (86 percent) occurs at 6:00 PM
  - Typical Summer Day peak parking demand of 110 parking spaces out of 183 available parking spaces (60 percent) occurs at 12:00 PM

Parking Requirement (Municipal Code) - Based on the County's municipal code requirements, one vehicle parking space for every 200 square feet of gross floor area and 30 parking spaces for every 1,000 square feet of public assembly area is required for the swim center. Since the size of the existing swim center is 21,004 square feet with 2,600 square feet of community room, the swim center is required to provide 183 parking spaces. The proposed 1,850-square foot library annex is required to provide 30 parking spaces per 1,000 square feet, which equates to 56 required parking spaces. Therefore, the parking lot which serves the existing swim center and proposed library annex is required to provide 239 spaces, seven (7) of which are ADA compliant. Section 13.10.553 (B)(5) of the Municipal Code states that parking requirements for a site with two uses may be reduced to the parking requirement for the land use that requires the greater number of spaces if there is valid data supporting that there is sufficient parking provided. Since the peak parking demand is below the available parking supply based on the parking analysis, the parking requirement may be reduced to the required 183 parking spaces for the swim center.

VMT Analysis – Since the proposed library annex is expected to generate 92 daily trips and is less than the 110-daily trip threshold based on the Governor's Office of Planning and Research (OPR) Technical Advisory, the project will not create a VMT impact.



Figure 1: Project Location Map



Source: Google Maps



# 1. Introduction

The Live Oak Library, located at 2380 Portola Drive in Santa Cruz County, is proposing to construct a library annex at the Simpkins Family Swim Center at 979 17<sup>th</sup> Avenue, which is located approximately one-mile northeast of the existing library. The Live Oak Library Annex Project ("Project") will construct approximately 1,850 square feet of building at the swim center. Along with the proposed new building, modifications to the swim center including, renovation of the existing learning center, refresh of the community room, site and plaza improvements, and second floor modifications are proposed. A traffic evaluation was performed to evaluate the change in trip generation and parking demand to the swim center as a result of the proposed project. This memorandum discusses the methodology, analysis, and results of the study.

# 2. Trip Generation

Trip generation for the existing swim center and the proposed library annex were determined based on information provided by the County and other available sources. Typically, vehicle driveway counts could be collected on a typical weekday to determine existing conditions, however due to the Shelter-in-Place directives due to COVID-19 beginning in March 2020, the project site and the adjacent street traffic are experiencing atypical conditions. Therefore, the existing trip generation can only be estimated at this time.

# **Existing Trip Generation**

The existing weekday trip generation for the Simpkins Swim Center were determined for the three main uses of the swim center: the community room, private events, and recreational use. On weekdays, the swim center is open from Mondays to Fridays between 6:00 AM to 7:30 PM. Attendance information for the community room and private events was provided for 2019 (before the Shelter-in-Place directives) and included the number of meetings or events held each day, its start and end time, and the number of attendees for each meeting or event. Since a swim center may have different trips generated during the summer compared to other seasons of the year, weekday trip generation for a typical summer day and a typical non-summer day were evaluated. Review of the year round attendance information showed that June 26, 2019 was a typical summer day and February 19, 2019 was a typical non-summer day. Attendance from these two days were used for each use during the AM peak period (7:00 AM to 9:00 AM) and the PM peak period (4:00 PM to 6:00 PM) to determine the total AM and PM peak hour trips. A vehicle occupancy of 1.5 persons per vehicle were assumed for the AM and PM peak periods based on the County's knowledge of the swim center. Historical attendance data for the lap and recreational use of the Brooks Street Swim Center in the City of Oceanside, California, was used to estimate the AM and PM peak hour trips for the recreational use of the Simpkins Swim Center. Table 1 and Table 2 present the trip generation estimates for the existing swim center for a typical non-summer day and summer day, respectively. As illustrated in Table 1, the existing swim center would generate a total of 696 daily trips, 17 trips in the AM peak hour (17 in/0 out), and 141 trips in the PM peak hour (97 in/44 out) during a typical non-summer day. As illustrated in Table 2, the existing swim center would generate a total of 917 daily trips, 61 trips in the AM peak hour (51 in/10 out), and 89 trips in the PM peak hour (61 in/28 out) during a typical summer day.



Table 1 – Existing Swim Center Trip Generation – Typical Non-Summer Weekday

Land Hea		AM Peak			PM Peak		
Land Use	Daily	Total	In	Out	Total	In	Out
Existing Conditions							
Swim Center – Community Room <sup>1</sup>	53	0	0	0	13	13	0
Swim Center – Private Events <sup>1</sup>	267	0	0	0	94	67	27
Swim Center – Recreational Use <sup>2</sup>	376	17	17	0	34	17	17
Total Existing Swim Center Trips	696	17	17	0	141	97	44

<sup>&</sup>lt;sup>1</sup> Trip generation based on attendance for February 19, 2019.

Table 2 – Existing Swim Center Trip Generation – Typical Summer Weekday

Land Uso		AM Peak			PM Peak		
Land Use	Daily	Total	ln	Out	Total	In	Out
Existing Conditions							
Swim Center – Community Room <sup>1</sup>	100	0	0	0	23	23	0
Swim Center – Private Events <sup>1</sup>	153	43	33	10	10	10	0
Swim Center – Recreational Use <sup>2</sup>	664	18	18	0	56	28	28
Total Existing Swim Center Trips	917	61	51	10	89	61	28

<sup>&</sup>lt;sup>1</sup> Trip generation based on attendance for June 26, 2019.

As shown in Table 1 and Table 2, the swim center generates more PM peak hour trips for a typical nonsummer day than a summer day. This is because there are more activities held indoors during the winter while there are fewer attendees during summer due to summer camps and vacations.

Based on the project description, the swim center can hold up to 20 to 700 people at a time. Assuming an average vehicle occupancy of 1.5 persons per vehicle for the entire swim center, the maximum existing trips generated by the swim center is 467 trips entering before the start of an event and 467 trips exiting after the end of an event.

# **Proposed Trip Generation**

A proposed trip generation for the library annex during a typical weekday was developed based on the anticipated weekly programs that will be held. It was assumed that the proposed trip generation for the library annex will be the same for a typical non-summer and summer day. The following provides the programs that are expected to occur and the estimated one-way vehicle trips it will generate.

- Morning toddler time once a week: 50 people (approximately 20 vehicles)
- Adult morning programs two times a week: 20 people (approximately 15 vehicles)
- After school programs three times a week: 20 people (approximately 10 vehicles)
- Evening programs two times a week: 20 people (approximately 15 vehicles)

The library annex is not expected to open until 10:00 AM during the weekdays, therefore morning programs would not occur during the AM peak period between 7:00 AM to 9:00 AM. Trips generated by

<sup>&</sup>lt;sup>2</sup> Trip generation based on historical data for another swim center site.

<sup>&</sup>lt;sup>2</sup> Trip generation based on historical data for another swim center site.



the morning toddler time were not taken into consideration for the daily trips since this program only occurs once a week. The number of staff for each event was not provided, therefore it is assumed that there will be at least two (2) staff present during each program. Table 3 and Table 4 present the trip generation estimates for the existing swim center and proposed library annex for a typical non-summer and summer day, respectively. As illustrated in Table 3, the proposed swim center would generate a total of 788 daily trips, 17 trips in the AM peak hour (17 in/0 out), and 170 trips in the PM peak hour (114 in/56 out) during a non-summer day. As illustrated in Table 4, the proposed swim center would generate a total of 1,009 daily trips, 61 trips in the AM peak hour (51 in/10 out), and 118 trips in the PM peak hour (78 in/40 out) during a summer day.

Table 3 – Proposed Swim Center Trip Generation – Typical Non-Summer Weekday

Land Usa		AM Peak			PM Peak				
Land Use	Daily	Total	In	Out	Total	In	Out		
Existing Conditions									
Swim Center – Community Room <sup>1</sup>	53	0	0	0	13	13	0		
Swim Center – Private Events <sup>1</sup>	267	0	0	0	94	67	27		
Swim Center – Recreational Use <sup>2</sup>	376	17	17	0	34	17	17		
Total Existing Swim Center Trips	696	17	17	0	141	97	44		
Proposed Conditions									
Library Annex	92	0	0	0	29	17	12		
Net Vehicle Trips	788	17	17	0	170	114	56		

<sup>&</sup>lt;sup>1</sup> Trip generation based on attendance for February 19, 2019.

Table 4 – Proposed Swim Center Trip Generation – Typical Summer Weekday

Land Usa			AM Peak		F	PM Peak	
Land Use	Daily	Total	In	Out	Total	In	Out
Existing Conditions							
Swim Center – Community Room <sup>1</sup>	100	0	0	0	23	23	0
Swim Center – Private Events <sup>1</sup>	153	43	33	10	10	10	0
Swim Center – Recreational Use <sup>2</sup>	664	18	18	0	56	28	28
Total Existing Swim Center Trips	917	61	51	10	89	61	28
Proposed Conditions							
Library Annex	92	0	0	0	29	17	12
Net Vehicle Trips	1,009	61	51	10	118	78	40

<sup>&</sup>lt;sup>1</sup> Trip generation based on attendance for June 26, 2019.

Since events for the proposed plaza space are held approximately four (4) times a year and do not occur for a typical weekday, it was not included in the trip generation.

Maximum attendance for the proposed library annex occurs approximately eight (8) times a year which includes performances occurring four (4) times a year and summer performance programs occurring also four (4) times a year. Each performance is anticipated to have approximately 100 people in attendance

<sup>&</sup>lt;sup>2</sup> Trip generation based on historical data for another swim center site.

<sup>&</sup>lt;sup>2</sup> Trip generation based on historical data for another swim center site.



and will generate about 50 vehicles trips entering before an event and about 50 vehicle trips exiting after an event. The plaza space is also anticipated to be used about four (4) times a year with 100 to 200 attendees. Assuming a vehicle occupancy rate of 2 persons per vehicle, the events for the plaza space would generate between 50 to 100 vehicle trips entering before an event and 50 to 100 vehicles trips exiting after an event. Major events planned for the swim center, library annex, and plaza space should be coordinated between staff to avoid occurring simultaneously.

# 3. Parking Demand

Parking demand for the existing swim center and the proposed library annex were determined based on information provided by the County and other available sources. Parking demand was determined for a typical non-summer and summer day between 6:00 AM to 9:00 PM.

# **Existing Parking Supply**

Based on the *Live Oak Library Annex Study and Concept Plan*, dated September 10, 2019, the swim center parking lot provides 182 regular spaces and eight (8) accessible spaces. However, seven (7) regular spaces on the southwest corner of the parking lot are occupied by dumpsters or used as mulch storage and reduces the available regular spaces to 175 parking spaces. Therefore, there is a total supply of 183 parking spaces.

# **Existing Parking Demand**

Similar to the trip generation, the existing parking demand for the swim center was determined for the three main uses: community room, private events, and recreational use. Daily attendance for the community room and private events for February 19, 2019 and June 26, 2019 were used to estimate hourly parking demands for a typical non-summer day and typical summer day, respectively. A vehicle occupancy of 1.5 persons per vehicle was assumed for the AM and PM peak periods based on the County's knowledge of the swim center. Existing parking demand for the recreational use was determined based on historical data for the lap and recreational use of the Brooks Street Swim Center and previous 2019 schedule for the lap pool and warm water pool hours for the existing swim center.

Table 5 and Table 6 shows the existing parking demand for the swim center for a typical non-summer day and summer day, respectively.

Table 5 shows the peak parking demand for a typical non-summer weekday occurs at 6:00 PM with 140 parking spaces occupied (77 percent) and 43 parking spaces remaining. Table 6 shows the peak parking demand for a typical summer weekday occurs at 12:00 PM and 1:00 PM with 93 parking spaces occupied (51 percent) and 90 parking spaces remaining. As mentioned previously in the trip generation section, the swim center has a higher attendance during winter due to more indoor activities compared to during summer due to summer camps and summer vacations, which explains why there is a higher peak parking demand in February compared to June. It should be noted that the Schwan Lake State Park located to the west of the swim center shares the parking lot with the swim center. However, it is not expected to generate a parking demand during weekdays and therefore was excluded from the existing parking demand.



Table 5 – Existing Swim Center Parking Demand – Typical Non-Summer Weekday

			Existing Der	mand		
Time	Community Room <sup>1</sup>	Private Event <sup>1</sup>	Recreational <sup>2</sup>	Total Occupied	Percent Occupied	Total Unoccupied
			Available Spac	es = 183		
6:00 AM	0	0	17	17	9%	166
7:00 AM	0	0	17	17	9%	166
8:00 AM	0	0	17	17	9%	166
9:00 AM	0	0	17	17	9%	166
10:00 AM	0	0	7	7	4%	176
11:00 AM	0	0	7	7	4%	176
12:00 AM	0	0	7	7	4%	176
1:00 PM	0	0	7	7	4%	176
2:00 PM	0	10	12	22	12%	161
3:00 PM	0	27	17	44	24%	139
4:00 PM	13	63	17	93	51%	90
5:00 PM	26	93	17	136	74%	47
6:00 PM	26	97	17	140	77%	43
7:00 PM	26	47	12	85	46%	98
8:00 PM	26	0	0	26	14%	157
9:00 PM	0	0	0	0	0%	183

Notes: Peak parking demand is shown in  $\ensuremath{\text{red}}$  and bolded.

Table 6 – Existing Swim Center Parking Demand – Typical Summer Weekday

			Existing Demand					
Time	Community Room <sup>1</sup>	Private Event <sup>1</sup>	Recreational <sup>2,3</sup>	Total Occupied	Percent Occupied	Total Unoccupied		
			Available Space	es = 183				
6:00 AM	0	0	18	18	10%	165		
7:00 AM	0	33	18	51	28%	132		
8:00 AM	0	33	18	51	28%	132		
9:00 AM	27	33	18	78	43%	105		
10:00 AM	27	0	8	35	19%	148		
11:00 AM	27	0	8	35	19%	148		
12:00 AM	27	33	33	93	51%	90		
1:00 PM	27	33	33	93	51%	90		
2:00 PM	0	33	33	66	36%	117		
3:00 PM	0	33	33	66	36%	117		
4:00 PM	23	10	28	61	33%	122		
5:00 PM	23	10	28	61	33%	122		
6:00 PM	23	10	28	61	33%	122		
7:00 PM	23	0	28	51	28%	132		
8:00 PM	23	0	0	23	13%	160		
9:00 PM	23	0	0	23	13%	160		

Notes: Peak parking demand is shown in red and bolded.

<sup>&</sup>lt;sup>1</sup> Parking generation based on attendance for February 19, 2019.

<sup>&</sup>lt;sup>2</sup> Parking generation based on historical data for another swim center site and the previous 2019 schedule for the Simpkins Swim Center.

 $<sup>^{\</sup>rm 1}\,\textsc{Parking}$  generation based on attendance for June 26, 2019.

 $<sup>^{2}</sup>$  Parking generation based on historical data for another swim center site and the previous 2019 schedule for the Simpkins Swim Center.



# **Proposed Parking Demand**

A proposed parking demand for the library annex was determined based on the weekly programs that are expected to take place and the time of day each would occur. The following assumptions were made to determine the hourly parking demand:

- Morning toddler time once a week: 50 people (approximately 20 vehicles)
  - Since this program occurs once a week, this will be excluded from the parking demand for a typical weekday
- Adult morning programs two times a week: 20 people (approximately 15 vehicles)
  - Assume this program begins at 10:00 AM and ends at 12:00 PM
- After school programs three times a week: 20 people (approximately 10 vehicles)
  - o Assume this program begins at 3:00 PM and ends at 4:00 PM
- Evening programs two times a week: 20 people (approximately 15 vehicles)
  - o Assume this program begins at 6:00 PM and ends at 8:00 PM
- Each program is assumed to be have at least two (2) staff present throughout the entire period

Table 7 and Table 8 presents the total proposed parking demand for the swim center with the addition of the library annex for a typical non-summer day and summer day, respectively.

Table 7 – Proposed Swim Center Parking Demand – Typical Non-Summer Weekday

Time	Ex	xisting Den	nand	Proposed Demand	Total	Percent	Total
Available	Community Room <sup>1</sup>	Private Event <sup>1</sup>	Recreational <sup>2,3</sup>	Library Annex	Occupied	Occupied	Unoccupied
Spaces				183			
6:00 AM	0	0	17	0	17	9%	166
7:00 AM	0	0	17	0	17	9%	166
8:00 AM	0	0	17	0	17	9%	166
9:00 AM	0	0	17	17	34	19%	149
10:00 AM	0	0	7	17	24	13%	159
11:00 AM	0	0	7	17	24	13%	159
12:00 AM	0	0	7	17	24	13%	159
1:00 PM	0	0	7	0	7	4%	176
2:00 PM	0	10	12	12	34	19%	149
3:00 PM	0	27	17	12	56	31%	127
4:00 PM	13	63	17	12	105	57%	78
5:00 PM	26	93	17	17	153	84%	30
6:00 PM	26	97	17	17	157	86%	26
7:00 PM	26	47	12	17	102	56%	81
8:00 PM	26	0	0	17	43	23%	140
9:00 PM	0	0	0	0	0	0%	183

Notes: Peak parking demand is shown in red and bolded.

<sup>&</sup>lt;sup>1</sup> Parking generation based on attendance for February 19, 2019.

<sup>&</sup>lt;sup>2</sup> Parking generation based on historical data for another swim center site and the previous 2019 schedule for the Simpkins Swim Center.



Table 8 – Proposed Swim Center Parking Demand – Typical Summer Weekday

Time	E	xisting Den	nand	Proposed Demand	Total	Percent	Total
Available	Community Room <sup>1</sup>	Private Event <sup>1</sup>	Recreational <sup>2,3</sup>	Library Annex	Occupied	Occupied	Unoccupied
Spaces				183			
6:00 AM	0	0	18	0	18	10%	165
7:00 AM	0	33	18	0	51	28%	132
8:00 AM	0	33	18	0	51	28%	132
9:00 AM	27	33	18	17	95	52%	88
10:00 AM	27	0	8	17	52	28%	131
11:00 AM	27	0	8	17	52	28%	131
12:00 AM	27	33	33	17	110	60%	73
1:00 PM	27	33	33	0	93	51%	90
2:00 PM	0	33	33	12	78	43%	105
3:00 PM	0	33	33	12	78	43%	105
4:00 PM	23	10	28	12	73	40%	110
5:00 PM	23	10	28	17	78	43%	105
6:00 PM	23	10	28	17	78	43%	105
7:00 PM	23	0	28	17	68	37%	115
8:00 PM	23	0	0	17	40	22%	143
9:00 PM	23	0	0	0	23	13%	160

Notes: Peak parking demand is shown in red and bolded.

As shown in Table 7, the peak parking demand with the proposed library annex continues to occur at 6:00 PM with an increased demand to 157 parking spaces (86 percent) for a typical non-summer day. As shown in Table 8, the peak parking demand with the proposed library annex occurs at 12:00 PM with an increased demand to 110 parking spaces (60 percent) for a typical summer day. Therefore, the available 183 parking spaces is sufficient to meet the proposed parking demands.

Similar to the trip generation analysis section, major events planned for the swim center, library annex, and plaza space should be coordinated between staff to avoid events occurring simultaneously and resulting in the parking demand exceeding the available parking spaces.

# Parking Requirement

The County of Santa Cruz's Parking Requirements were reviewed to determine whether the existing parking supply met the parking requirements for the proposed uses based on the County of Santa Cruz Municipal Code<sup>1</sup> (13.10.551 to 13.10.553). Based on Section 13.10.551 (B), if more than one use is provided on a site, the required number of parking should be the total number of required parking spaces for each site. Table 9 provides the parking requirements for the existing swim center and proposed library annex.

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<sup>&</sup>lt;sup>1</sup> Parking generation based on attendance for June 26, 2019.

<sup>&</sup>lt;sup>2</sup> Parking generation based on historical data for another swim center site and the previous 2019 schedule for the Simpkins Swim Center.

<sup>&</sup>lt;sup>1</sup> Santa Cruz County Code, Schedule of Off-Street Parking Space Requirements, April 2020



Table 9 – Santa Cruz County Parking Requirements

Land Use	Santa Cruz County Land Use	Parking Requirements (vehicle spaces/unit)	# of Units (square ft)	Parking Spaces Required	Parking Spaces Supplied	Requirement Met?
Swim Center	Public Buildings and Grounds	1 per 200 SF plus 30 per 1,000 SF of public assembly area	21,004 SF Total (2,600 SF of Community Room)	105 spaces + 78 spaces	183 spaces	No
Library Annex	Places of public assembly	30 per 1,000 SF	1,850 SF	56 spaces		
Total				239 spaces	183 spaces	No

<sup>\*</sup> Gross Floor area also excludes space used solely for storage or truck loading.

The County of Santa Cruz also provides minimum requirements for ADA spaces. Table 10 below shows the maximum number of ADA spaces required which is based on the total required parking spaces. Since the proposed swim center with the addition of the library annex is required to provide a total of 239 spaces, seven (7) of the spaces must be ADA compliant.

Table 10 – Santa Cruz County ADA Parking Requirements

Total Parking Spaces Required	Maximum number of ADA Spaces Required <sup>1</sup>
1 – 252	1
26 - 50	2
51 - 75	3
76 - 100	4
101 – 150	5
151 – 200	6
201 – 300	7
301 – 400	8
401 – 500	9
201 – 1,000	_3
1,001 and over	_4

Van space(s). One in every eight accessible spaces, but not less than one, shall be served by an access aisle 96 inches wide, minimum, and shall be designated van accessible. All such spaces shall be grouped on one level of any parking structure.

Based on the County's parking requirements, since the swim center parking lot currently provides 183 parking spaces, eight (8) of which are accessible spaces, the parking supply does not meet the minimum required 239 parking spaces. However, based on the parking analysis in Chapter 3, the peak parking

<sup>&</sup>lt;sup>2</sup>Less than five spaces. When less than five spaces are provided at buildings and facilities subject to these regulations, one shall be 14 feet wide and lined to provide a nine-foot parking area and a five-foot loading and unloading area. However, there is no requirement that the space be reserved exclusively or identified for use by persons with disabilities only.

<sup>&</sup>lt;sup>3</sup>Two percent of the total.

 $<sup>^4</sup>$ Twenty plus one for each 100, or fraction thereof over 1,001

<sup>\*</sup> Gross Floor area also excludes space used solely for storage or truck loading



demand is expected to be below the available parking supply. Section 13.10.553 (B)(5) of the Municipal Code states that parking requirements for a site with two uses may be reduced to the parking requirement for the land use that requires the greater number of spaces if there is valid data supporting that there is sufficient parking provided. Since the peak parking demand is below the available parking supply based on the parking analysis in Chapter 3, the parking requirement may be reduced to the required 183 parking spaces for the swim center. Since the existing swim center and proposed library annex is operated by the County of Santa Cruz, there is no need to provide a parking agreement between the two uses.

# 4. VMT Analysis

Recent changes to the California Environmental Quality Act (CEQA) no longer recognizes vehicle intersection level of service (LOS) as a transportation impact, but rather vehicle miles traveled (VMT) as described in Senate Bill (SB) 743. Since the County has not adopted a VMT methodology or significance criteria, guidelines from the Technical Advisory<sup>2</sup>, dated April 2018, will be used to determine potential VMT impacts of the proposed project.

Guidance in the technical advisory provides a screening threshold for smaller projects and states that if the project generates less than 110 trips per day, it is assumed to create a less-than-significant transportation impact. Based on the trip generation analysis for the proposed project in Chapter 2, the library annex is expected to generate 92 daily trips and is below the screening threshold for smaller projects. Therefore, the proposed project is not expected to create a VMT impact.

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<sup>&</sup>lt;sup>2</sup> Technical Advisory on Evaluating Transportation Impacts in CEQA, Governor's Office of Planning and Research, April 2018.



# **APPENDIX**

Community Room								
Permit Number	Attendance	<b>Event Start Time</b>	<b>Event End Time</b>					
Feb 19, 2019								
181	20	18:00	20:00					
792	20	16:30	20:00					
Jun 26, 2019								
1209	35	17:00	21:00					
1271	40	09:45	13:00					

Private Events							
Permit Number	Attendance	Event Start Time	Event End Time				
Feb 19, 2019							
731	45	18:30	19:30				
731	45	18:00	18:30				
497	25	17:00	19:45				
497	25	15:45	17:00				
498	15	17:00	18:00				
498	15	15:00	16:15				
498	15	18:00	18:30				
498	15	16:15	17:00				
Jun 26, 2019							
2001	50	13:00	15:30				
1264	20	07:30	09:00				
1206	15	07:30	09:00				
1205	15	07:30	09:00				
1205	15	17:00	18:00				