WATSONVILLE SLOUGH FARM COMMUNITY HARVEST PROJECT

LAND TRUST OF SANTA CRUZ COUNTY

275 LEE ROAD WATSONVILLE, CA 95076 APN: 052-081-34, 052-081-35, 052-081-37

CONTACT: BRYAN LARGAY

EMAIL: BRYAN.LARGAY@LANDTRUSTSANTACRUZ.ORG

REFERENCE SYMBOLS

\triangle	SITE SECTION			PROPOSED CONTOUR LINE
101		 SHEET MATCH/ LIMIT OF WORK		
<u> </u>		 	(104)	EXISTING CONTOUR LINE
₩.	DATUM REFERENCE	 PROPERTY AND BOUNDARY LINES		LIMIT OF ADDITIVE ALTERNATE WORK
Λ	REVISION REFERENCE	 CENTER LINES		
_				HIDDEN LINE
1	NORTH ARROW		——JL	BREAKLINE

GENERAL ABBREVIATIONS

&	AND	CMU	CONCRETE MASONRY UNIT	FG	FINISH GRADE ELEVATION	NIC	NOT IN CONTRACT	SPECS	SPECIFICATIONS
@	AT	CRZ	CRITICAL ROOT ZONE	FL	FLOW LINE	NOM	NOMINAL	SS	SANITARY SEWER
AC	ASPHALT	CTSK	COUNTER SUNK	FLG	FLANGED	NTS	NOT TO SCALE	SSMH	SANITARY SEWER MANHOLE
ACC	ACCESSIBLE	DEPT	DEPARTMENT	FS	FINISH SURFACE ELEVATION	ОС	ON CENTER	STA	STATION POINT
ADJ	ADJUSTABLE	DF	DRINKING FOUNTAIN	FTG	FOOTING	OD	OUTSIDE DIAMETER	SWL	STATIC WATER LEVEL
AFF	ABOVE FINISH FLOOR	DG	DECOMPOSED GRANITE	GALV	GALVANIZED	PA	PLANT AREA	TBR	TO BE REMOVED
ALT	ALTERNATE	DIA	DIAMETER	GB	GRADE BREAK	PC	PLUMBING CONTRACTOR	TC	TOP OF CURB
AG	AGGREGATE	DIM	DIMENSION	HD	HOT DIPPED	POB	POINT OF BEGINNING	TFTG	TOP OF FOOTING
APPROX	APPROXIMATE	DS	DOWN SPOUT	HDR	HEADER	POC	POINT OF CONNECTION	THK	THICK
ARCH	ARCHITECTURAL	DWG	DRAWING	HOR	HORIZONTAL	POT	POINT OF TANGENCY	TP	TOP OF PAVING
ВС	BOTTOM OF CURB	EA	EACH	HP	HIGH POINT	PNT	POINT	TS	TOP OF STEP
BLDG	BUILDING	(E)	EXISTING	INV	INVERT ELEVATION	PT	PRESSURE TREATED	TRANS	TRANSFORMER
вос	BACK OF CURB	EC	ELECTRICAL CONDUCTOR	IRRIG	IRRIGATION	R	RADIUS	TW	TOP OF WALL
BOW	BACK OF WALK	EG	EXISTING GRADE	JB	JUNCTION BOX	RDWD	REDWOOD	TYP	TYPICAL
BW	BASE OF WALL	EJ	EXPANSION JOINT	LA	LANDSCAPE ARCHITECT	REBAR	REINFORCEMENT BAR	UON	UNLESS OTHERWISE NOTED
СВ	CATCH BASIN	ELEV	ELEVATION	LF	LINEAR FEET	REQ'D	REQUIRED	VERT	VERTICAL
CIP	CAST IN PLACE	EP	EDGE OF PAVING	MAX	MAXIMUM	RIM	RIM ELEVATION	W/	WITH
CJ	CONTROL JOINT	EQ	EQUAL	MB	MACHINE BOLT	RO	ROUGH	WC	WATER CLOSET
Ę.	CENTERLINE	EXP	EXPOSED	MC	MECHANICAL CONTRACTOR	RP	RADIUS POINT	WP	WEAKEND PLANE JOINT
CLR	CLEAR	FOB	FACE OF BUILDING	MFG	MANUFACTURER	S/S	STAINLESS STEEL	WWM	WELDED WIRE MESH
СО	CLEAN OUT	FOC	FACE OF CURB	MIN	MINIMUM	SCH	SCHEDULE		
CONC	CONCRETE	FD	FLOOR DRAIN	MTL	METAL	SIM	SIMILAR		
CONT	CONTINUOUS	FFE	FINISH FLOOR ELEVATION	(N)	NEW	SF	SQUARE FOOT		

ENVIRONMENTAL NOTES

1. THIS PROJECT IS LOCATED IN A FEMA SPECIAL FLOOD HAZARD AREA PARCEL. THE BFE IN THIS AREA IS 17FT (NAVD 88)

GENERAL NOTES

- 1 DESIGN INTENT: THESE DRAWINGS AND ACCOMPANYING TECHNICAL SPECIFICATIONS REPRESENT THE GENERAL DESIGN INTENT TO BE IMPLEMENTED ON THE SITE. THE CONTRACTOR SHALL BE RESPONSIBLE FOR CONTACTING THE ARCHITECT FOR ANY ADDITIONAL CLARIFICATION OR DETAILS NECESSARY TO ACCOMMODATE SITE CONDITIONS
- CONTRACTOR SHALL INFORM THEMSELVES OF AND FULLY ADHERE TO THE ZONING AND ORDINANCE REGULATIONS OF THE CITY AND/OR COUNTY WHERE THE PROJECT IS LOCATED, THE RULES, REGULATIONS AND EQUIREMENTS OF ALL GOVERNMENTAL AGENCIES HAVING JURISDICTION OVER THE WORK, AND ALL FEDERAL AND STATE LAWS, CODES OR REGULATIONS I
- 4. CONTRACTOR SHALL IMMEDIATELY NOTIFY THE OWNERS REPRESENTATIVE IF DISCREPANCY IS SUSPECTED BETWEEN THE SITE AND WHAT IS CONTAINED IN THE CONTRACT DOCUMENTS. NO ALLOWANCES WILL BE MADE TO THE CONTRACTOR DUE TO THEIR LACK OF FAMILIARITY WITH THE SITE CONDITIONS, CONTRACTOR SHALL CALL OUT "USA"-JUNDERGROUND SERVICE ALERT (800-642-2444) AND HAVE USA THOROUGHLY MARK OUT ALL PUBLIC UTILITIES ON, OR ADJACENT TO THE SITE PRIOR TO ANY DEMOLITION OR EXCAVATION WORK. CONTRACTOR SHALL RECORD OR MAINTAIN USA MARKINGS IN LEGIBLE AND ACCESSIBLE FORM FOR
- 5. CONTRACTOR SHALL AT ALL TIMES PROVIDE NOISE, DUST AND LITTER CONTROL ON THE PROJECT IN ACCORDANCE WITH GOVERNING AGENCIES OR DOCUMENTS LISTED ABOVE AND PER THE DISCRETION OF THE OWNERS REPRESENTATIVE.
- CONTRACTORS WORK, CONTRACTOR MUST HAVE ACCEPTABLE ALTERNATE METHODS IN PLACE PRIOR TO INTERRUPTION. THE OWNERS REPRESENTATIVE SHALL DETERMINE THE ACCEPTABLLITY OF SUCH ALTERNATE
- 7. CONTRACTOR SHALL PROVIDE AND MAINTAIN FROSION CONTROL MEASURES IN CONFORMANCE WITH STANDARD CONSTRUCTION PRACTICES AS REQUIRED TO PROTECT THE PROJECT AND/OR ADJACENT PROPERTIES FROM DAMAGES DUE TO NATURAL OR MAN-MADE EROSIVE FORCES.
- CONTRACTOR IS RESPONSIBLE FOR REPAIRING OR REPLACING DAMAGES OR DAMAGED AREAS TO AN AS-WAS OR BETTER CONDITION IF IT CAN BE REASONABLY CONSTRUED THAT SUCH DAMAGES WERE DUE TO THE CONTRACTORS CONSTRUCTION ACTIVITY OR LACK OF AMPLE PROTECTIVE MEASURES. REPAIRS SHALL BE MADE SUBJECT TO THE DISCRETION OF THE OWNERS REPRESENTATIVE.
- PRESENTED TO THE OWNERS REPRESENTATIVE ACCURATELY AND/OR GRAPHICALLY ON RECORD DRAWINGS PRIOR TO FINAL ACCEPTANCE. REFER TO SPECIFICATIONS FOR ADDITIONAL CLOSE-OUT INFORMATION
- 10. CONTRACTOR SHALL DILIGENTLY PROTECT THE PROJECT SITE AND ALL CONSTRUCTION MATERIALS FROM VANDALISM OR DAMAGE UNTIL PROJECT FINAL ACCEPTANCE
- 11. CONTRACTOR SHALL PROVIDE DRINKING WATER AND PORTABLE REST ROOM FACILITIES FOR WORKER USE DURING CONSTRUCTION AT CONTRACTORS EXPENSE

AREA MAP



SHEET INDEX

	SHEET INDEX						
_	SECTION G -	GENERAL					
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5	SECTION L -	LANDSCAPE					
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5	SECTION A -	ARCHITECT					
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SECTION C - CIVIL

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C-3.10	DRIVEWAY PLAN
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SECTION E - ELECTRICAL

PROJECT TEAM:

LANDSCAPE ARCHITECT SSA LANDSCAPE ARCHITECTS, INC. CONTACT: CHRISTIAN HARRIS 303 POTRERO STREET, SUITE 40-C SANTA CRUZ, CA 95060 (831) 459 - 0455

BIOLOGICAL CONSULTANT ECOSYSTEMS WEST CONSULTING GROUP CONTACT: JUSTIN DAVILLA 180 7TH AVENUE SUITE 201 SANTA CRUZ, CA 95062 (831) 429-6730

CIVIL ENGINEER MME CIVIL + STRUCTURAL ENGINEERING CONTACT: RODNEY CAHILL 224 WALNUT AVE #B SANTA CRUZ, CA 95060 (831) 426-3186

ARCHITECT SPECTOR CORBETT ARCHITECTS CONTACT: BRIAN SPECTOR 54-C PENNY LANE WATSONVILLE, CA 95076 (831) 319-4045

GEOTECHNICAL ENGINEER PACIFIC CREST ENGINEERING CONTACT: SOMA GORESKY 444 AIRPORT BLVD, SUITE 106 WATSONVILLE, CA 95076 (831) 722-9446

ELECTRICAL ENGINEER SALAS O'BRIEN ENGINEERS INC. CONTACT: JEFFREY GOSAL 305 SOUTH 11TH STREET SAN JOSE, CA 95112

PROJECT MAP



APPLICABLE STANDARD PLANS


CALIFORNIA BUILDING CODE

2022 CALIFORNIA GREEN BUILDING STANDARDS CODE
2022 BUILDING STANDARDS ADMINISTRATIVE CODE, PART 1, TITLE 24 C.C.R.
2022 CALIFORNIA BUILDING CODE (CBC), PART 2, TITLE 24 C.C.R.
2022 CALIFORNIA ELECTRICAL CODE (CBC), PART 3, TITLE 24 C.C.R.
2022 CALIFORNIA MECHANICAL CODE (CMC), PART 4, TITLE 24 C.C.R.
2022 CALIFORNIA PLIMBING CODE (CPC), PART 5, TITLE 24 C.C.R.
2022 CALIFORNIA FIRE CODE (CFC), PART 9, TITLE 24 C.C.R.
2022 CALIFORNIA FIRE CODE (CFC), PART 9, TITLE 24, C.C.R.
2022 CALIFORNIA FIRE SAFETY, OFFICE OF THE STATE FIRE MARSHAL REGULATIONS
2022 NFPA 72 - NATIONAL FIRE ALARM CODE WITH CALIFORNIA AMENDMENTS

PROJECT DESCRIPTION

THIS PROJECT IS LOCATED IN A FEMA SPECIAL FLOOD HAZARD AREA PARCEL AND THE BFE IN THIS AREA IS 17FT (NAVD 88). THIS PROJECT INTENDS TO REPLACE AN EXISTING BARN AT WATSONVILLE SLOUGH FARM. TWO NEW PREFABRICATED RESTROOM BUILDINGS, PICNIC AREAS, AND FARMWORKER HOUSING. ADA ACCESSIBLE WALKWAYS AND PARKING FACILITIES WILL BE ADDED TO ALLOW FOR PUBLIC ACCESS. THE PROJECT WILL CONNECT TO, AND MODIFY EXISTING SITE UTILITIES. THE WORK GENERALLY INCLUDES THE FOLLOWING DISCIPLINES:

- SELECTIVE DEMOLITION
- SELECTIVE DEMOLITION
 TREE PROTECTION
 EXISTING UTILITY PROTECTION
 GRADING & EROSION CONTROL
 SITE HARDSCAPE & SOFTSCAPE
 BARN STRUCTURE
 PRE-FABRICATED RESTROOM BUILDINGS
 GUADA & GUATER
- CURB & GUTTER

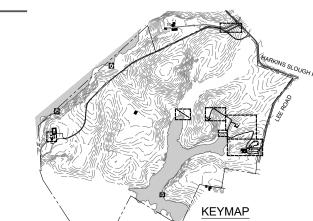



p: 831.459.0455 f: 831-459-0484



SONVILLE SLOUGH FARM IMUNITY HARVEST PROJECT

Ö

SHEET

OVER


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SCALE

COVER SHEET


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REVISIONS
NO. DATE PURPOSE

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SSA LANDSCAPE ARCHITECT

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crla no. 280

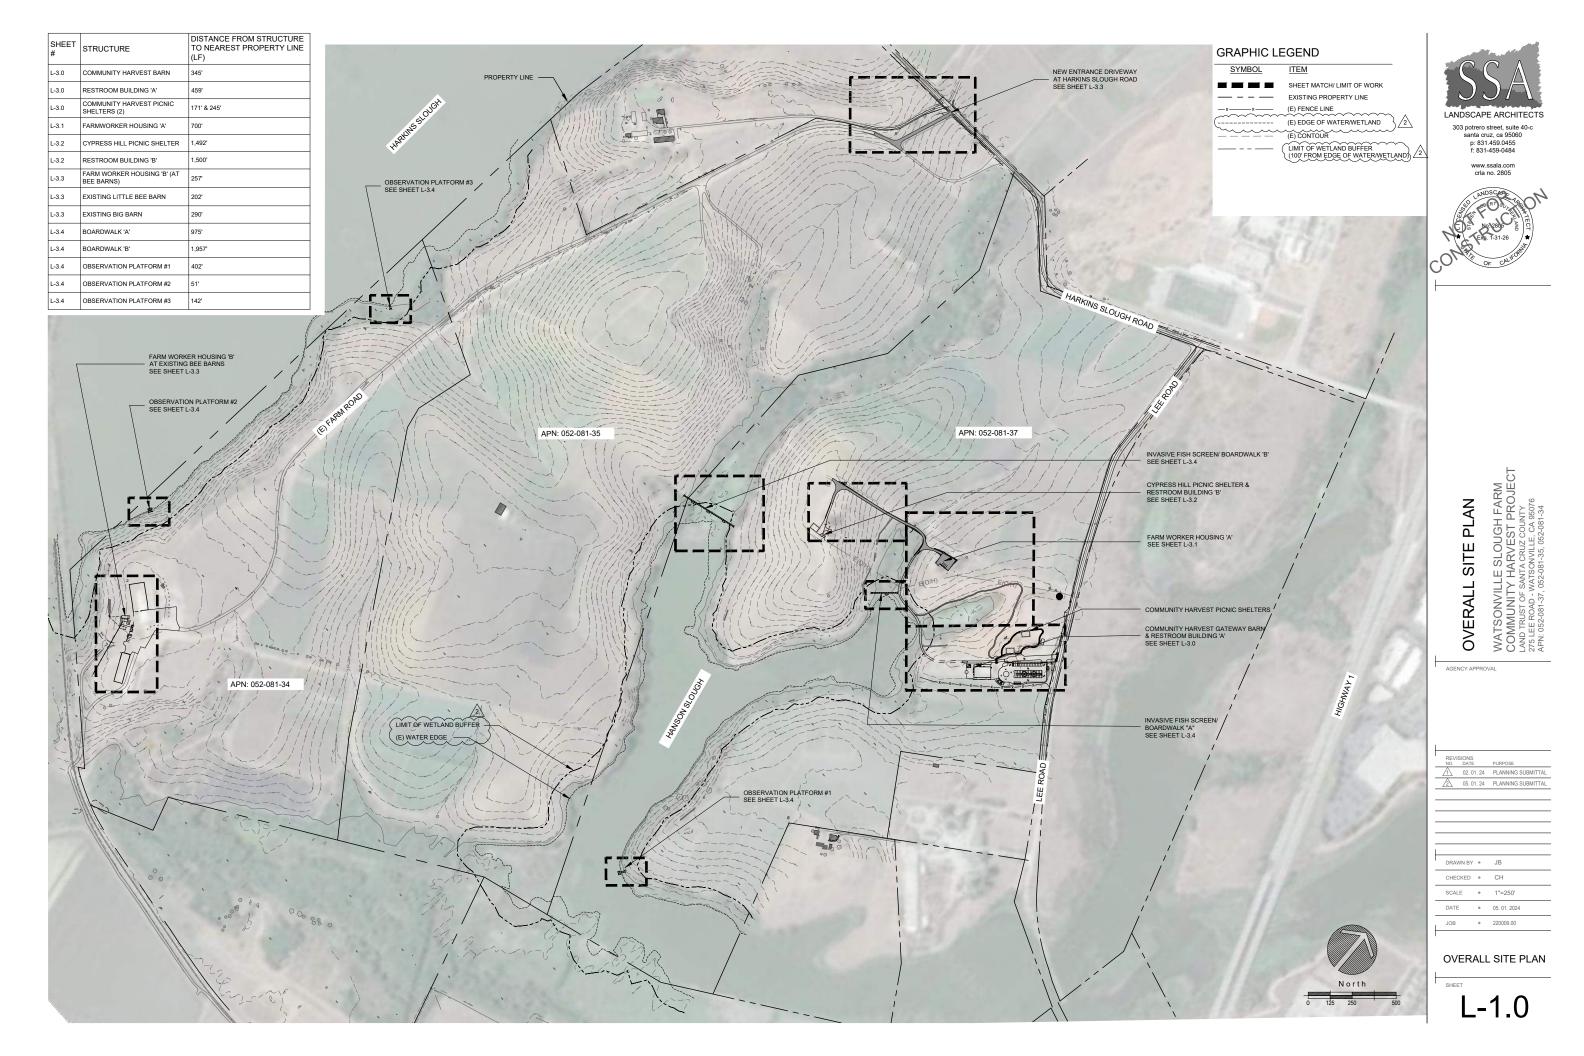

ACCESSIBILE ROUTE

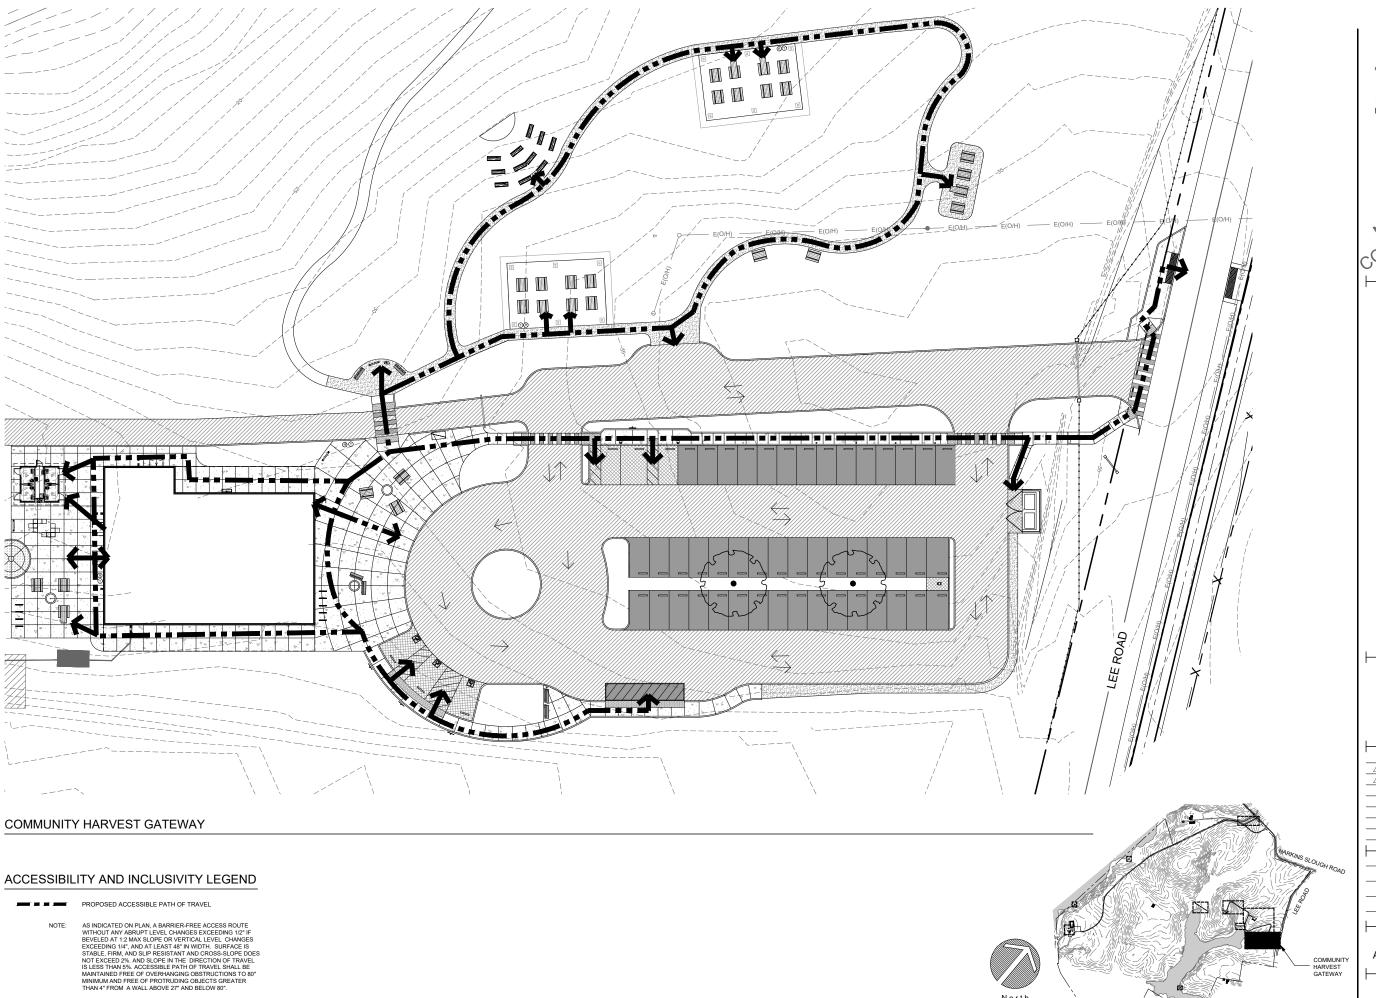GENCY APPROVAL

DRAWN BY • JB

CHECKED • CH

SCALE • 1"=20'-0"

CHECKED • CH


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DATE • 05.01.2024


KEYMAP

ACCESSIBILE ROUTE

L-1.2

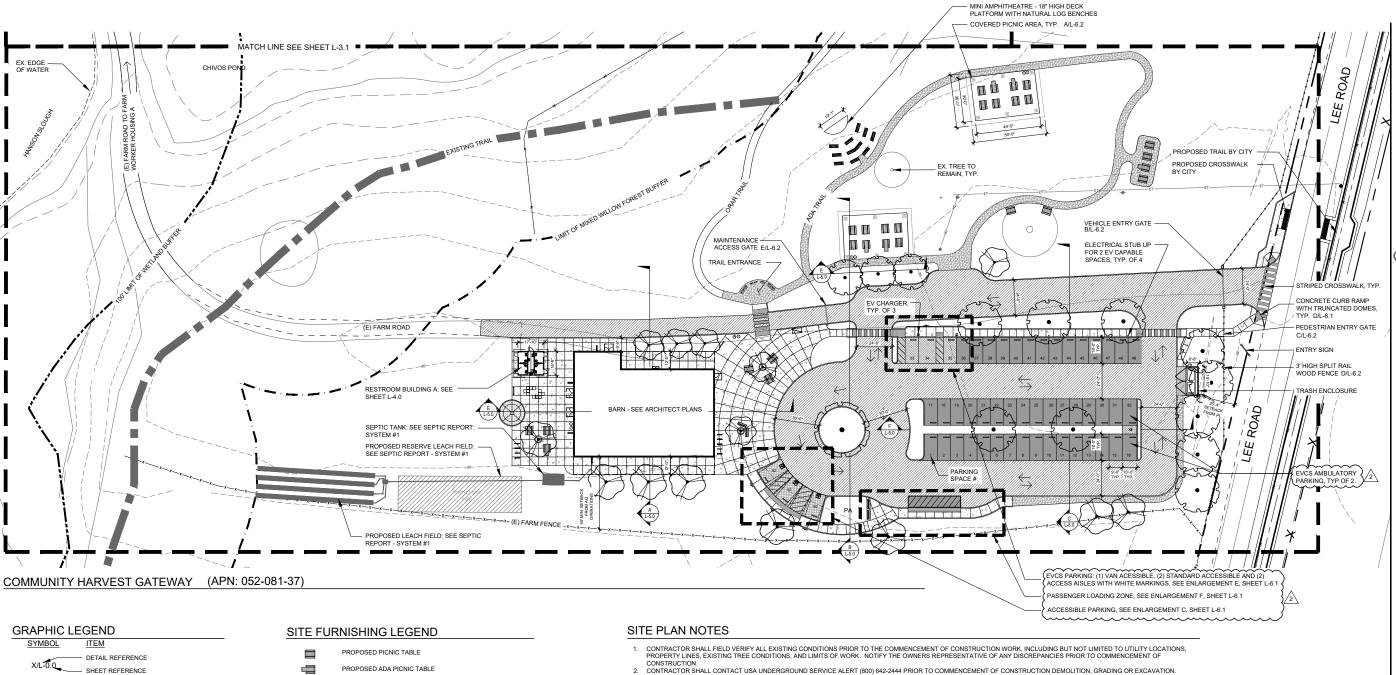

SHEET MATCH/ LIMIT OF WORK EXISTING EDGE OF WATER/WETLAND 2 LIMIT OF MIXED WILLOW FOREST BUFFER LIMIT OF WETLAND BUFFER (100' FROM EDGE OF WATER/WETLAND) /2 EXISTING PROPERTY LINE EXISTING TRAIL

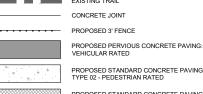



CONCRETE PAVING

PROPOSED DECOMPOSED GRANITE PAVING

PROPOSED ASPHALT MILL & OVERLAY ASHPALT PAVING

CLASS II BASE ROCK FARM ROAD

TRUNCATED DOMES

PROPOSED BENCH PROPOSED TRASH AND RECYCLING RECEPTACLE PROPOSED TRAIL MAP/COMMUNITY ANNOUNCEMENT BOARD PROPOSED ENTRY SIGN PROPOSED DRINKING FOUNTAIN & WATER BOTTLE FILL STATION PROPOSED MAGLIN - PIXEL BENCH BLOCKS

TREE SCHEDULE

SYMBOL	TREE TYPE	CONTAINER SIZE	QTY
	DECIDUOUS EVERGREEN EXISTING TREE TO REMAIN	24" BOX 24" BOX	15 16 3

PROPOSED DUAL SIDED BIKE LOCKER

PROPOSED EV CHARGING STATION

SHADE TREE CALCULATION

SPACE	SPACE AREA (SQ FT)	TREE QTY	SHADE AREA (SQ FT)	% SHADE COVERAGE
PARKING	26,422	15	14,430	55%
HARDSCAPE	37,428		15,392	49%
ANDSCAPE	11,652	28	25,974	223%

- CONTRACTION.
 CONTRACTOR SHALL CONTACT USA UNDERGROUND SERVICE ALERT (800) 642-2444 PRIOR TO COMMENCEMENT OF CONSTRUCTION DEMOLITION, GRADING OR EXCAVATION.
 CONTRACTOR SHALL PRESERVE AND PROTECT ALL EXISTING TREES AND VEGETATION THAT IS NOT SCHEDULED FOR DEMOLITION. REFER TO TREE PROTECTION NOTES. THIS MAY INCLUDE OFF-SITE TREES WHERE THE CANOPY OR ROOT SYSTEM EXTENDS BEYOND THE PROPERTY LINE. ACCESS ROUTES AND STAGING AREAS ARE TO BE STRICTLY ADHERED TO.

- ACCESS ROUTES AND STAGING AREAS ARE TO BE STRICTLY ADHERED TO.

 JPON COMPLETION OF ACCESS AND STAGING, THE SITE SHALL BE REPAIRED TO "AS WAS" OR BETTER THAN EXISTING CONDITIONS.

 THE CONTRACTOR SHALL CONTINUALLY REFER TO ALL DRAWINGS, ADDENDA, REPORTS AND SPECIFICATIONS DURING THE LIFE OF THE PROJECT FOR CONSTRUCTION INFORMATION.

 THE INTERFACE OF ALL PROPOSED IMPROVEMENTS TO THE EXISTING SITE SHALL CONFORM AND BE SMOOTH AND UNIFORM.
 ALL REINFORCING AND FORMS SHALL BE SECURED IN PLACE AND INSPECTED OWNER'S REPRESENTATIVE PRIOR TO PLACING ANY CONCRETE.

 CONTRACTOR IS SOLIELY RESPONSIBLE TO ARRANGE FOR ALL SITE INSPECTIONS AND OBSERVATIONS DESCRIBED IN THE CONTRACT DOCUMENTS. MINIMUM LEAD TIME FOR INSPECTION MORPHS EVALUATION BEFOR ITS AND ADDITIONAL PROJECTS IS AND ADDITIONAL PROJECTS IN ADDITIONAL PROJECTS IS AND ADDITIONAL PROJECTS IN ADDITIONAL PROJECTS IS AND ADDITIONAL PROJECTS IN ADDITIONAL PROJECTS IS AND ADDITIONAL PROJECTS IS AND ADDITIONAL PROJECTS IN ADDITIONAL PROJECTS ADDITIONAL PROJECTS AND ADDITIONAL PROJECTS ADDITIONAL PROJECT INSPECTION/OBSERVATION REQUESTS IS 48 HOURS.
- 10. REFER TO TECHNICAL SPECIFICATION AND GEOTECHNICAL INVESTIGATION REPORT FOR SUB-BASE AND COMPACTION REQUIREMENTS.

BIKE PARKING CALCULATION

TOTAL # OF BIKE PARKING SPACES	# OF CLASS II BIKE PARKING	# OF CLASS I BIKE PARKING (BIKE LOCKER)
11	9	2

ADA PARKING CALCULATION (PER CBC 11B-208.2, SEE FURTHER PARKING CALCULATIONS SHEET A100) # OF STANDARD ACCESSIBLE SPACES TOTAL # OF PARKING SPACES # OF VAN ACCESSIBLE SPACES

EV CHARGING CALCULATION PER CGBC TABLE 5.106.5.3.1 & CBC 11B - 228.3.2.1

TOTAL # OF ACTUAL PARKING SPACES	# OF EV CAPABLE SPACE PROVIDED (PER CGBC 5.106.5.3.1)	# OF EVCS PROVIDED (PER CGBC 5.106.5.3.1)	# OF EVCS PROVIDED BY TYPE (PER CBC TABLE 11B-228.3.2.1)
52	14 TOTAL: 3 CHARGERS = 6 EVCS 4 STUB UPS = 8 CAPABLE	6	1 VAN ACCESSIBLE (PARKING SPACE #34) 2 STANDARD ACCESSIBLE (PARKING SPACE #33 & #35) 2 AMBULATORY (PARKING SPACE #16 & #32)



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GATEWAY HARVEST COMMUNITY Ш SIT

SLOUGH FARM ARVEST PROJEC

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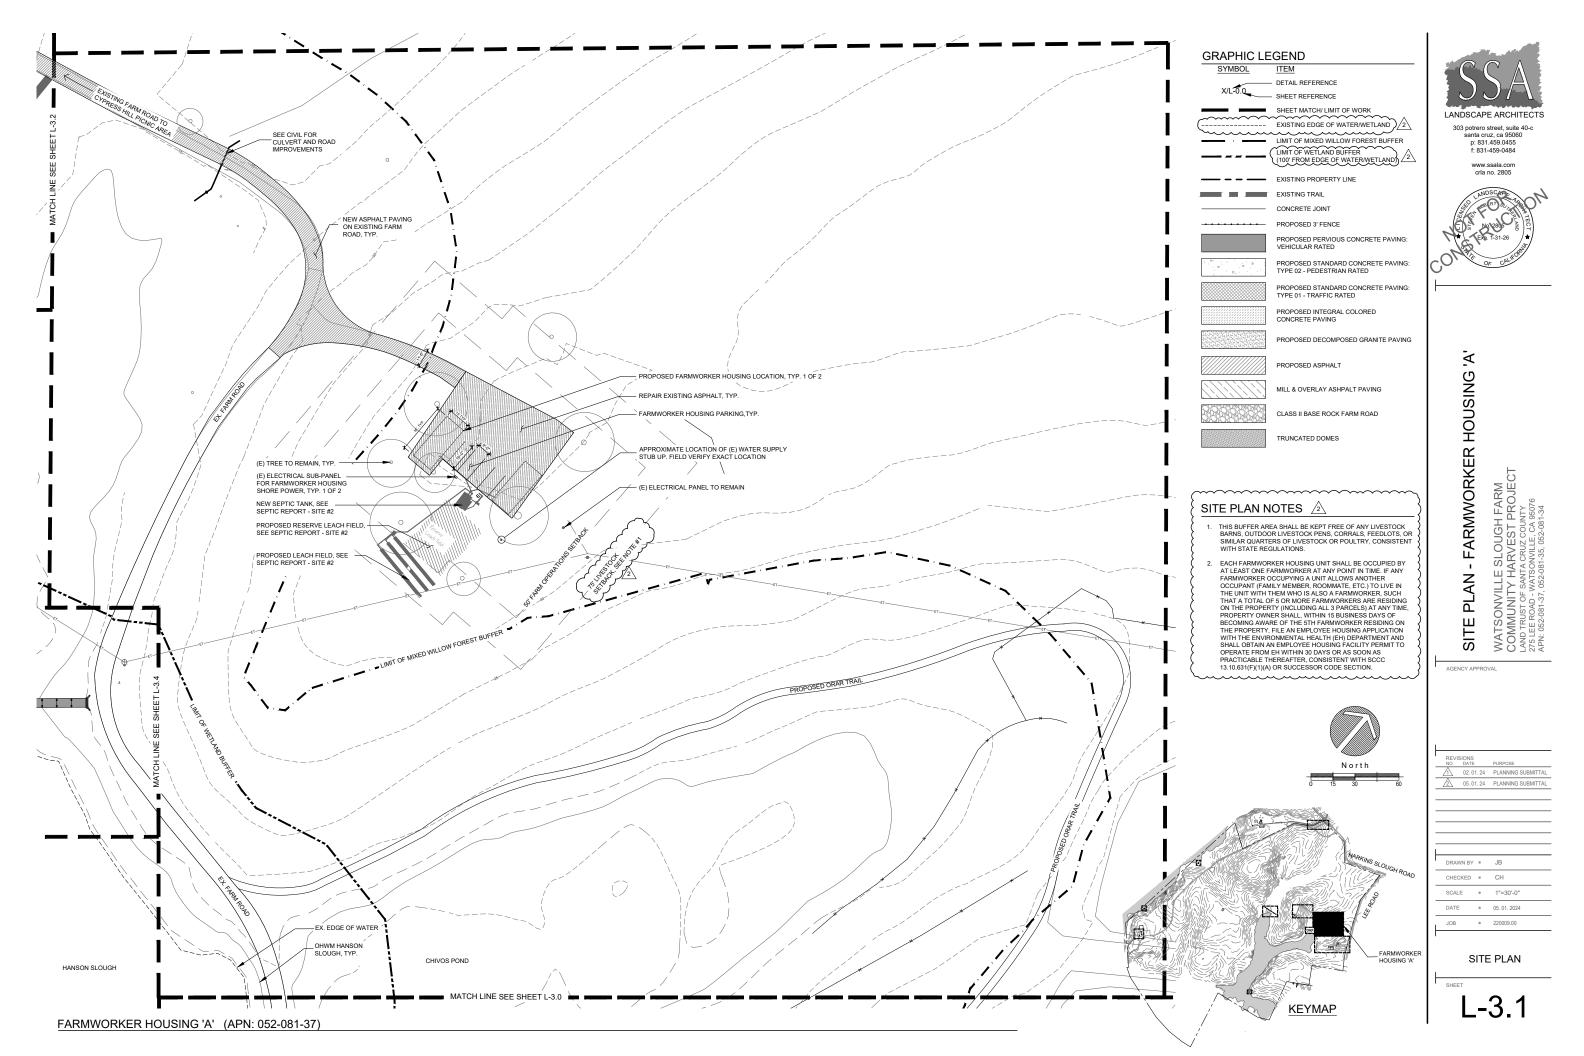
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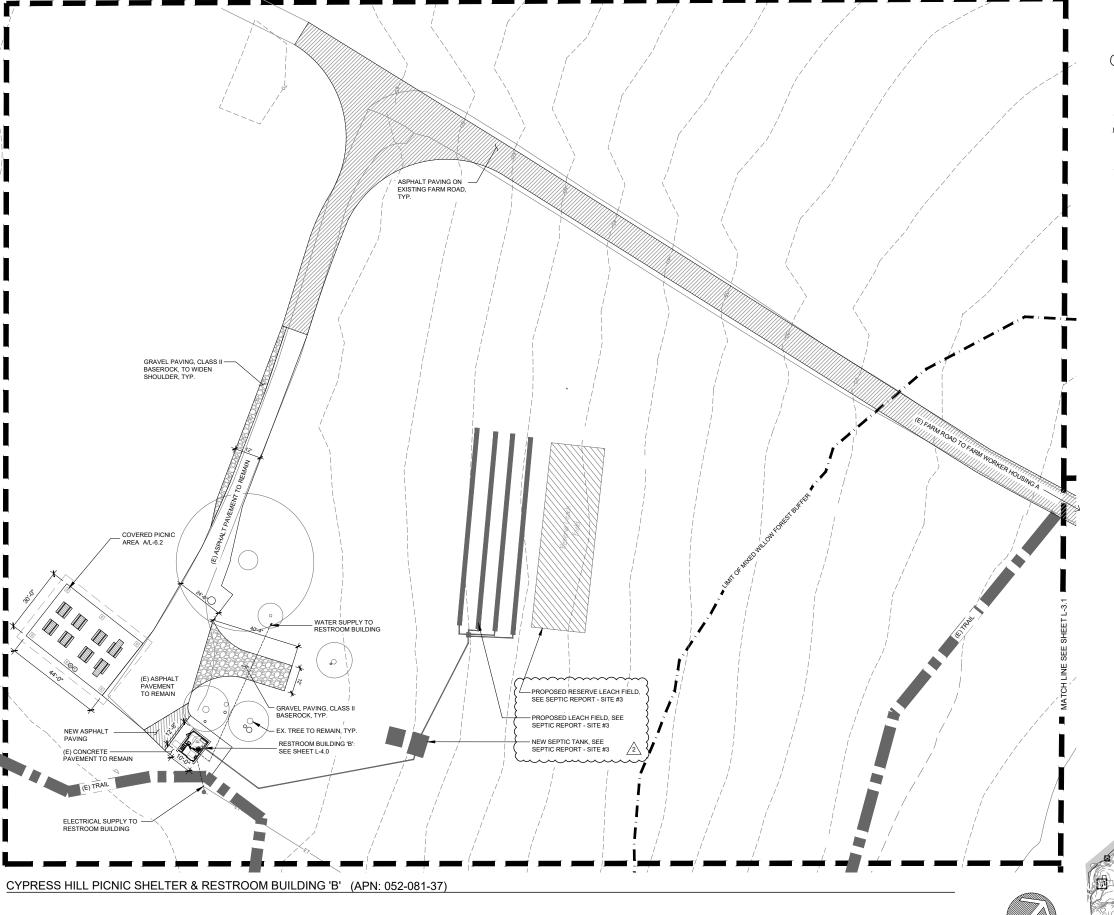
SITE PLAN

HARVEST GATEWAY

KEYMAP

220009.00





GRAPHIC LEGEND SYMBOL

DETAIL REFERENCE — SHEET REFERENCE

SHEET MATCH/ LIMIT OF WORK

EXISTING EDGE OF WATER/WETLAND /2

LIMIT OF MIXED WILLOW FOREST BUFFER

(100 FROM EDGE OF WATER/WETLAND)

2

EXISTING PROPERTY LINE

CONCRETE JOINT

PROPOSED 3' FENCE PROPOSED PERVIOUS CONCRETE PAVING:

PROPOSED STANDARD CONCRETE PAVING: TYPE 02 - PEDESTRIAN RATED

TYPE 01 - TRAFFIC RATED PROPOSED INTEGRAL COLORED CONCRETE PAVING

PROPOSED STANDARD CONCRETE PAVING:

PROPOSED DECOMPOSED GRANITE PAVING

PROPOSED ASPHALT MILL & OVERLAY ASHPALT PAVING

CLASS II BASE ROCK FARM ROAD

TRUNCATED DOMES

SITE FURNISHING LEGEND

PROPOSED PICNIC TABLE

PROPOSED TRASH AND RECYCLING RECEPTACLE

- 1

PROPOSED ADA PICNIC TABLE

SITE

AREA

- CYPRESS HILL PICNIC


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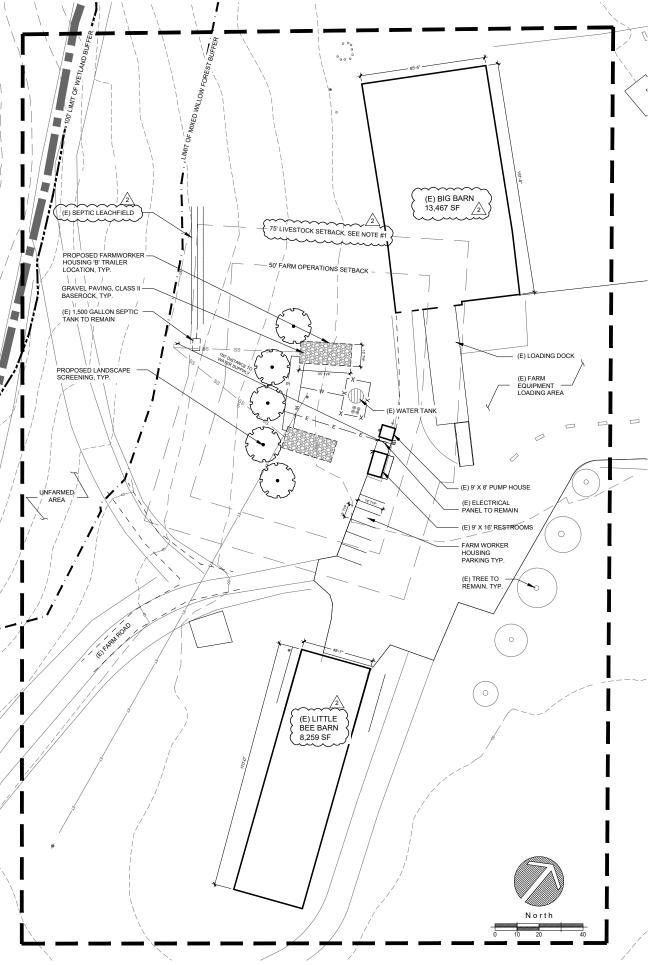
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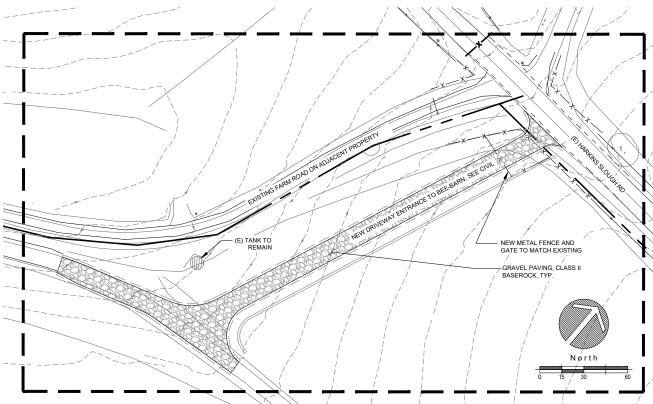
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SITE PLAN







NEW ENTRANCE DRIVEWAY AT HARKINS SLOUGH ROAD (APN: 052-081-35)

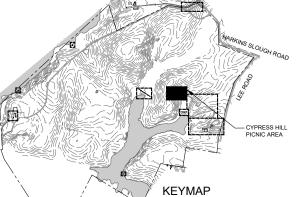SCALE = 1" = 40' /2

GRAPHIC LEGEND

SYMBOL DETAIL REFERENCE — SHEET REFERENCE

SHEET MATCH/LIMIT OF WORK

EXISTING EDGE OF WATER/WETLAND 2

LIMIT OF MIXED WILLOW FOREST BUFFER LIMIT OF WETLAND BUFFER (100' FROM EDGE OF WATER/WETLAND) 2

EXISTING PROPERTY LINE EXISTING TRAIL

> CONCRETE JOINT PROPOSED 3' FENCE

PROPOSED PERVIOUS CONCRETE PAVING: VEHICULAR RATED

PROPOSED STANDARD CONCRETE PAVING: TYPE 02 - PEDESTRIAN RATED PROPOSED STANDARD CONCRETE PAVING: TYPE 01 - TRAFFIC RATED

PROPOSED INTEGRAL COLORED CONCRETE PAVING

PROPOSED DECOMPOSED GRANITE PAVING


PROPOSED ASPHALT

MILL & OVERLAY ASHPALT PAVING CLASS II BASE ROCK FARM ROAD

TRUNCATED DOMES

SITE PLAN NOTES 🖄

- THIS BUFFER AREA SHALL BE KEPT FREE OF ANY LIVESTOCK BARNS, OUTDOOR LIVESTOCK PENS, CORRALS, FEEDLOTS, OR SIMILAR QUARTERS OF LIVESTOCK OR POULTRY, CONSISTENT WITH STATE REGULATIONS.
- EACH FARMWORKER HOUSING UNIT SHALL BE OCCUPIED BY AT LEAST ONE FARMWORKER AT ANY POINT IN TIME. IF ANY FARMWORKER OCCUPYING A UNIT ALLOWS ANOTHER OCCUPANT (FAMILY MEMBER, ROOMMATE, ETC.) TO LIVE IN THE HUNIT WITH THEM WHO IS ALSO A FARMWORKER, SUCH THAT A TOTAL OF OR MORE FARMWORKERS ARE RESIDING ON THE PROPERTY (INCLUDING ALL 3). OR MORE FARMWORKERS ARE RESIDING ON THE PROPERTY (INCLUDING ALL 3 PARCELS) AT ANY TIME, PROPERTY OWNER SHALL, WITHIN 15 BUSINESS DAYS OF BECOMING AWARE OF THE 5TH FARMWORKER RESIDING ON THE PROPERTY, FILE AN EMPLOYEE HOUSING APPLICATION WITH THE ENVIRONMENTAL HEALTH (EH) DEPARTMENT AND SHALL OBTAIN AN EMPLOYEE HOUSING FACILITY PERMIT TO OPERATE FROM EH WITHIN 30 DAYS OR AS SOON AS PRACTICABLE THEREAFTER, CONSISTENT WITH SCCC 13.10.631(F)(1)(A) OR SUCCESSOR CODE SECTION.

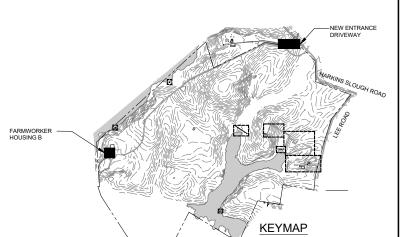



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ğΩ AN - FARMWORKER HOUSING DRIVEWAY VILLE SLOUGH FARM


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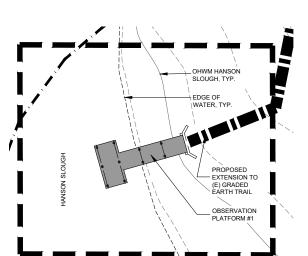
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SCALE . SEE PLANS 220009.00


SITE PLAN

FARMWORKER HOUSING 'B' - AT BEE BARN (APN: 052-081-34) (SCALE = 1" = 30') 2




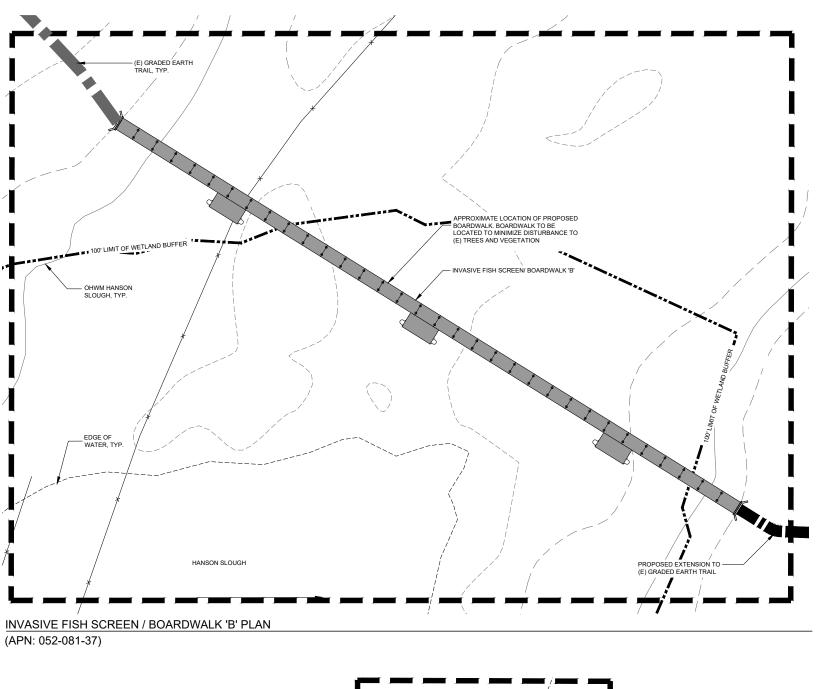


OBSERVATION PLATFORM #1 (HANSON SLOUGH) (APN: 052-081-37)

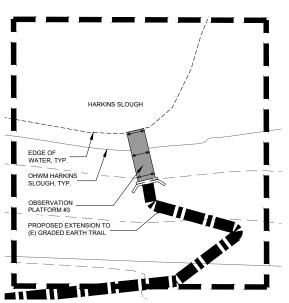

OBSERVATION PLATFORM #3 (HARKINS SLOUGH) (APN: 052-081-34)

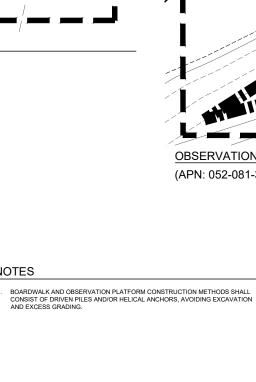


NOTES

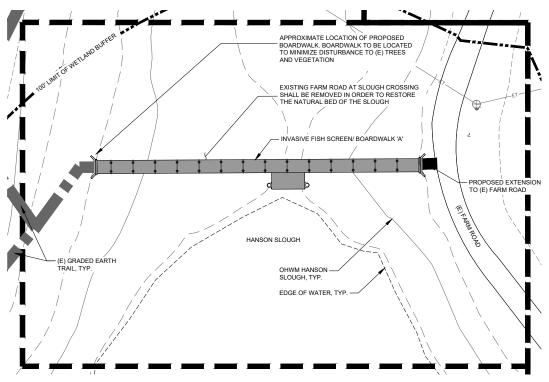


INVASIVE FISH SCREEN / BOARDWALK 'A' PLAN

(APN: 052-081-37)

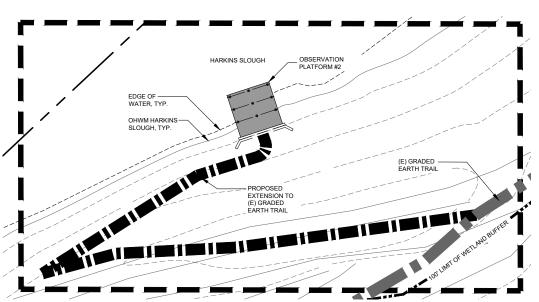

OBSERVATION PLATFORM #2 (HARKINS SLOUGH)

(APN: 052-081-34)

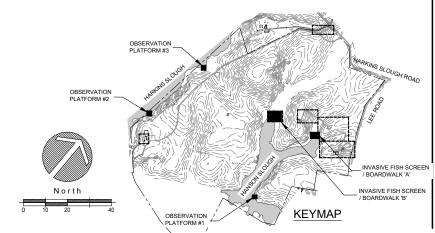



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E PLAN - BOARDWALKS & SERVATION PLATFORMS SONVILLE SLOUGH FARM IMUNITY HARVEST PROJECT

SITE | OBSE WATSO COMMU


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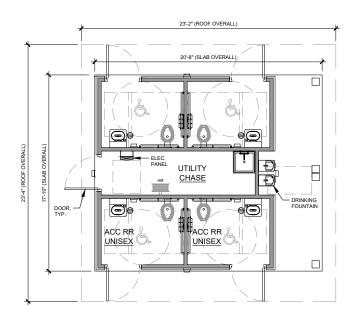
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SITE PLAN

L-3.4






LANDSCAPE ARCHITECTS 303 potrero street, suite 40-c santa cruz, ca 95060 p: 831.459.0455 f: 831-459-0484

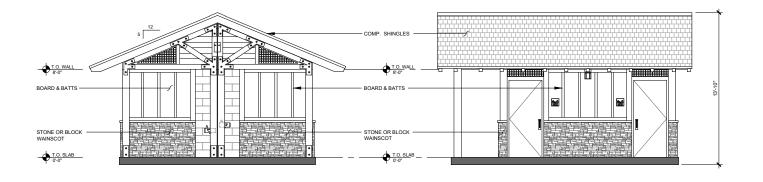
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RESTROOM BUILDING A - ELEVATION



RESTROOM BUILDING A - PLAN VIEW

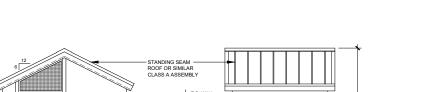

DRINKING FOUNTAIN W/ BOTTLE FILLER

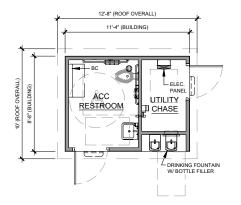RESTROOM BUILDING B - ELEVATION

SCAL F-1/A" = 1*-0" SCALE:1/4" = 1'-0"

GENERAL SITE CONDITION LIABILITY NOTE:

THE FOLLOWING NOTES DEFINES TYPICAL CONTRACTOR RESPONSIBILITES AND DUTIES REQUIRED FROM THE BUILDING MANUFACTURER FOR SITE PLACEMENT OF THE PREFABRICATED RESTROOM BUILDING. THESE NOTES ARE INTENDED TO BE USED AN AID FOR BIDDING PURPOSES ONLY. ACTUAL RESPONSIBILITES WILL BE NEGOTIATED BETWEEN THE GENERAL CONTRACTOR AND THEIR BUILDING VENDOR/MANUFACTURER.

GENERAL CONTRACTOR AND RESTROOM COMPANY RESPONSIBILITIES


RESTROOM MANUFACTURER:

- RESTROOM MANUFACTURER WILL PROVIDE FULL ARCHITECTURAL PLANS AND ENGINEERING CALCULATIONS, STAMPED BY STATE GOVERNING
 AGENCY SUITABLE FOR GENERAL CONTRACTOR TO FILE FOR REQUIRED BUILDING PERMIT.
- RESTROOM MANUFACTURER WILL FURNISH AND INSTALL UNDERGROUND UTILITIES (UNDER SLAB EXTENDING 6 FEET (MAX) BEYOND THE BUILDING LINE, MIN. OF 24" MAX. OF 36" BELOW GRADE.

- GENERAL CONTRACTOR:

 1. GENERAL CONTRACTOR SHALL CONSTRUCT BUILDING PAD PER DETAILS ON THIS SHEET AND SCOPE OF WORK. GENERAL CONTRACTOR SHALL INSTALL UTILITIES PER CIVIL, ELECTRICAL AND LANDSCAPE DRAWINGS AND THIS
- GENERAL CONTRACTOR IS RESPONSIBLE FOR UTILITY CONNECTIONS AND WILL MAKE FINAL CONNECTIONS TO SEWER, WATER AND POWER AT STUB LOCATION 6 FEET FROM BUILDING.
- 3. GENERAL CONTRACTOR TO PREPARE SITE FOR MINIMUM ALLOWABLE SOIL BEARING PRESSURE OF 1,500 PSF. WITH SUB-GRADE COMPACTED TO 90% M.D.D. REFER TO DRAWINGS, SPECIFICATIONS AND GEOTECHNICAL REPORT FOR SITE SPECIFIC SUBGRADE AND PAD PREPARATION REQUIREMENTS.
- 4. GENERAL CONTRACTOR TO SUPPLY AND STOCK PILE REQUIRED QUANTITY OF GENERAL CONTRACTOR TO SUPPLY AND STOCK PILE REQUIRED QUANTITY OF COARSE SAND WITHIN BUILDING PROXIMITY FOR USE BY BUILDING MANUFACTURER. (ELEVATION OF BASE TO BE DETERMINED AND VERIFIED BY THE GENERAL CONTRACTOR) PAD ELEVATION MUST BE LEVEL WITHIN 2% (+/-) AND COMPLY WITH ALL PERMISSIBLE CODES OF ACCESSIBILITY AND SAFETY. BEFORE BUILDING SET WET SAND FILL TO CONSOLIDATE AND/OR VIBRATE.

RESTROOM BUILDING B - FLOOR PLAN B SCALE:1/4" = 1'-0'

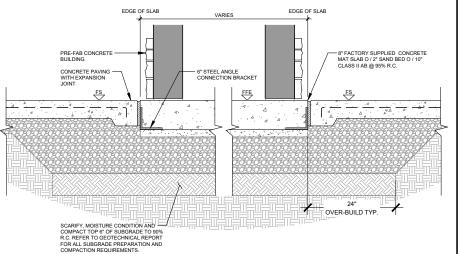

PLAN

RESTROOM PAD SECTION SCALE:1" = 1'-0"


STROOM BUILDING PLAN WATSONVILLE SLOUGH FARM COMMUNITY HARVEST PROJECT LAND TRUST OF SANTA CRUZ COUNTY APPLEAROD - WATSONVILE, CA 96076 APN: 052-081-37, 052-081-35, 052-081-34. RE


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DRAWN BY . CHECKED • SCALE


AS SHOWN

RESTROOM BUILDING



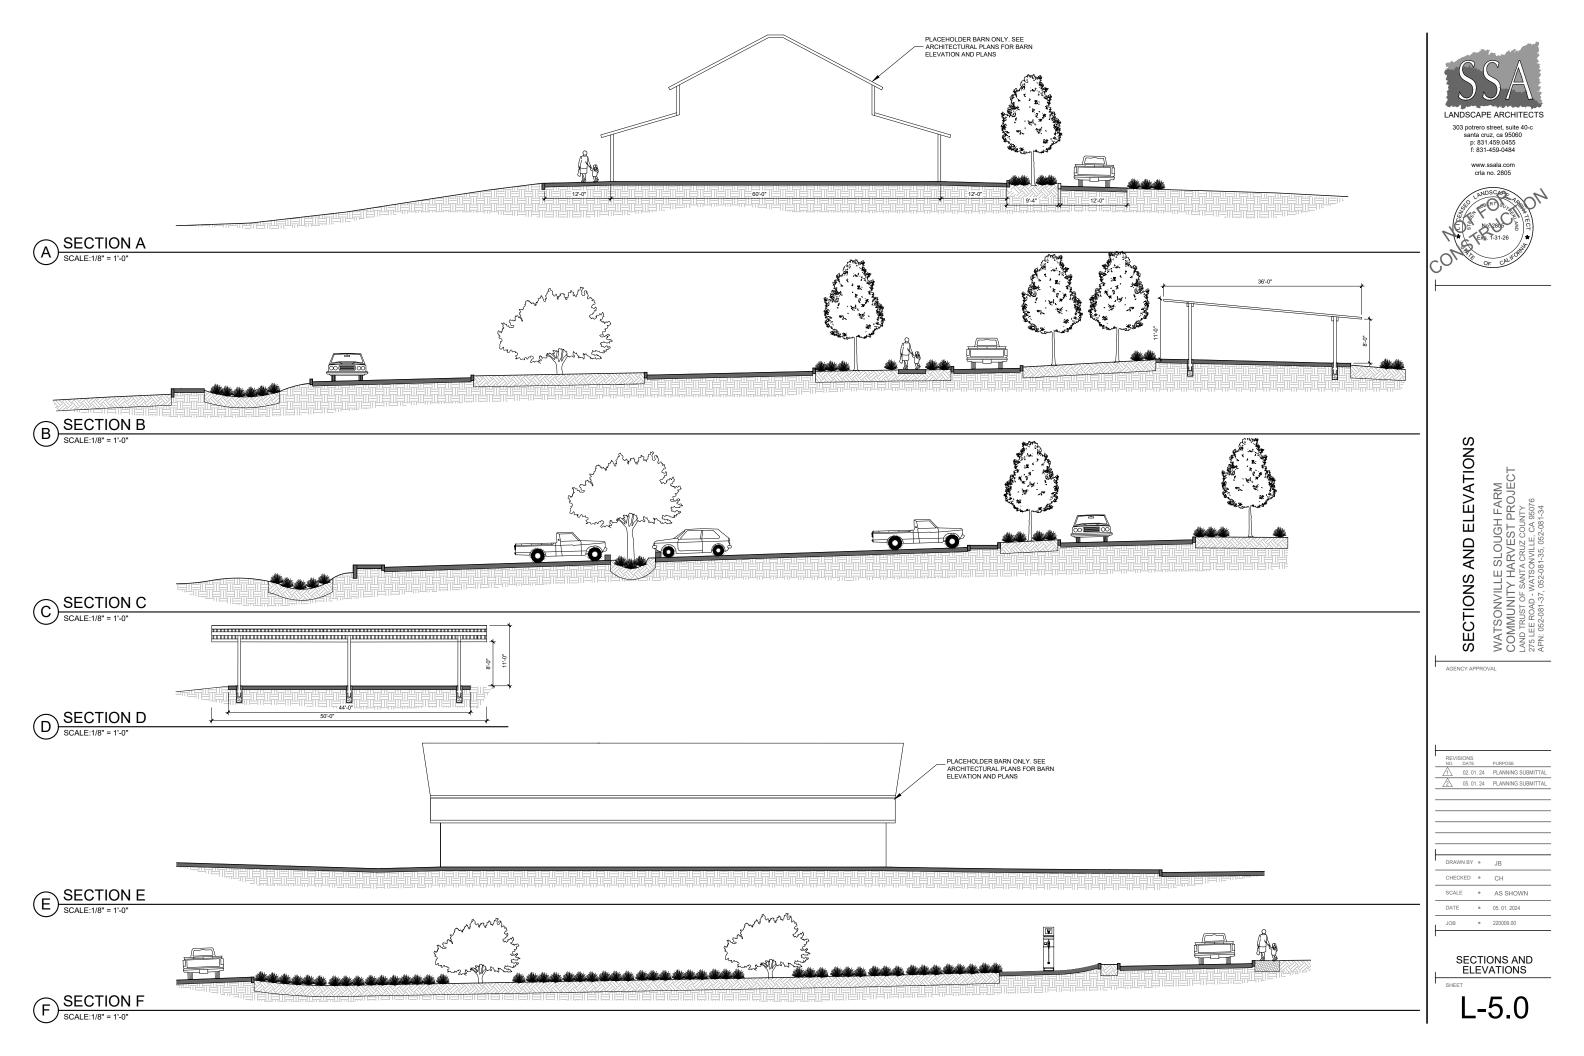


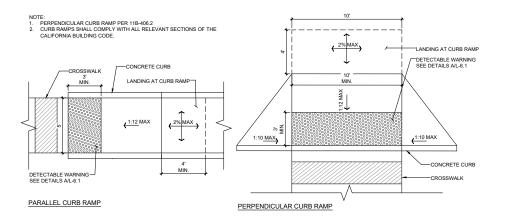
ACCESSIBLE CURB RAMP SCALE:1/4" = 1'-0"

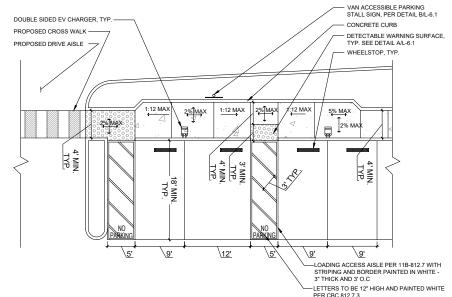

ACCESSIBLE EV CHARGING ENLARGEMENT (E SCALE:1/8" = 1'-0"



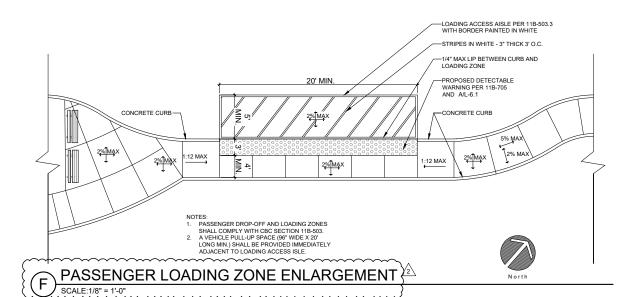

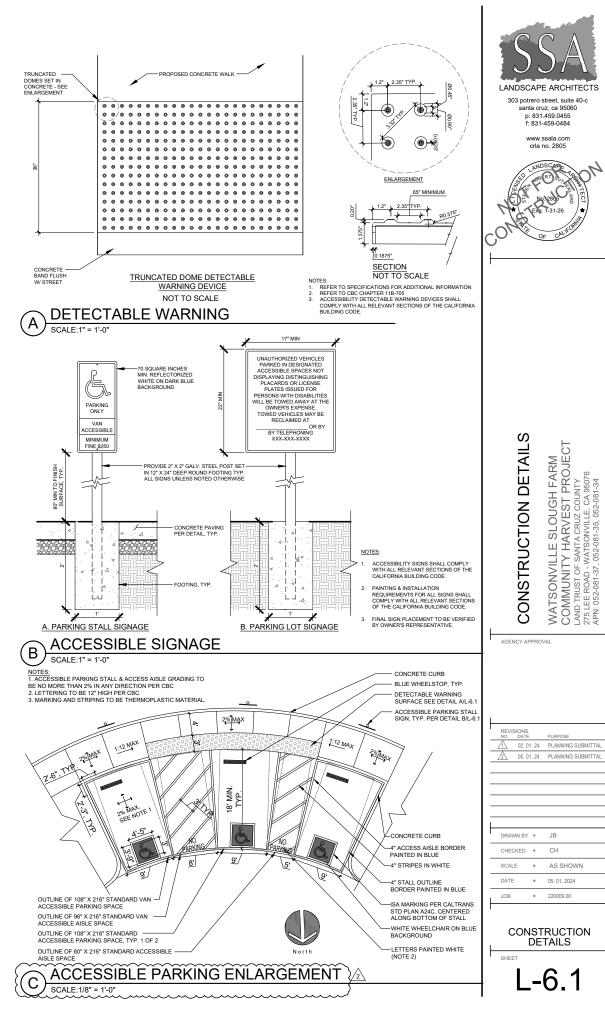


www.ssala.com crla no. 2805


WATSONVILLE SLOUGH FARM COMMUNITY HARVEST PROJECT LAND TRUST OF SANTA CRUZ COUNTY 275 LEE ROAD - WATSONVILLE, CA 95076 APN: 052-081-37, 052-081-35, 052-081-35

• 220009.00

DETAILS

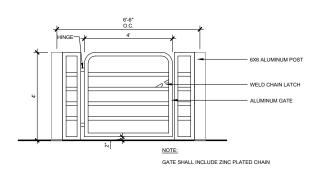

SINGLE GATE SCALE: 1/2" = 1'-0"

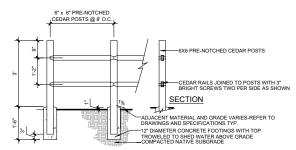

SECTION/ELEVATION


NOTES:

1. ALL WOOD SHALL BE "SPLIT RAIL AND POST" TYPE CEDAR. POSTS ARE APPROX. 6"X6". RAILS ARE APPROX. 3"X4".

2. CONFIRM POST LOCATION AND SPACING WITH OWNERS REPRESENTATIVE PRIOR TO COMMENCING WORK.


3. REFER TO DRAWINGS AND SPECIFICATIONS FOR ADDITIONAL INFORMATION.

SPLIT RAIL FENCE SCALE:1/2" = 1'-0"

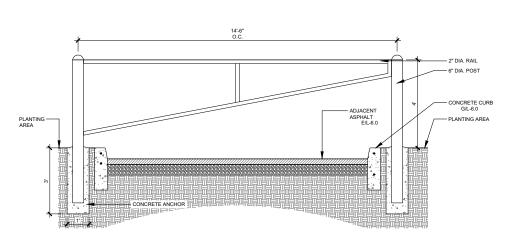


MAINTENANCE ACCESS GATE

SCALE:1/2" = 1'-0"

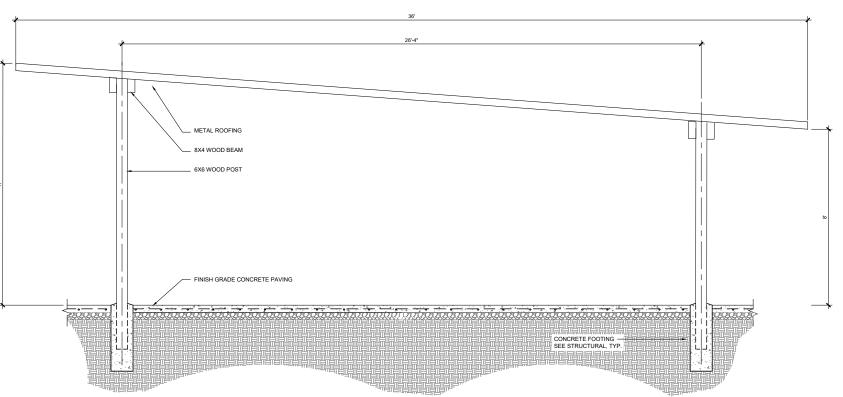

OVERED PICNIC AREA

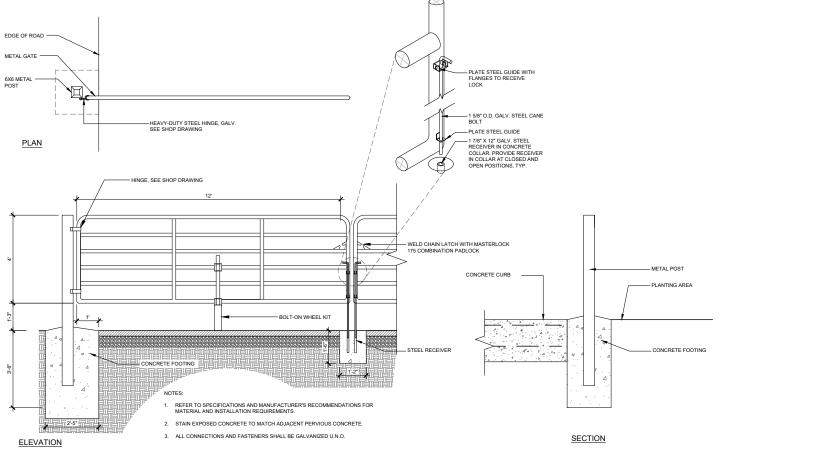

VEHICULAR ENTRANCE GATE
SCALE:1/2" = 1'-0" B



303 potrero street, suite 40-c santa cruz, ca 95060 p: 831.459.0455 f: 831-459-0484



CONSTRUCTION DETAILS

REVISIONS
NO. DATE PURPOSE

1 02. 01. 24 PLANNING SUBMITTAL 05. 01. 24 PLANNING SUBMITTAI

DRAWN BY . JB CHECKED . CH SCALE . AS SHOWN


• 220009.00

CONSTRUCTION DETAILS

L-6.2

OVERALL PROPERTY SITE PLAN

SCALE: 1" = 800'-0"

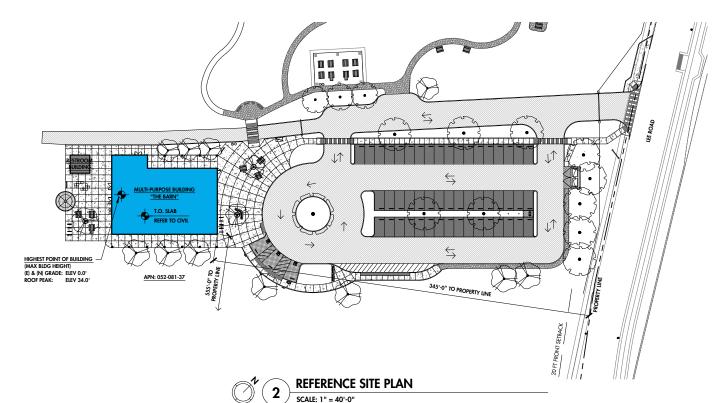







1: VIEW FROM NORTHEAST - SITE ENTRY APPROACH



4: VIEW FROM SOUTHEAST



3: VIEW FROM SOUTHWEST

BUILDING VISUALIZATIONS

PROJECT INFORMATION

WATSONVILLE SLOUGH FARM COMMUNITY HARVEST PROJECT MULTI-PURPOSE BUILDING - "THE BARN"

LAND TRUST OF SANTA CRUZ COUNTY
CONTACT: BRYAN LARGAY, CONSERVATION DIRECTOR
617 WATER STREET, SANTA CRUZ, CA 95060
831-234-1177 | BRYAN.LARGAY@LANDTRUSTSANTACR

SPECTOR CORBETT ARCHITECTS INC CONTACT: BRIAN SPECTOR, PRINCIPAL ARCHITECT 54-C PENNY LANE, WATSONVILLE, CA 95076 (831) 319-4045 | BRIANS@SPECTORCORBETT.COM

PROJECT ADDRESS 275 LEE ROAD, WATSONVILLE, CA 95076

A.P.N.: 052-081-37

VICINITY MAP:



VICINITY MAP

PROPOSED NEW CONSTRUCTION OF A MULTI-PURPOSE
BUILDING - "THE BARN". THIS IS A COMPONENT OF THE

PARCEL AREA

A-3 ASSEMBLY ASSEMBLY / TRAINING AREA
B BUSINESS OFFICE AND SUPPORT AREAS
U UTILITY BARN AREAS
MIXED OCCUPANCY: YES

TYPE OF CONSTRUCTION: V-B

FIRE SPRINKLERS: YES, FULLY SPRINKLERED, NEPA 13 FIRE SPRINKLER SYSTEM

34'-0", 2-STORY **BUILDING HEIGHT** 1ST FLOOR 2ND FLOOR .TOTAL:

JURISDICTION: SANTA CRUZ COUNTY
GENERAL PLAN (GP) DESIGNATION: A6 - AGRICULTURE
ZONING DESIGNATION: C4-W-AIA
CA-COMMERCIAL AG,
W - WATSONVILLE UTILITY PROHIF
AIA - AIRPORT

PROPOSED:

PARKING CALCULATIONS (PER SCC TABLE 13.16.050-1):

ADDITIONAL SITE NOTES: 1) REFER TO SITE DESIGN DRAWINGS BY SSA LANDSCAPE
ARCHITECTS FOR PARKING CALCULATION, ADA PARKING
SPACES, BICYCLE PARKING, AND EV CHARGING STATIONS
2) REFER TO SITE DESIGN DRAWINGS BY SSA LANDSCAPE
ARCHITECTS FOR SITE ADA/ACCESSIBILITY INFORMATION.

COLORS & MATERIALS

ROOFING COMPOSITE ROOF SHINGLE PHOTOVOLTAIC ARRAY

DOORS: ALUMINUM THERMALLY BROKEN DOORS

ALUMINUM THERMALLY BROKEN FOLD OVERHEAD COILING DOORS SLIDING DOORS

SHEET INDEX

SHEET NUMBER	SHEET TITLE
ARCHITECTURAL	
A100	PROJECT DATA & SITE PLAN
A101	CODE ANALYSIS
A200	FLOOR PLANS
A300	BUILDING ELEVATIONS & SECTION
-	

SANTA CRUZ | WATSONVILLE 831-319-4045

SPECTORCORBETT.COM


CT "THE BARN" SLOUGH

23039


WATS COMP MULT 275 LEE ROAD,

ET ISSUED:

PROJECT DATA & SITE PLAN

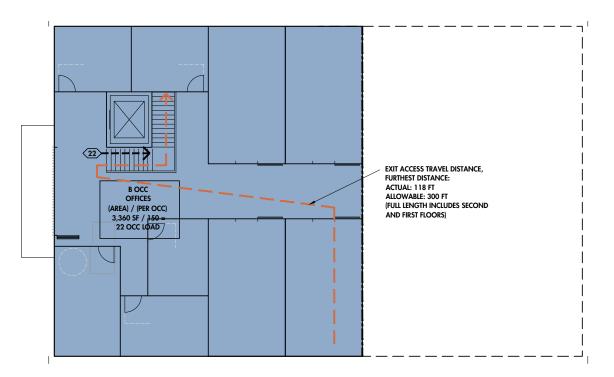



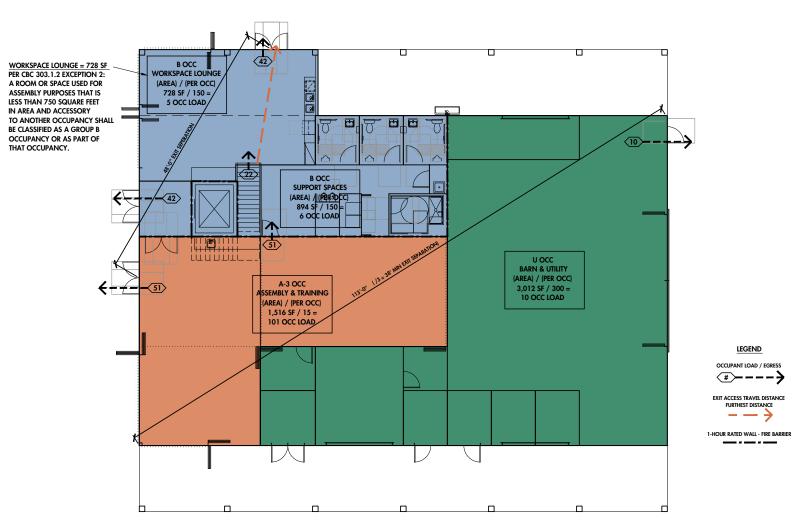

FIRST FLOOR - CODE ANALYSIS DIAGRAM SCALE: 1/8" = 1'-0"

	CO	DE	1A	NΑ	LYS	SIS			
APPLICABLE CODES:	2022 TITLE 2: PART 1 - CAL PART 2 - CAL PART 3 - CAL PART 4 - CAL PART 6 - CAL PART 9 - CAL PART 11 - CA	IFORNI IFORNI IFORNI IFORNI IFORNI IFORNI LLIFORN	A ADMI A BUILD A ELECT A MECH A PLUM A ENER A FIRE (INISTRA DING CO TRICAL HANICA BING CO GY CO CODE EN BUI	ATIVE CO ODE (CE CODE (C AL CODE CODE (CE DE (CEC	ODE (C BC) CEC) E (CMC PC)	AC)		ALGREEN)
OCCUPANCY & GROUP:	A-3 ASSE/ B BUSIN U UTILIT MIXED OCCU	MBLY IESS Y	ASSE/ OFFIC BARN	MBLY /	TRAINII	NG AR	EΑ		
TYPE OF CONSTRUCTION:	V-B								
FIRE SPRINKLERS:	YES, FULLY S	PRINKL	ERED, N	IFPA 13	B FIRE S	PRINK	LER SYST	ΓEΜ	
BUILDING HEIGHT:	ALLOWABLE	OCC A-3			KLERED		HEIGH 60 FT	łT	STORIES 2
	PROPOSED	B U		s s	,		60 FT 60 FT 34 FT		3 2 2
BUILDING AREA:	ALLOWABLE	OCC A-3 B U			IKLERED V/O IN		18,80 27,00 16,50	O SF	
		(AREA	A INCRI	ASE N	OT NEC	ESSAR	Y)		
	PROPOSED	MIXE	D USE, S	SEPARA AREA		CUPA 10 AR	NCIES (C	BC 508	
	LEVEL 1:	A-3 B		2,282		18,80	00	0.12	_
	LEVEL 2:	U B		3,360	1 RATIO	16,50 TOT 27,0	00 AL: 00	0.18 0.33 0.12 0.12	
	BUILDING AR	EAS:		OOR LOOR	2 KAIN	6,15 3,36	0 SF 0 SF	0.12	CI OK
SEPARATED OCCUPANCIES	· occu	IPANCY	.TOTA	L: A-3	В	9,51 U	U 5F		
			A-3 B U	N 1 N	1 N 1	N			ATION REQ'D EPARATION
FIRE-RESISTANCE RATING R	EQUIREMENTS WALL				S BASEI ISTANC				ON DISTANCE:
	.NORTH EAST	>10 F >10 F	T T				NON-	RATED RATED	
	WEST SOUTH	>10 F >10 F						RATED RATED	
MAXIMUM AREA OF EXTER OF OPENING PROTECTION		NINGS	BASED	ON FII	RE SEPA	RATIO	N DISTA	NCE A	ND DEGREE
	.NORTH	>20 F	T, UNP	ROTEC	ISTANC TED, SPI	RINKLE		NO LI	
	WEST SOUTH	>20 F	T, UNP	ROTEC	TED, SPI TED, SPI TED, SPI	RINKLE	RED	NO LI	IMIT
EGRESS	EGRESS OCC	UPANT	LOAD (CBC TA	BLE 100	04.5)			
	OCCUPANCY 1ST FLR:	A-3	2,282	SF	15 NE	T	OR	152	JPANTS .
	1ST FLR: 1ST FLR: 2ND FLR:	B U B	3,012 3,360	SF	150 G 300 G 150 G	ROSS		6 10 22	
	REQUIRED EX	ITS (CB		.3.3)	CUPAN		D:		OCCUPANTS
	MEANS OF E	GRESS		(CBC		EAIIS	KEGUIK	ED	
		WABLE	EACH I	IDTH =		0.2" = 7)	1.9"		
	OCCUPANCY A-3		MAX 250 F	DISTAN T	ICE (W/	SPRIN	(KLERS)		
	B U		300 F 400 F						
PLUMBING CALCULATIONS					CODE	422.1			
	FUNCTION C ASSEMBLY, C	F SPAC	Ε	AREA	LOAD	FACTO	OR	OCCL	JPANT COUNT
	BUSINESS &	SUPPO	RT	4,209				28 O	CC /2 = 14.0 CC /2 = 0.66
	FRACTIONAL								
	A. ASSEMBLY					JTYI	/100 =	0.38	TOILET
	2. WATER C	LOSET	(F):	38 0	CLIDAN	JT Y 1	/25 = /100 =	1 52 1	TOILET
	4. LAVATOR	RY (F):		38 O	CCUPAN	NTX1	/200 = /100=	0.19	SINK
	B. BUSINESS 1. WATER C	LOSET					/50 =		TOILET
	2. WATER C 3. URINALS 4. LAVATOR	:		14 00	CCUPAN	√T X 1,	/15 = /100 = /75 =	0.14	URINAL
	5. LAVATOI C. BARN - U	RY (F):		14 00	CUPAN	IT X 1,	/50=	0.28	SINK
	1. WATER C	LOSET	(M):	1 000		X 1/1	100 = 100 =	0.01	TOILET TOILET
	3. URINALS 4. LAVATOI 5. LAVATOI	RY (M):			CUPANT				S SINK S SINK
	SUM OF ALL 1. WATER O	LOSET	(M):	0.384	0.28+0	0.01 =	0.67 =	1 TOII 3 TOI	LET
	2. WATER C 3. URINAL: 4. LAVATOR			0.384	0.93+0 -0.14+0 -0.18+0	= 0.6	6	1 URII 1 SIN	NAL
	5. LAVATOR 6. DRINKIN 7. SERVICE	RY (F): G FOUI		0.384	0.28+0			1 SIN 1 DRII	
	PROVIDED FI	XTURE	COUNT:						
					URINA	AL:		3	
					.SINKS DRINK SERVI	(FTN:		3 1 HI-L 1	.0
	IN AD	JACEN'	T RESTR	оом е	SUILDING	G: T:	-	4	

LEGEND

#----**>**




"THE BARN" SLOUGH SCHEMAT
WATS
COMN
MULT

23039

LANNING APPL 01/11/20 PLN RESUBMITTAL 05/01/202

CODE ANALYSIS

SET ISSUED:

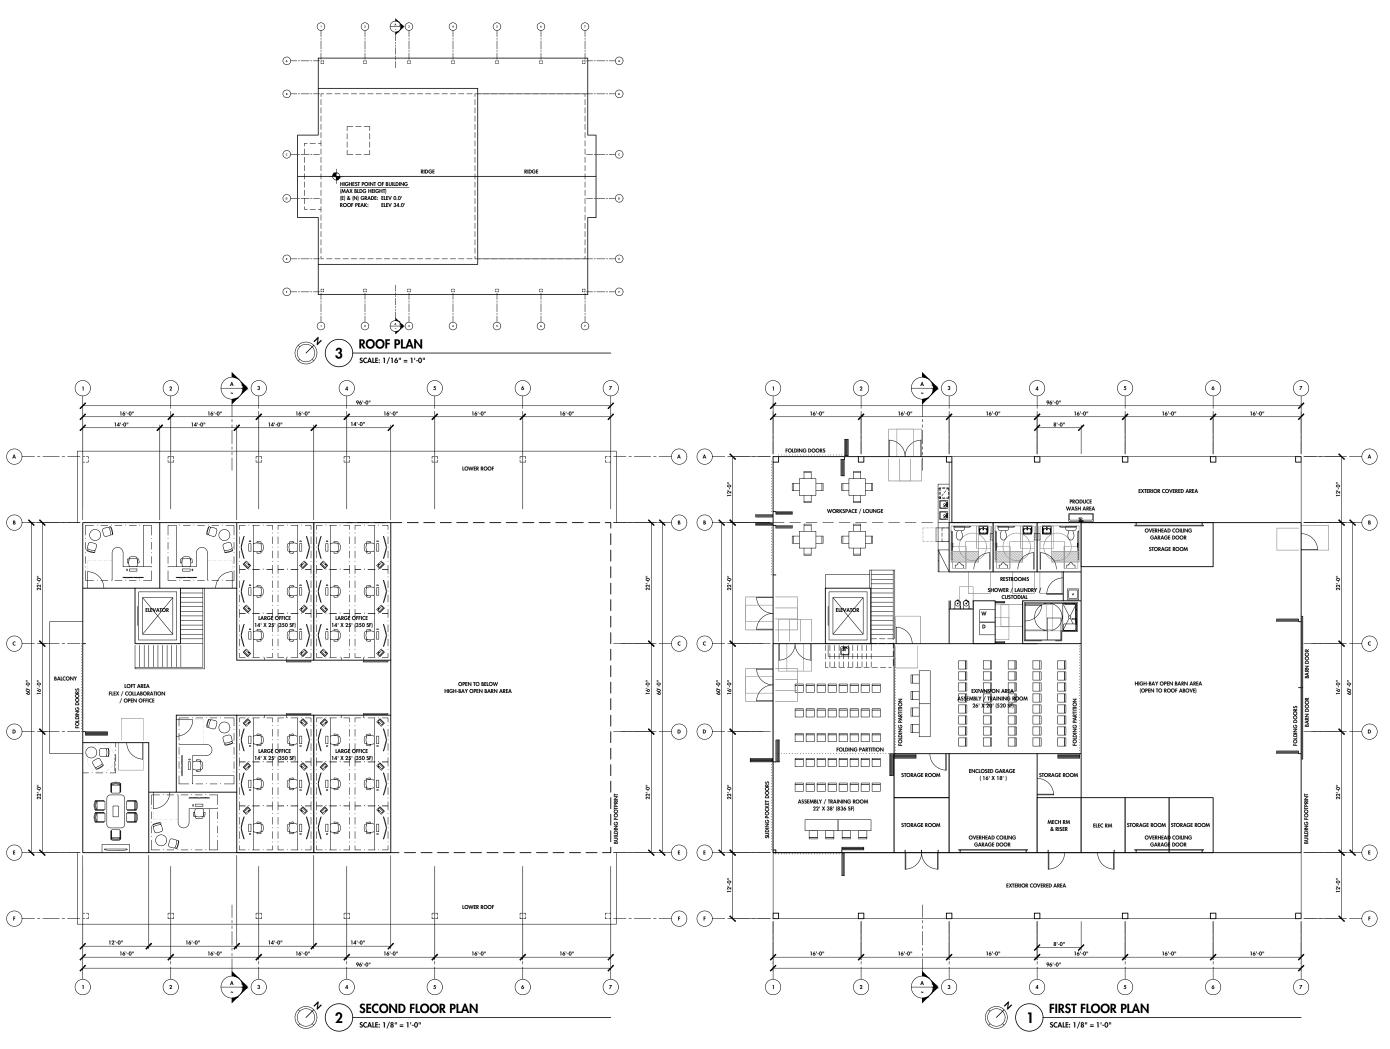

SPECTOR CORBETT
ARCHITECTS
SANTA CRUZ WATSONVILLE
relocating 54 Pennylle
of fice 8 Suite C
9 5 0 6 0 19 5 0 7 6
8 31 - 31 9 - 4 0 4 5
SPECTORCORBETT.COM

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WATSONVILLE SLOUGH FARM COMMUNITY HARVEST PROJECT MULTI-PURPOSE BUILDING - "THE BARN"

SCA PROJECT NUMBER

23039

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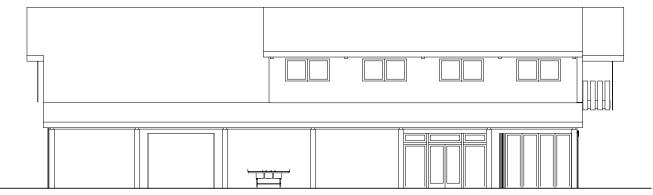
 PLANNING APPL
 01/11/202

 PLN RESUBMITTAL
 05/01/202

SHEET NAME:

FLOOR PLANS

SHEET NUMBER:




NORTH ELEVATION

SCALE: 1/8" = 1'-0"




EAST ELEVATION

SCALE: 1/8" = 1'-0"

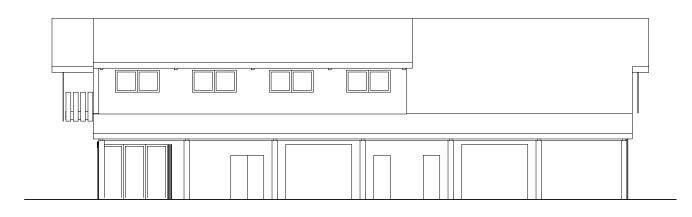


SOUTH ELEVATION

SCALE: 1/8" = 1'-0"

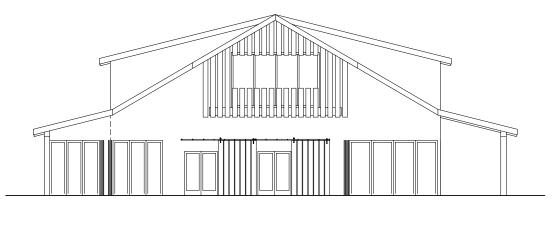

WEST ELEVATION

SCALE: 1/8" = 1'-0"

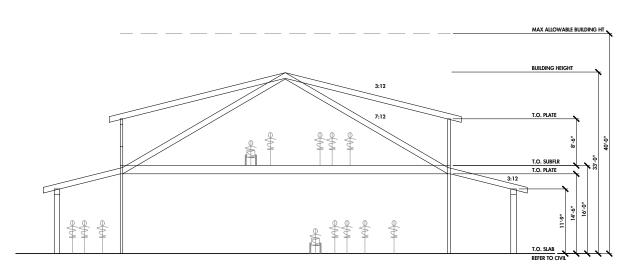

8UILDING SECTION - A

SCALE: 1/8" = 1'-0"



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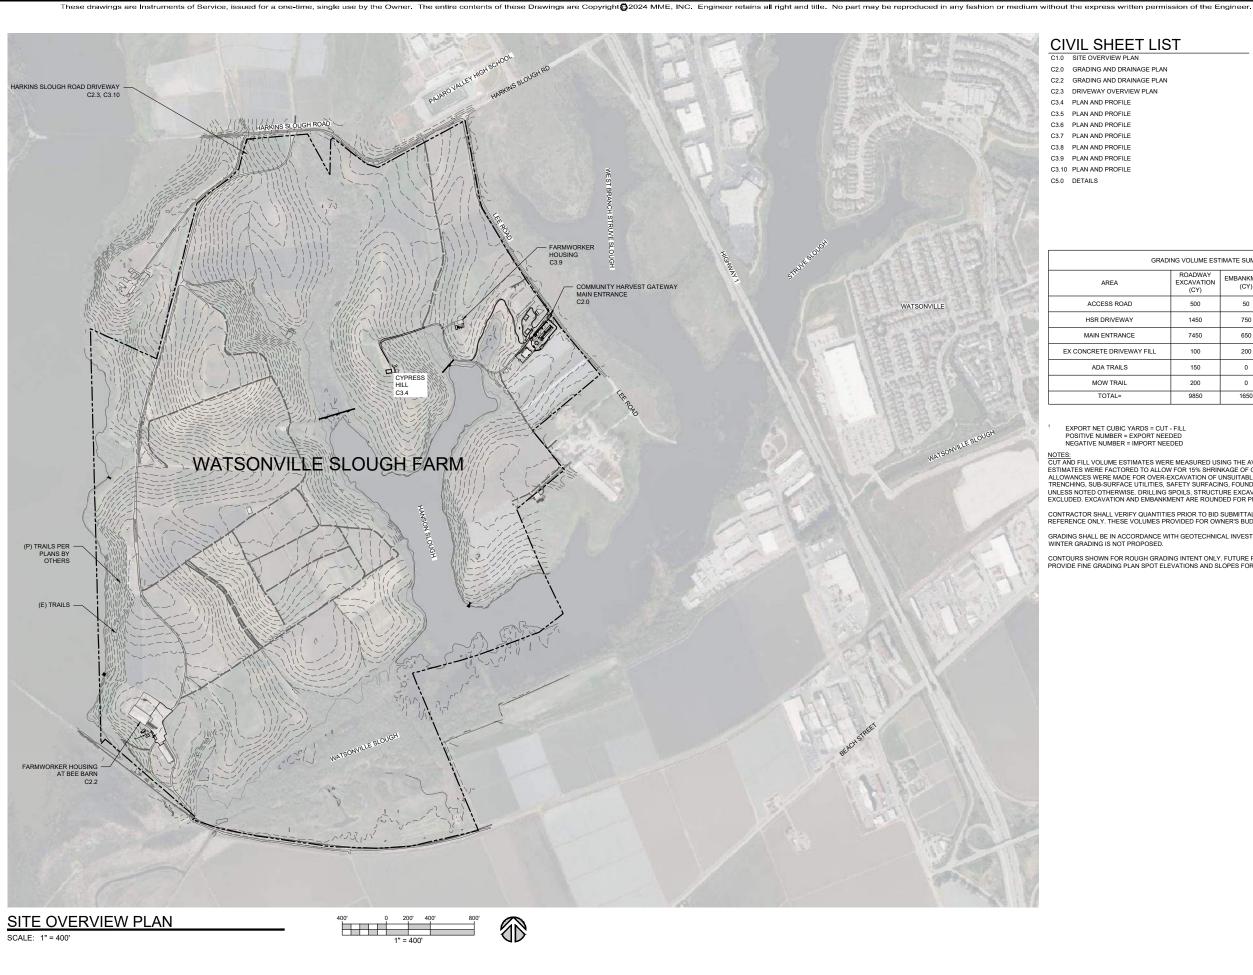
WATSONVILLE SLOUGH FARM
COMMUNITY HARVEST PROJECT
MULTI-PURPOSE BUILDING - "THE BARN"

SCA PROJECT NUMBER: 23039

SET ISSUED:
PLANNING APPL 01/11/20
PLN RESUBMITTAL 05/01/20

BUILDING
ELEVATIONS &
SECTION

A300



CIVIL SHEET LIST

C2.0 GRADING AND DRAINAGE PLAN

C2.2 GRADING AND DRAINAGE PLAN

C2.3 DRIVEWAY OVERVIEW PLAN

C3.5 PLAN AND PROFILE

C3.7 PLAN AND PROFILE

GRADING VOLUME ESTIMATE SUMMARY									
AREA	ROADWAY EXCAVATION (CY)	EMBANKMENT (CY)	15% COMPACTION (CY)	EXPORT (CY) ¹					
ACCESS ROAD	500	50	8	443					
HSR DRIVEWAY	1450	750	113	588					
MAIN ENTRANCE	7450	650	98	6703					
EX CONCRETE DRIVEWAY FILL	100	200	30	-130					
ADA TRAILS	150	0	0	150					
MOW TRAIL	200	0	0	200					
TOTAL=	9850	1650		7953					

EXPORT NET CUBIC YARDS = CUT - FILL POSITIVE NUMBER = EXPORT NEEDED NEGATIVE NUMBER = IMPORT NEEDED


NOTES:
CUT AND FILL VOLUME ESTIMATES WERE MEASURED USING THE AVERAGE END AREA METHOD. GRADING ESTIMATES WERE FACTORED TO ALLOW FOR 15% SHRINKAGE OF ON-SITE MATERIALS WHEN USED IN FILLS. NO ALLOWANCES WERE MADE FOR OVER-EXCAVATION OF UNSUITABLE MATERIALS, CONTAMINATED SOILS, TRENCHING, SUB-SURFACE UTILITIES, SAFETY SURFACING, FOUNDATIONS, STRUCTURES OR BUILDINGS UNLESS NOTED OTHERWISE. DRILLING SPOILS, STRUCTURE EXCAVATION, AND STRUCTURE BACKFILL EXCLUDED. EXCAVATION AND EMBANKMENT ARE ROUNDED FOR PRELIMINARY ESTIMATING PURPOSES.

CONTRACTOR SHALL VERIFY QUANTITIES PRIOR TO BID SUBMITTAL. CROSS SECTIONS ARE SHOWN FOR REFERENCE ONLY. THESE VOLUMES PROVIDED FOR OWNER'S BUDGET ESTIMATING ONLY.

GRADING SHALL BE IN ACCORDANCE WITH GEOTECHNICAL INVESTIGATION BY PCE, DATED OCTOBER 2020. WINTER GRADING IS NOT PROPOSED.

CONTOURS SHOWN FOR ROUGH GRADING INTENT ONLY. FUTURE PHASE CONSTRUCTION DOCUMENTS WILL PROVIDE FINE GRADING PLAN SPOT ELEVATIONS AND SLOPES FOR FINISHED GRADES.

C1.0

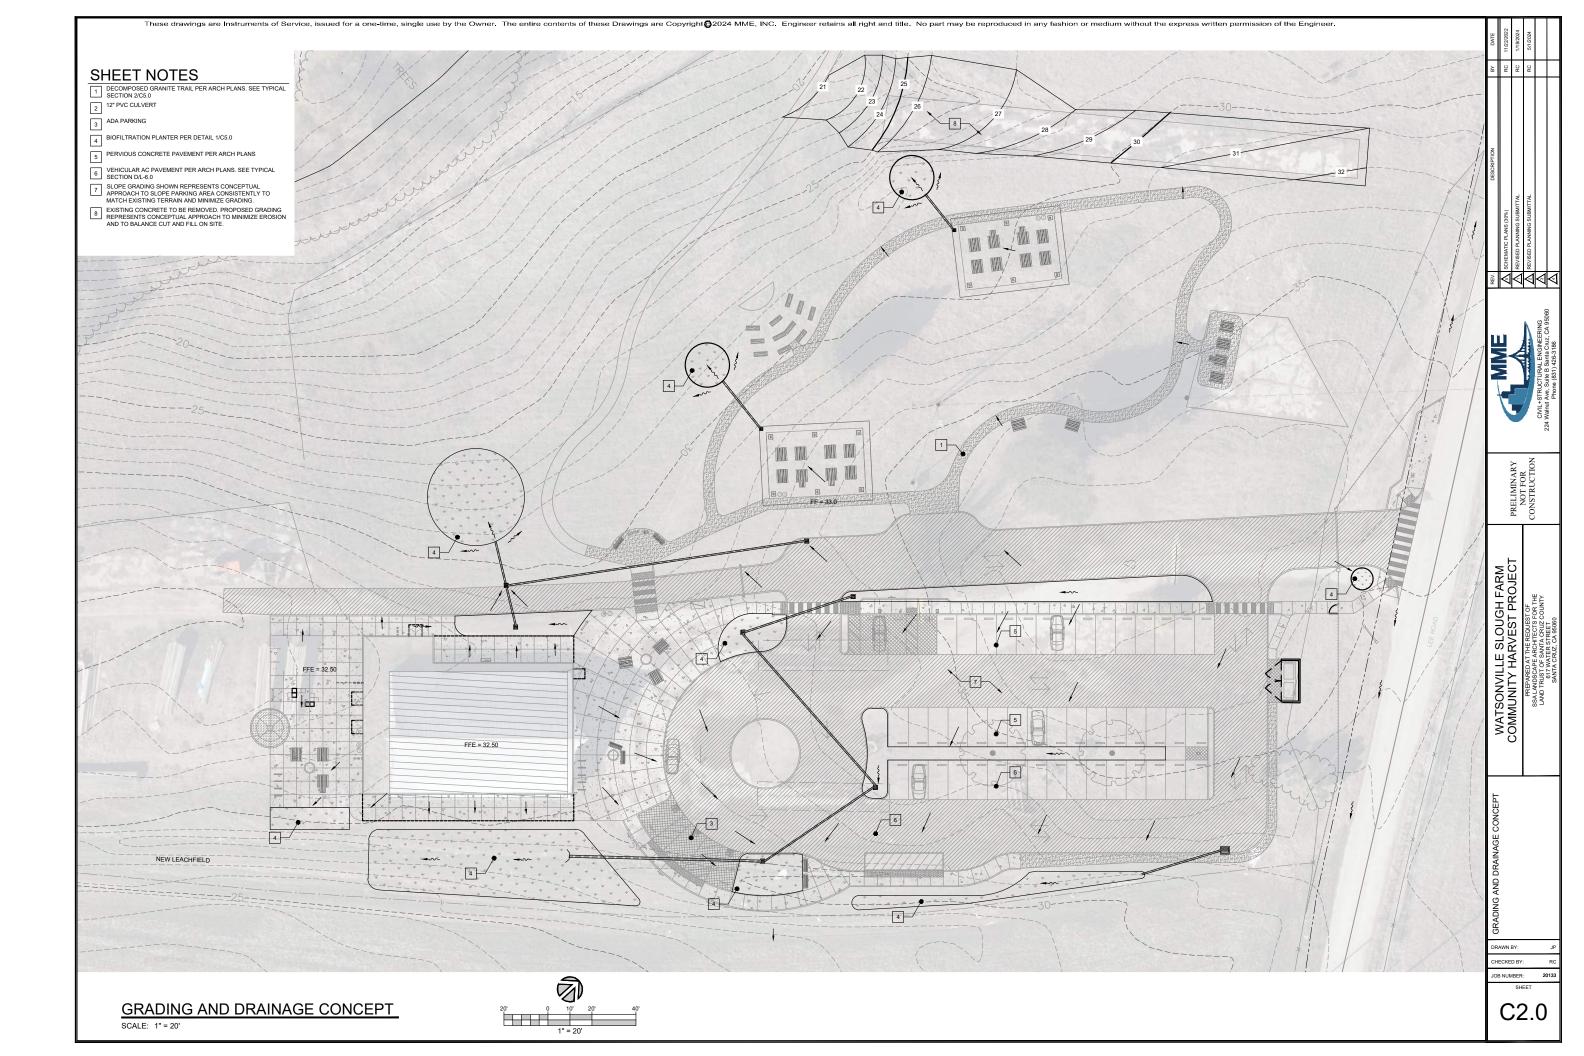



SHEET NOTES

2 12" PVC CULVERT

3 ADA PARKING

4 BIOFILTRATION PLANTER PER DETAIL 1/C5.0

5 PERVIOUS CONCRETE PAVEMENT PER ARCH PLANS


VEHICULAR AC PAVEMENT PER ARCH PLANS. SEE TYPICAL SECTION D/L-6.0

SECTION DI.6.0

SLOPE GRADING SHOWN REPRESENTS CONCEPTUAL
APPROACH TO SLOPE PARKING AREA CONSISTENTLY TO
MATCH EXISTING TERRAIN AND MINIMIZE GRADING.
EXISTING CONCRETE TO BE REMOVED. PROPOSED GRADING
REPRESENTS CONCEPTUAL APPROACH TO MINIMIZE EROSION
AND TO BALANCE CUT AND FILL ON SITE.

PRELIMINARY NOT FOR CONSTRUCTION

C2.2

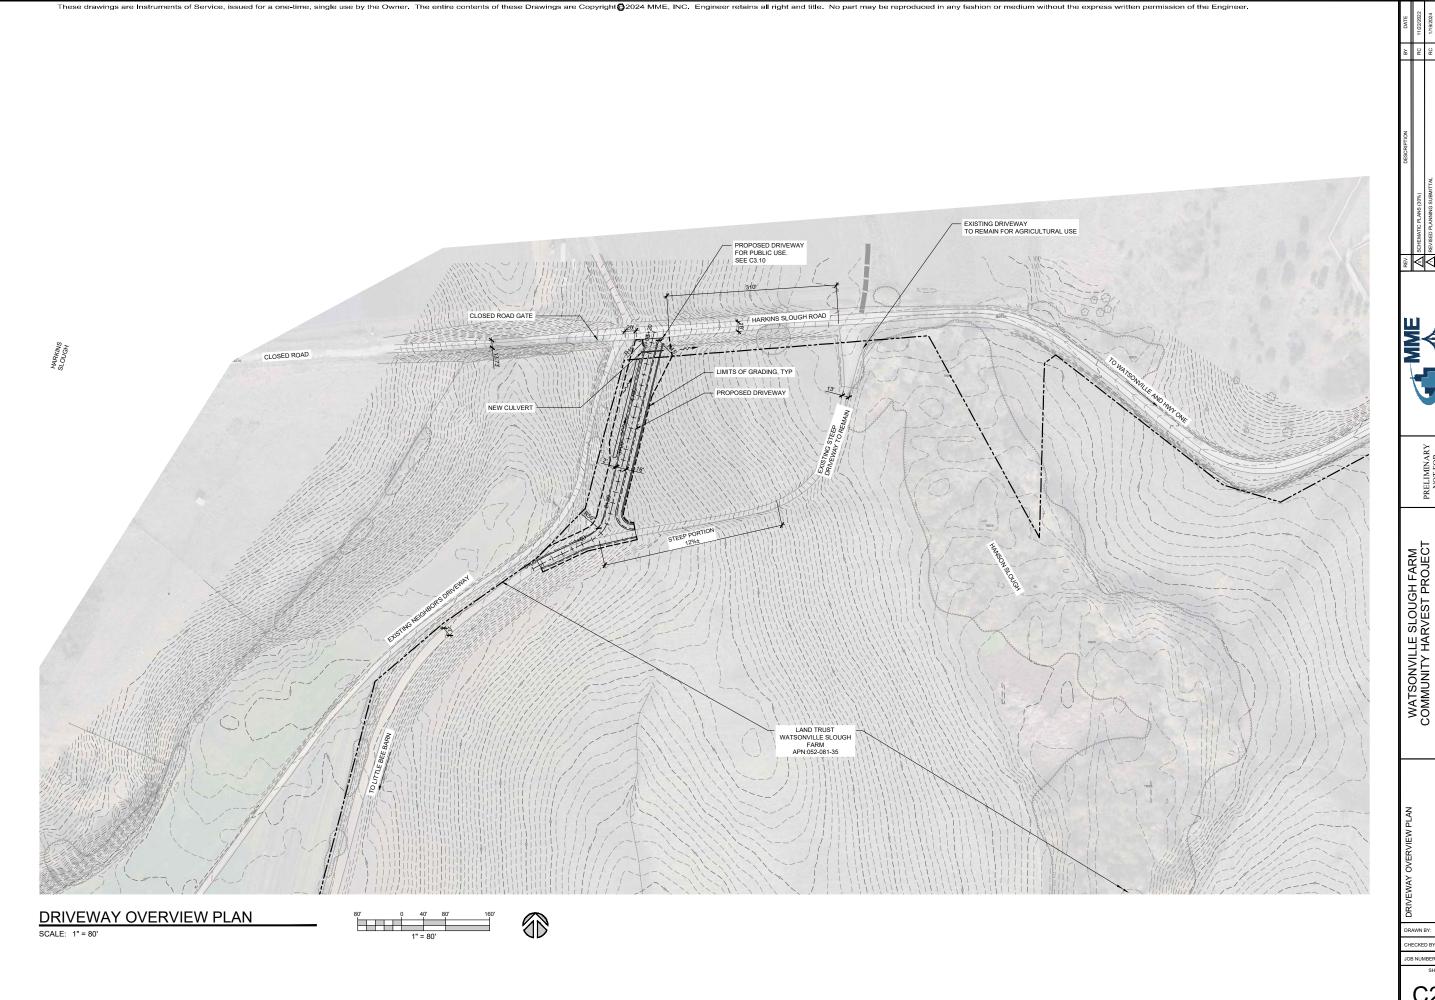






PRELIMINARY NOT FOR CONSTRUCTION


JOB NUMBER:


C2.3

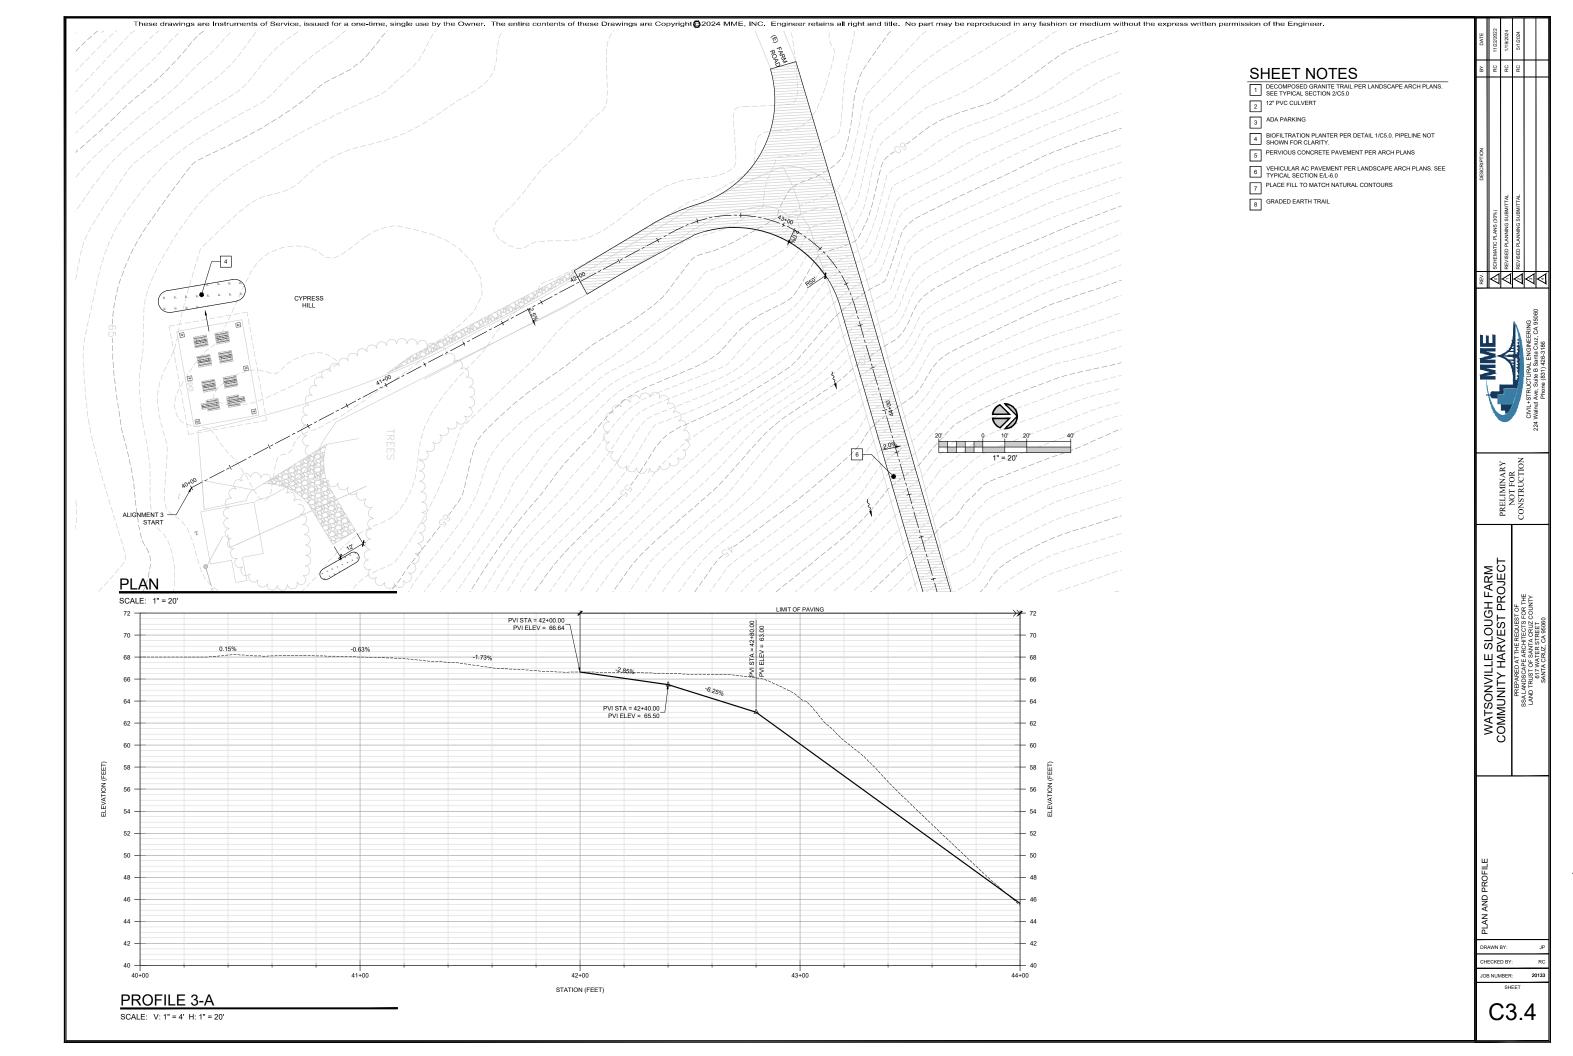


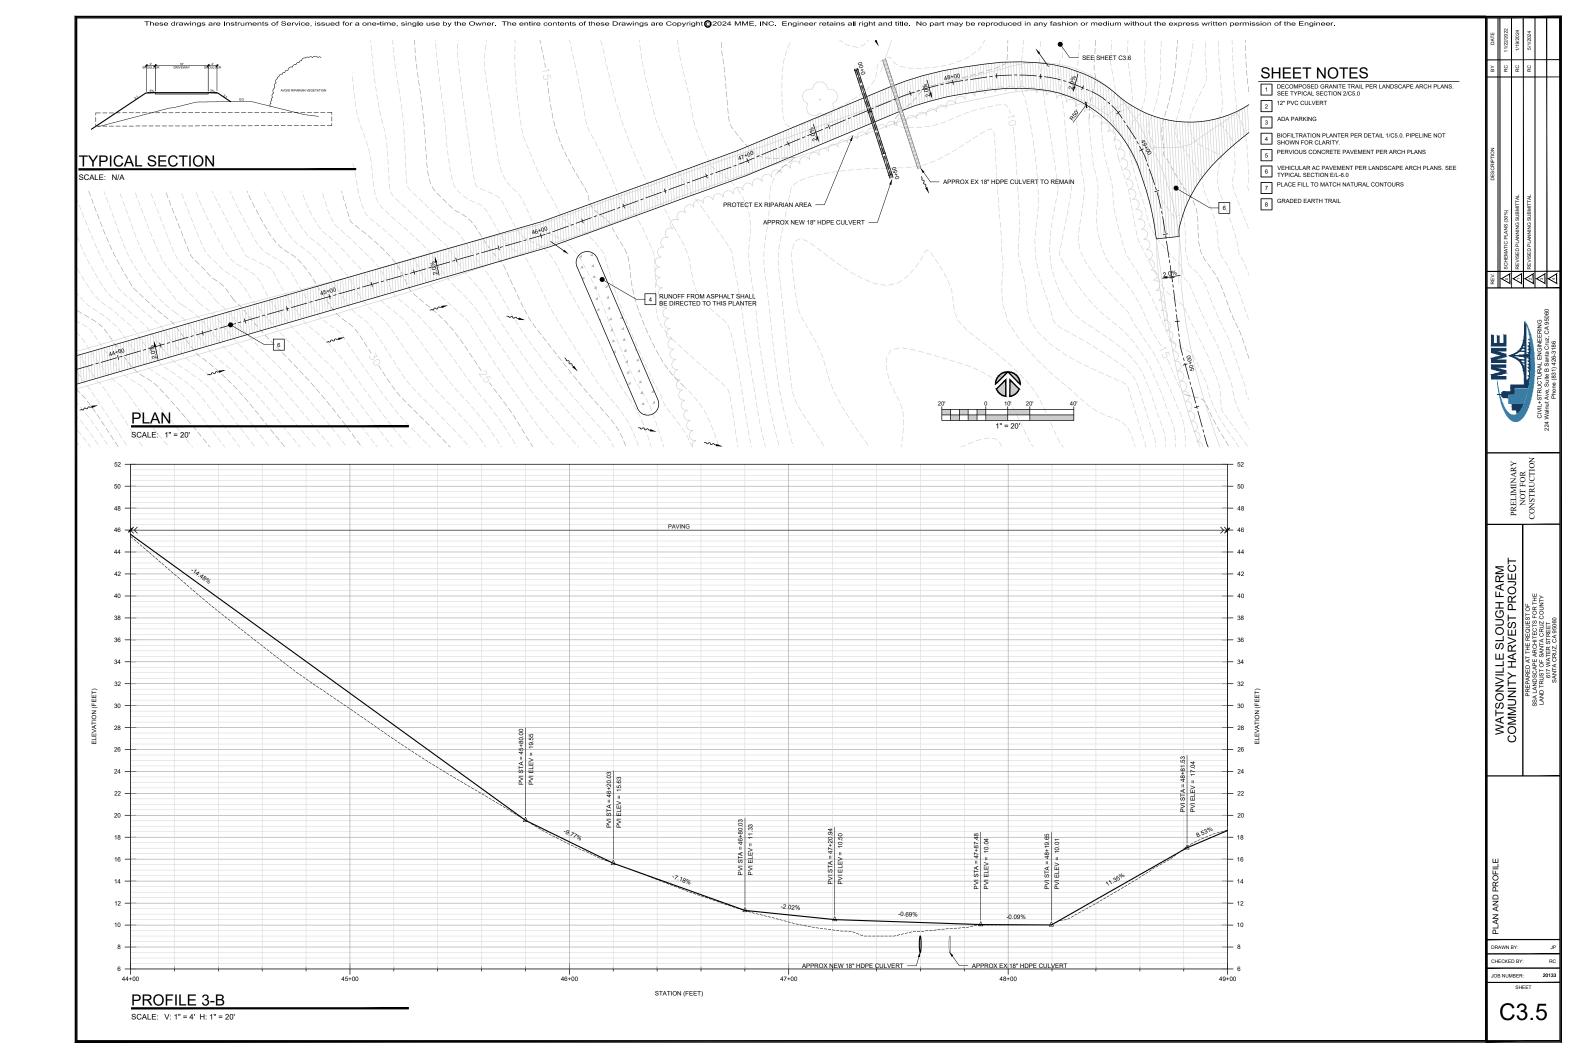

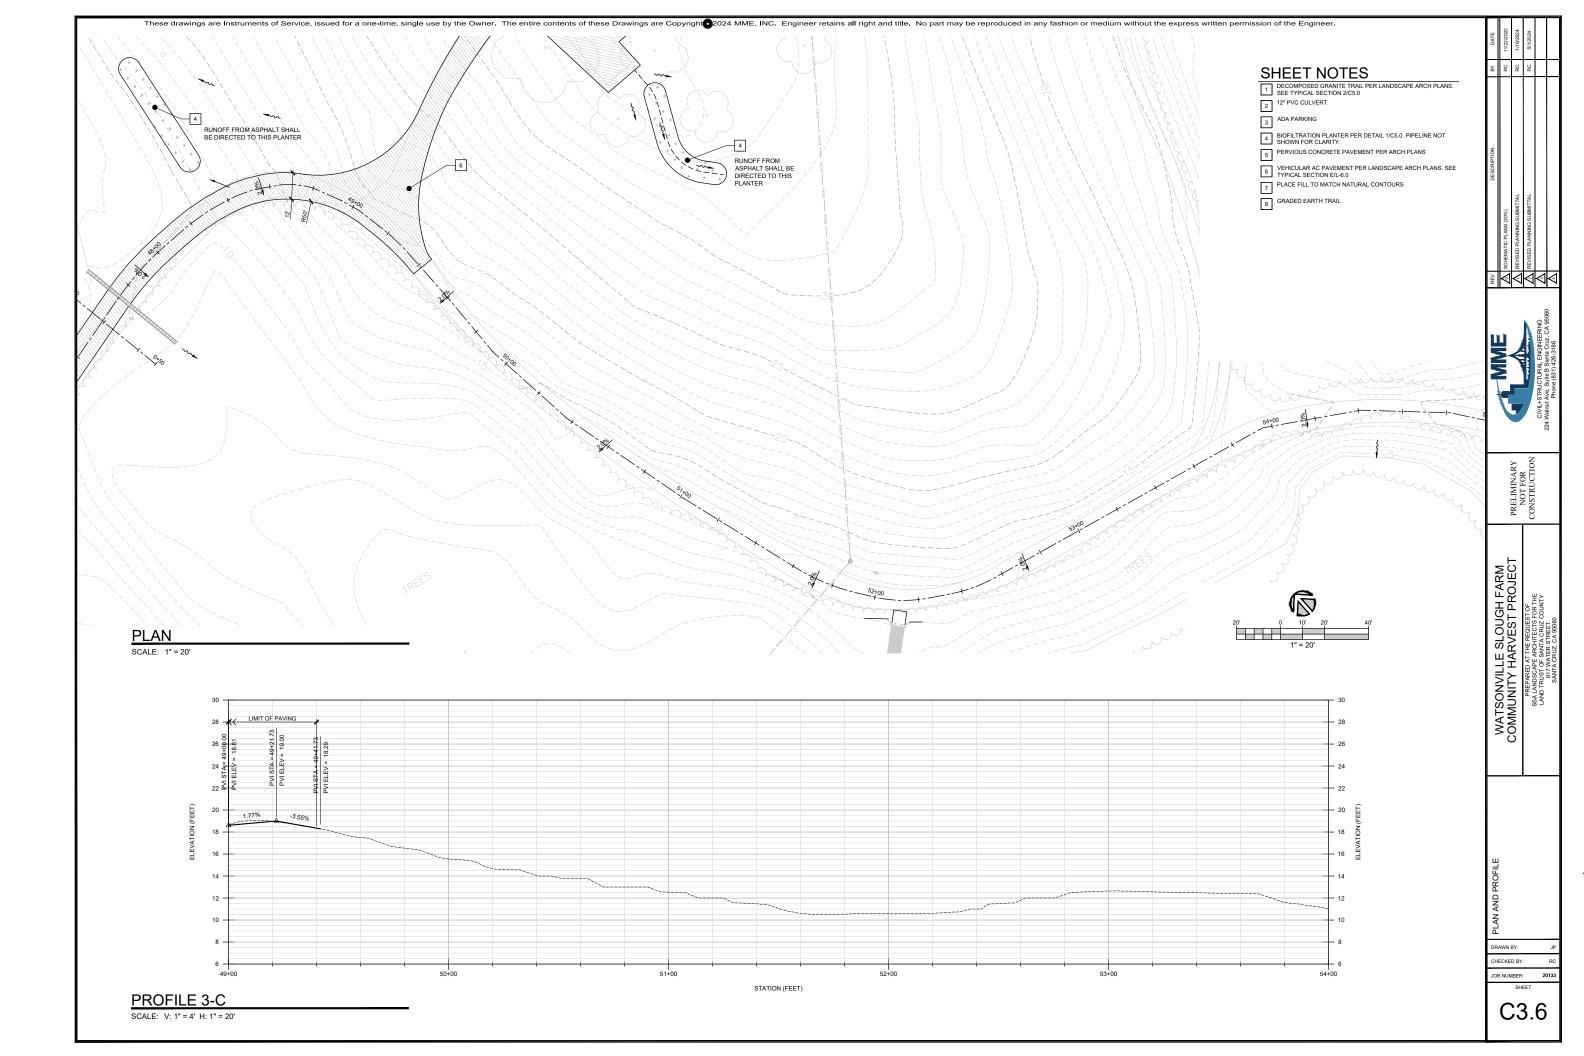

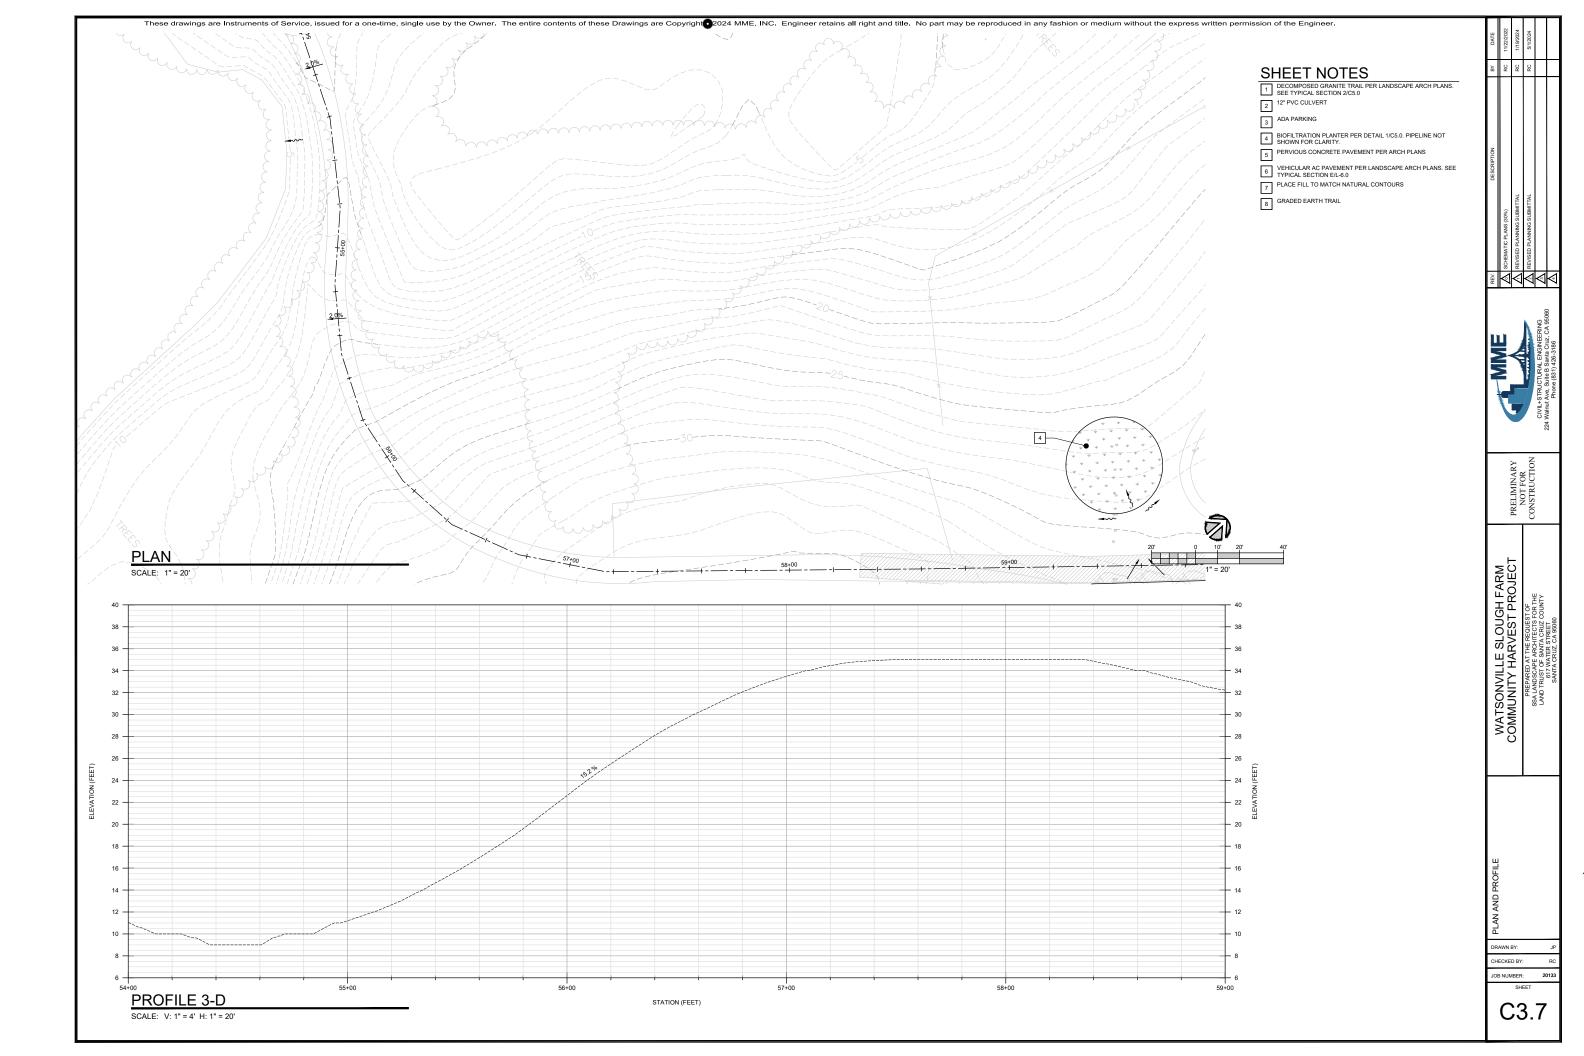

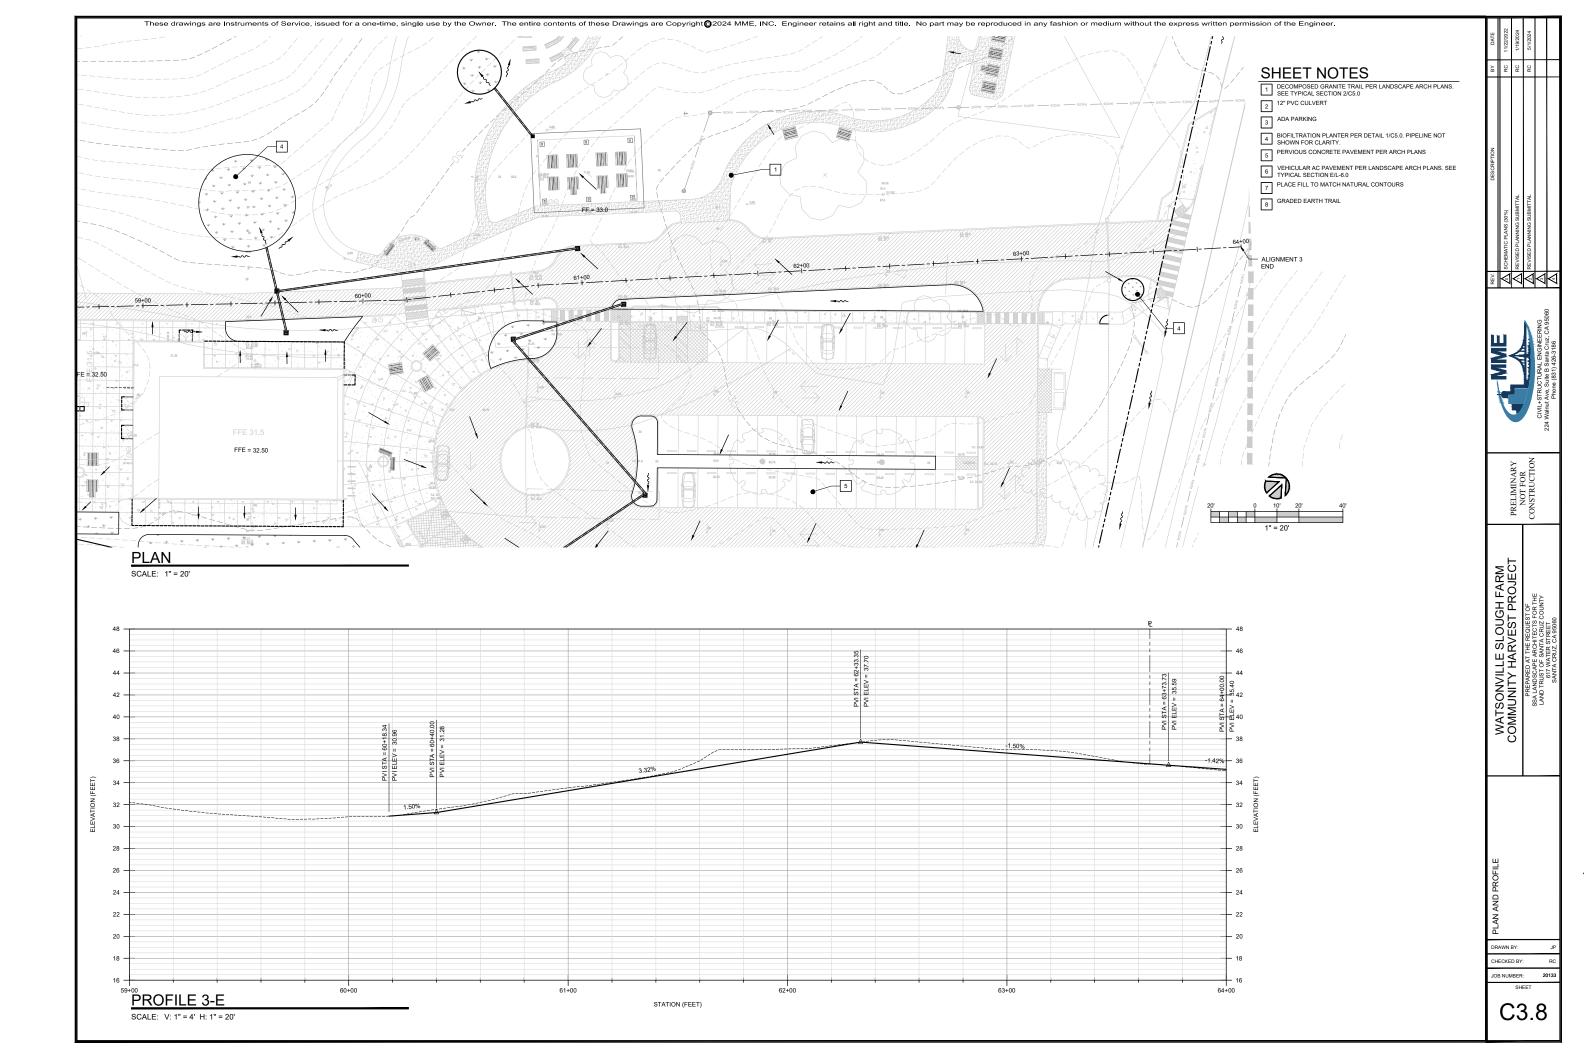

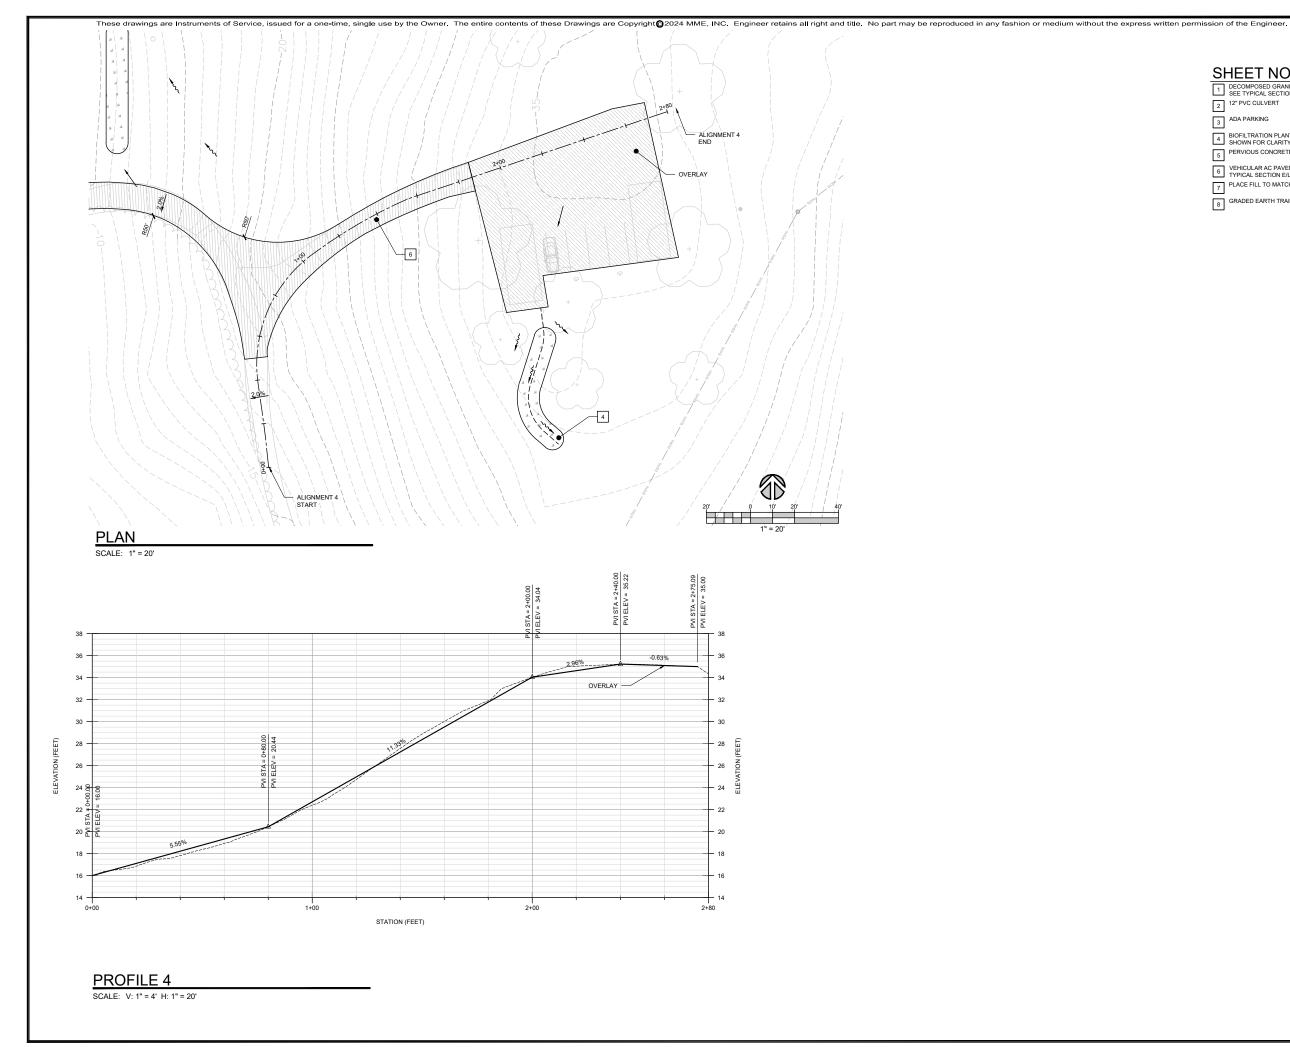

SHEET NOTES

DECOMPOSED GRANITE TRAIL PER LANDSCAPE ARCH PLANS.
 SEE TYPICAL SECTION 2/C5.0
 12" PVC CULVERT

3 ADA PARKING

4 BIOFILTRATION PLANTER PER DETAIL 1/C5.0. PIPELINE NOT SHOWN FOR CLARITY.

5 PERVIOUS CONCRETE PAVEMENT PER ARCH PLANS

6 YEHICULAR AC PAVEMENT PER LANDSCAPE ARCH PLANS. SEE TYPICAL SECTION E/L-8.0
7 PLACE FILL TO MATCH NATURAL CONTOURS

8 GRADED EARTH TRAIL



PRELIMINARY NOT FOR CONSTRUCTION

WATSONVILLE SLOUGH FARM COMMUNITY HARVEST PROJECT

JOB NUMBER:

C3.9

